



EXISTING BASEMENT PLAN

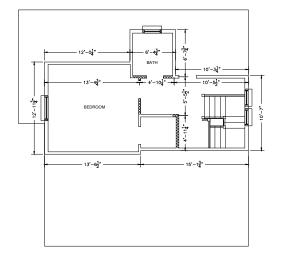

EXISTING ATTIC PLAN

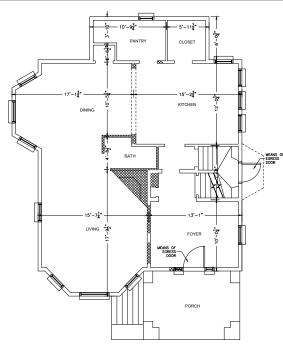


EXISTING FIRST FLOOR PLAN

GENERAL NOTES

- All work shall conform to Massachusetts Building Code and all Federal, State and City of Boston laws, codes and regulations as each may apply.
- All existing conditions must be verified in field. If discrepancies are found, they have to be reported to the Engineer prior to start of work. Omissions or conflicts between the various elements of the working drawings and/or the specifications shall be brought to the attention or the Engineer prior to the start of such work.
- The contractor shall be responsible for coordinating the scheduling and work of all trades and shall check all dimensions. All discrepancies shall be called to the attention of the Engineer and shall be resolved prior to proceeding with
- The Contractor shall supervise and direct the work and shall be solely responsible for the construction means, methods, techniques, sequences and procedures, including but not limited to bracing and sharing.
- The Contractor agrees that in accordance with generally accepted construction practices, the Contractor shall assume sale and complete responsibility for the job site conditions during the course of construction, including the safety of all persons and property, and that this requirement shall disply continuously and not be limited to normal working hours.
- All work shall be performed in a first class and workmanlike manner in conformity with the plans and specifications, and shall be in good usable condition at the completion of the Project.
- The Contractor shall field verify all existing conditions, utility locations and structure placement, prior to start of the
 work fine Contractor will observe air possible precoutions to avoid damage to same. Any damage to existing structures and
 utilities, whether shaven or not on the drawings, shall be regulated or replaced of the Contractor's appears.
- Prior to bidding the work the Contractor shall visit the site and thoroughly satisfy himself as to the actual conditions
 and quantities, if any. No claim agains the Owner or Engineer will be allowed for any excess or deficiency therein, actual or
 relative.

10. Contractor is responsible for all demolition and relocation works, if any.

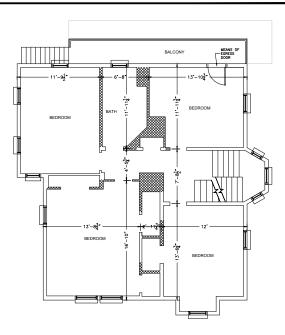

EXISTING SECOND FLOOR PLAN

ALL DIMENSIONS AND ALL EXISTING CONDITIONS ARE SHOWN TO THE BEST OF PRESENT KNOWLEDGE AND MUST BE VERHIED IN FIELD. ALL DISCREPANCIES SHALL BE CALLED TO THE ATTENTION OF THE ENGINEER AND SHALL BE RESOLVED PRIOR TO PROCEEDING WITH THE WORK.

POODON WALLS TO BE REMOVED

VZZZZZI NEW WALLS

DATE REVISION

White legit rights including, but not limited to, copyright not design potent rights, in the designs, and legit rights including, but not limited to, copyright not design potent rights, in the designs, not be used or reused in whole or in port, except in connection with this project, without they not be readed in whole or in port, except in connection with this project, without they not recommend to the project of the proj

EXISTING FLOOR PLANS


4 WALLNGFORD ROAD, BOSTON, MASSACHUSETTS


RAV & Assoc., Inc. 21 HIGHLAND AVENUE NEEDHAM, MASSACHUSETTS 02494 TELEPHONE: (781) 449-8200 FAX: (781) 449-8203

SCALE: 1/4"=1'-0"

DESIGNED BY: I.M. 1

APPROVED: R.A.V. DRAWN BY: E.F. 10/11/2021 CHECKED BY: R.A.V

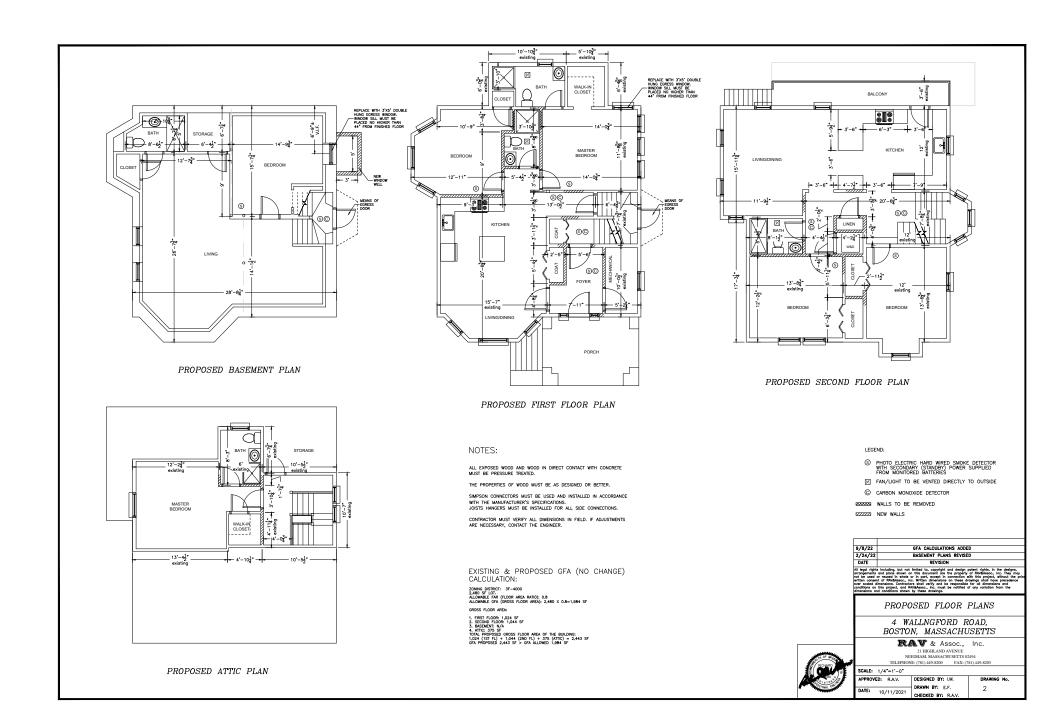

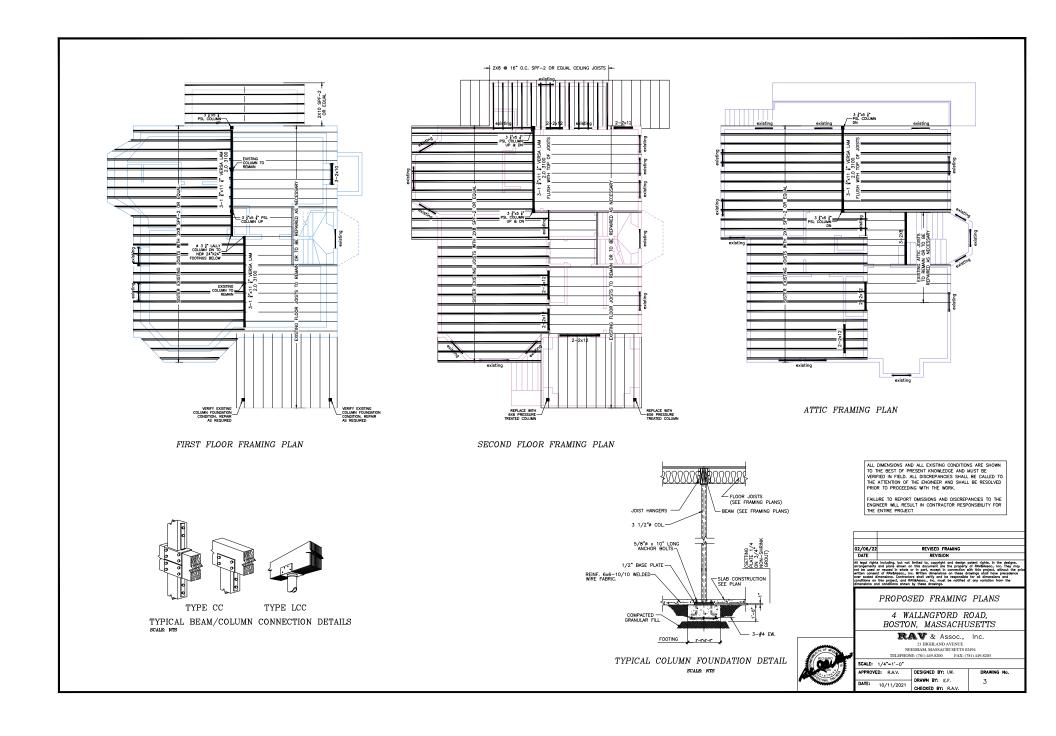

NOTES:

CARPENTRY

ALL ROUGH CARPENTRY SHALL PRODUCE JOINTS TRUE, TIGHT, WITH ALL MEMBERS ASSEMBLED IN ACCORDANCE WITH THE DRIVAINGS AND WITH ALL PERTINENT CODES AND RECULATIONS.
CAREFULLY SELECT ALL MEMBERS. SELECT INDIVIDUAL PIECES SO THAT KNOTS AND EFFORTS WILL NOT INTERFERE WITH PLYCING BOLTS OF POPER HUMANG ON ANIVANG CONNECTIONS.
UNBERS MAY BE RESCELTED BY THE EMBERS, WHETHER ON THIS THE SHE SHEALED, FOR DECESSED WARP, THIST, DON, CROCK, MUDDE, PANULS, OR MODE, A SWELL AS FOR MEMORPHS.

LUMBER MY EF REACTED BY THE BORNER, WHETHER OR NOT IT HAS BEEN INSTALLED, FOR DECISION WAP, TWIST, BOW, CROCK, MILDEY, FUNGUIS, OR MOLD, AS WILL AS FOR IMPROPER CUTTIN ON FITTING.

ON FITTING.

ON FITTING.

ON FITTING, ALL WOOLD, MISS, SHORT STUDY, FAMILIES, AND WALKE GROWDER, M., OR IN CONFINCT WITH CONCRETE.


FIRST ALL WOOLD EST HAIT THO FEET MANOR FRINGHED AND OR BY SPRAYING WITH THE PRESENABLE TO A MINIMAN DESTINCE OF SX ROHES FROM THE EDGS. PERFORM ALL THEATMENT IN STRICT COORDINANCE WITH MANUFACTURES'S SPECIFICATIONS.

IN ADDITION TO ALL STHAN THO FEET MANOR FORMAN FORMAN FOR STRICT HIS PROPERTY OF THE PROPER

CERCIS DOPT (TEXT.


CERCIS DOSCOPICE DETERMEN LOST AT ALL PORTS OF SUPPORT NO WHEREOER SHEATHING OF PLOPING IS DESCONTINUOUS.

MADE ALL STUDS SHEEL LINGTH, UNDELVED, NOO PLATFORM THANDE, PRIMED, ALL CORRESS AND INTERECENCION WITH HIRED OF MORE THAN 1 PROMISE DEADNEY FOR WALL PROMISE AND ALL RECORDED BEARING FOR WALL PROMISE AND THE PLANE OF SUPPLACES OF ADJUSTIC FRAMING AND REAL CORRESS AND ALL PROMISES OF ADJUSTIC FRAMING AND REAL CORRESS AND ALL PROMISES OF ADJUSTIC WITH ALL CORRESS AND ALL PROMOSE MOST OF THE PLANE OF SUPPLACES OF ADJUSTIC FRAMING AND REAL CORRESS AND ORDERS MOST OF THE PLANE OF SUPPLACES OF ADJUSTIC FRAMING AND REAL CORRESS AND ORDERS MOST OF THE PLANE OF SUPPLACES OF ADJUSTIC FRAMING AND REAL CORRESS AND ADDUST MOST OF THE PLANE OF SUPPLACES OF ADJUSTIC FRAMING AND REAL CORRESS AND ADDUST MOST OF THE PLANE OF SUPPLACES OF ADJUSTIC FRAMING AND REAL CORRESS AND ADDUST MOST OF THE PLANE OF SUPPLACES OF ADJUSTIC FRAMING AND REAL CORRESS AND ADDUST MOST OF THE PLANE OF SUPPLACES OF ADJUSTIC FRAMING AND REAL CORRESS AND ADDUST MOST OF THE PLANE OF SUPPLACES OF ADJUSTIC FRAMING AND REAL CORRESS AND ADDUST MOST OF THE PLANE OF SUPPLACES OF ADJUSTIC FRAMING AND REAL CORRESS AND ADDUST MOST OF THE PLANE OF SUPPLACES OF ADJUSTMENT AND ADDUST AND ADDUST MOST OF THE PLANE OF SUPPLACES OF ADJUSTMENT AND ADDUST ADDUST AND ADDUST ADDUST AND ADDUST ADD

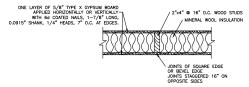

ONE HOUR FIRE SEPARATION WALL TYPICAL DETAIL UL U305 SCALE: NTS


NOTE: SCALE: NIS ONE HOUR SEPARATION WALL MUST BE INSTALLED BETWEEN UNITS AND BETWEEN COMMON AREAS AND UNITS.

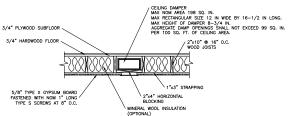


ONE HOUR FIRE SEPARATION FLOOR/CEILING ASSEMBLY TYPICAL DETAIL

UL 263 SCALE: NTS


NOTE: SCALE: NTS
ONE HOUR SEPARATION ASSEMBLY MUST BE INSTALLED
BETWEEN UNITS AND BETWEEN COMMON AREAS AND UNITS.

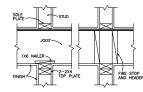


PARTITIONS PERPENDICULAR TO JOISTS BEARING INTERIOR PARTITIONS TYPICAL DETAILS

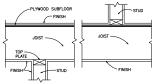

NO PARTITION ABOVE PARTITIONS PERPENDICULAR TO JOISTS NONBEARING INTERIOR PARTITIONS TYPICAL DETAILS

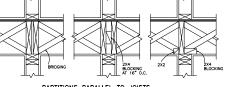

PARTITIONS PARALLEL TO JOISTS

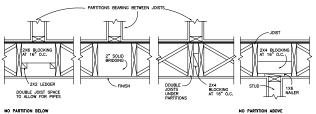

PARTITIONS PARALLEL TO JOISTS

NOTE: COLUMNS OR BUILD-UP STUDS MUST BE INSTALLED UNDER EACH BEAM AND HEADER SUPPORT (TYP.) WHETHER IT IS SHOWN OR NOT ON THE PLANS. THESE COLUMNS MUST CARTY THE LOAD DOWN TO THE FOUNDATION OR BEAM BELOW.

DATE

TYPICAL DETAILS

4 WALLNGFORD ROAD, BOSTON, MASSACHUSETTS

RAV & Assoc., Inc. 21 HIGHLAND AVENUE NEEDHAM, MASSACHUSETTS 02494

SCALE: 1/4"=1'-0" APPROVED: R.A.V. 10/11/2021

DESIGNED BY: I.M. DRAWN BY: E.F. 4 CHECKED BY: R.A.V

NO PARTITION BELOW