

11/2/2022

Mr. Michael Parker Boston Conservation Commission City of Boston Environmental Department 1 City Hall Square, Room 709 Boston, Massachusetts 02201

Re: Sargent's Wharf Water Taxi In-Kind Float Replacement

Sargent's Wharf, Boston, MA

Project/Proposal No. 500331.0000.0000

Dear Mr. Parker,

Enclosed please find a copy of the Notice of Intent (NOI) application for the Sargent's Wharf Water Taxi In-Kind Float Replacement Project at Sargent's Wharf in Boston, MA. TRC Environmental Corporation (TRC) has prepared this NOI application on behalf of Pilot House Properties (Pilot House) for compliance with the Massachusetts Wetlands Protection Act and the Boston Wetlands Ordinance. A copy of the complete NOI application has been submitted to the Massachusett Regional Office and the Massachusetts Division of Marine Fisheries North Shore Office.

If you have any questions, please contact me at 781-419-7730 or hfisher@trccompanies.com. Thank you for your attention to this matter.

Sincerely,

TRC ENVIRONMENTAL CORPORATION

Heidi Fisher

Environmental Scientist

C: Marcia Gordon, Pilot House Properties

MassDEP Northeast Regional Office

Massachusetts Division of Marine Fisheries - North Shore Office



City of Boston Conservation Commission Filing Fee Calculation

- Pursuant to the City of Boston Title 14 Section 450 requires the following fees payable to the City of Boston for Notice of Intent processing:
- \$25.00 for projects with the fair cost of \$1,000.00 or less.
- \$50.00 for projects with the fair cost of more than 1,000.00 but not more than \$50,000.00.
- \$75.00 for projects with a fair cost of more than 50,000.00 but not more than \$100,000.00.
- For projects with a fair cost of more than 100,000.00 the fee shall be .075% of the fair cost provided, however, in no case shall the fee be more than \$1,500.00.

 Project cost approximately \$185,000.

The Boston Conservation Commission has adopted **additional fees under the Ordinance**. Applicants submitting applications under the Ordinance must also pay a fee as determined by the fee schedule as follows:

Notice of Intent

- Category 1
 - o \$100
- Category 2
 - o \$300
- Category 3
 - o \$550
- Category 4
 - o \$750
- Category 5 (Construction, reconstruction, repair or replacement of docks)
 - \$4 per linear foot (The total fee shall not be less than \$100)
 - $$4 ext{ per linear foot x 30 (width of the dock)} = 120

Total fee = \$1,500 (Title 14 Section 450) + \$120 (Additional fee by Resource Area - Category 5)

Total fee = \$1,620.00



Notice of Intent

Sargent's Wharf Water Taxi In-Kind Float Replacement

November 2022


Sargent's Wharf Boston, MA

Prepared For:

Pilot House Properties, LLC Pilot House – Lewis Wharf Boston, MA 02110

Prepared By:

TRC 404 Wyman Street, Suite 375 Waltham, Massachusetts 02451

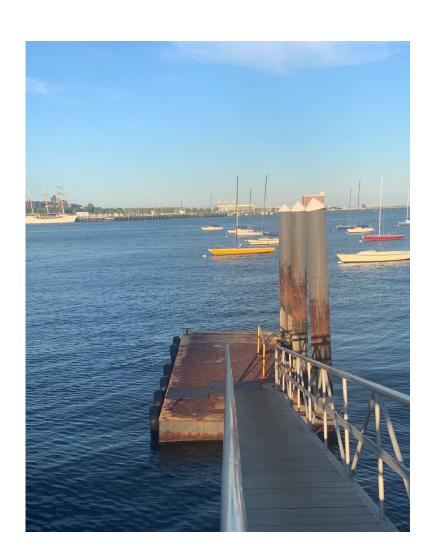



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WPA Form 3 - Notice of Intent



Massachusetts Department of Environmental ProtectionBureau of Resource Protection - Wetlands

WPA Form 3 – Notice of Intent

Massachusetts Wetlands Protection Act M.G.L. c. 131, §40

Prov	rided by MassDEP:
	MassDEP File Number
	Document Transaction Number

City/Town

Important:

When filling out forms on the computer, use only the tab key to move your cursor - do not use the return key.





Note: Before completing this form consult your local Conservation Commission regarding any municipal bylaw or ordinance.

1 Eastern Avenue	Boston	02110
a. Street Address	b. City/Town	c. Zip Code
Latituda and Langituda	42.364510	-71.049043
Latitude and Longitude:	d. Latitude	e. Longitude
	0303037000	
f. Assessors Map/Plat Number	g. Parcel /Lot Nu	mber
Applicant:		
Marcia	Gordon	
a. First Name	b. Last Name	
Pilot House Properties LLC		
c. Organization		
32 Atlantic Avenue		
d. Street Address		00440
Boston	MA f. State	02110
e. City/Town		g. Zip Code
(617) 854-3130 h. Phone Number i. Fax Numb	ber Marcia.Gordon@ j. Email Address	pilotriouse.com
a. First Name	b. Last Name	
Boston Planning and Developmer c. Organization		
Boston Planning and Developmer c. Organization One City Hall, 9th Floor		
Boston Planning and Developmer c. Organization	nt Agency (BPDA)	
Boston Planning and Development c. Organization One City Hall, 9th Floor d. Street Address Boston	nt Agency (BPDA) MA	02201
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Boston Planning and Developmer c. Organization One City Hall, 9th Floor d. Street Address Boston e. City/Town (617) 722-4300	nt Agency (BPDA) MA f. State william.j.eppersor	02201 g. Zip Code
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Massachusetts Department of Environmental ProtectionBureau of Resource Protection - Wetlands

WPA Form 3 – Notice of Intent

Massachusetts Wetlands Protection Act M.G.L. c. 131, §40

Provided by MassDEP:
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City/Town

Α.	General	Information	(continued)

Coastal Resource Areas).

Α.	General Information (continued)	
6.	General Project Description:	
	Pilot House proposes to replace the existing Sarger float and guide piles of the same size within the existing in-kind replacement of both the pile-held float and the pile-he	sting footprint. The proposed design includes the
7a.	Project Type Checklist: (Limited Project Types see	Section A. 7b.)
	1. Single Family Home	2. Residential Subdivision
	3. Commercial/Industrial	4. 🛛 Dock/Pier
	5. Utilities	6. Coastal engineering Structure
	7. Agriculture (e.g., cranberries, forestry)	8. Transportation
	9. Other	
7b.		
	2. Limited Project Type	
	If the proposed activity is eligible to be treated as an CMR10.24(8), 310 CMR 10.53(4)), complete and at Project Checklist and Signed Certification.	
8.	Property recorded at the Registry of Deeds for:	
	a. County	b. Certificate # (if registered land)
	c. Book	d. Page Number
В.	Buffer Zone & Resource Area Impa	acts (temporary & permanent)
1.	Buffer Zone Only – Check if the project is located	
2.	Vegetated Wetland, Inland Bank, or Coastal Re ☐ Inland Resource Areas (see 310 CMR 10.54-10	

Check all that apply below. Attach narrative and any supporting documentation describing how the project will meet all performance standards for each of the resource areas altered, including standards requiring consideration of alternative project design or location.

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For all projects affecting other Resource Areas, please attach a narrative explaining how the resource area was delineated.

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B. Buffer Zone & Resource Area Impacts (temporary & permanent) (cont'd)

Resource Ar	<u>ea</u>	Size of Proposed Alteration	Proposed Replacement (if any)
a. 🗌 🛮 Bar		1. linear feet	2. linear feet
	dering Vegetated tland	1. square feet	2. square feet
_	nd Under terbodies and	1. square feet	2. square feet
Wa	terways	3. cubic yards dredged	
Resource Ar	<u>ea</u>	Size of Proposed Alteration	Proposed Replacement (if any)
	dering Land oject to Flooding	1. square feet	2. square feet
		3. cubic feet of flood storage lost	4. cubic feet replaced
	ated Land oject to Flooding	1. square feet	
		2. cubic feet of flood storage lost	3. cubic feet replaced
f. Riv	erfront Area	1. Name of Waterway (if available) - spec	ify coastal or inland
2. Wic	dth of Riverfront Area (d	check one):	
	25 ft Designated De	nsely Developed Areas only	
	100 ft New agricultu	ral projects only	
	200 ft All other proje	cts	
3. Total	area of Riverfront Area	on the site of the proposed projec	t: square feet
	osed alteration of the R		Square reet
a. total so	quare feet	b. square feet within 100 ft.	c. square feet between 100 ft. and 200 ft.
5. Has a	an alternatives analysis	been done and is it attached to this	s NOI? Yes No
6. Was	the lot where the activit	ry is proposed created prior to Augu	ust 1, 1996?

3.

Coastal Resource Areas: (See 310 CMR 10.25-10.35)

Note: for coastal riverfront areas, please complete Section B.2.f. above.

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B. Buffer Zone & Resource Area Impacts (temporary & permanent) (cont'd)

Check all that apply below. Attach narrative and supporting documentation describing how the project will meet all performance standards for each of the resource areas altered, including standards requiring consideration of alternative project design or location.

4.

5.

Resource Area		Size of Proposed Alteration	Proposed Replacement (if any)
а. 🗌	Designated Port Areas	Indicate size under Land Unde	er the Ocean, below
b. 🔀	Land Under the Ocean	305 1. square feet	
		2. cubic yards dredged	
c. 🗌	Barrier Beach	Indicate size under Coastal Bea	aches and/or Coastal Dunes below
d. 🗌	Coastal Beaches	1. square feet	2. cubic yards beach nourishment
e. 🗌	Coastal Dunes	1. square feet	2. cubic yards dune nourishment
		Size of Proposed Alteration	Proposed Replacement (if any)
f. 🗌	Coastal Banks	1. linear feet	
g. 🗀	Rocky Intertidal Shores	1. square feet	
h. 🗌	Salt Marshes	1. square feet	2. sq ft restoration, rehab., creation
i. 🗌	Land Under Salt Ponds	1. square feet	
		2. cubic yards dredged	
j. 🗌	Land Containing Shellfish	1. square feet	
k. 🗌	Fish Runs		nks, inland Bank, Land Under the er Waterbodies and Waterways,
		cubic yards dredged	
I. 🛛	Land Subject to	305	
Coastal Storm Flowage 1. square feet Restoration/Enhancement If the project is for the purpose of restoring or enhancing a wetland resource area in addition to the square footage that has been entered in Section B.2.b or B.3.h above, please enter the additional amount here.			
a. square feet of BVW		b. square feet of	Salt Marsh
☐ Pr	oject Involves Stream Cros	ssings	
a. number of new stream crossings		h number of rool	acement stream crossings
a. Hullib	or or new stream crossings	b. number of repr	acement sucam crossings

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C	Other Applicable Standards and Requires			
Ο.	Other Applicable Otalidards and Require	licitio		
	This is a proposal for an Ecological Restoration Limited complete Appendix A: Ecological Restoration Limited Pr (310 CMR 10.11).			
Str	reamlined Massachusetts Endangered Species Act/W	etlands Pro	tection Act Review	
1.	Is any portion of the proposed project located in Estimated H the most recent Estimated Habitat Map of State-Listed Rare V Natural Heritage and Endangered Species Program (NHESP) <i>Massachusetts Natural Heritage Atlas</i> or go to http://maps.massgis.state.ma.us/PRI EST HAB/viewer.htm.	Vetland Wildli	fe published by the	
	a. Yes No If yes, include proof of mailing or h	and delivery	of NOI to:	
	Natural Heritage and Endangered Division of Fisheries and Wildlife 1 Rabbit Hill Road Westborough, MA 01581	Species Progr	am	
If yes, the project is also subject to Massachusetts Endangered Species Act (MESA) review (32 CMR 10.18). To qualify for a streamlined, 30-day, MESA/Wetlands Protection Act review, please complete Section C.1.c, and include requested materials with this Notice of Intent (NOI); OR complete Section C.2.f, if applicable. If MESA supplemental information is not included with the by completing Section 1 of this form, the NHESP will require a separate MESA filing which may up to 90 days to review (unless noted exceptions in Section 2 apply, see below).				
	c. Submit Supplemental Information for Endangered Species	Review*		
	1. Percentage/acreage of property to be altered:			
	(a) within wetland Resource Area percentage/	acreage		
	(b) outside Resource Area percentage/s	acreage		
	2. Assessor's Map or right-of-way plan of site			
2.	Project plans for entire project site, including wetland resolved wetlands jurisdiction, showing existing and proposed condition tree/vegetation clearing line, and clearly demarcated limits of	ns, existing ar		
	(a) Project description (including description of impact buffer zone)	ts outside of	wetland resource area &	
	(b) Photographs representative of the site			

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^{*} Some projects not in Estimated Habitat may be located in Priority Habitat, and require NHESP review (see https://www.mass.gov/maendangered-species-act-mesa-regulatory-review).

Priority Habitat includes habitat for state-listed plants and strictly upland species not protected by the Wetlands Protection Act.

^{**} MESA projects may not be segmented (321 CMR 10.16). The applicant must disclose full development plans even if such plans are not required as part of the Notice of Intent process.



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C. C	Other A	Applicable	Standards	and Red	uirements	(cont'd)
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	Make o	<u>a-project-review</u>).	ole at https://www.mass.gov/how-to/how-to			
	Projects altering 10 or more acres of land, also submit:					
	(e)	Project plans showing Priority & Estima	ated Habitat boundaries			
	(f) OF	R Check One of the Following				
	1. Project is exempt from MESA review. Attach applicant letter indicating which MESA exemption applies. (See 321 CMR 10.14 https://www.mass.gov/service-details/exemptions-from-review-for-projectsactivities-in-priority-habitat ; the NOI must still be sent to NHESP if the project is within estimated habitat pursuant to 310 CMR 10.37 and 10.59.)					
	2. 🗌	Separate MESA review ongoing.	a. NHESP Tracking # b. Date submitted to	NHESP		
	3. 🗌	Separate MESA review completed. Include copy of NHESP "no Take" dete Permit with approved plan.	rmination or valid Conservation & Manage	ment		
3.	3. For coastal projects only, is any portion of the proposed project located below the mean high wate line or in a fish run?					
	a. Not a	applicable – project is in inland resource	area only b. ⊠ Yes □ No			
	If yes, inclu	ude proof of mailing, hand delivery, or ele	ectronic delivery of NOI to either:			
	South Shore the Cape &	e - Cohasset to Rhode Island border, and Islands:	North Shore - Hull to New Hampshire border:			
	Southeast M Attn: Environ 836 South F New Bedford	Marine Fisheries - Marine Fisheries Station Inmental Reviewer Rodney French Blvd. d, MA 02744 Inview-south@mass.gov	Division of Marine Fisheries - North Shore Office Attn: Environmental Reviewer 30 Emerson Avenue Gloucester, MA 01930 Email: dmf.envreview-north@mass.gov			
Also if yes, the project may require a Chapter 91 license. For coastal towns in the Northeast Region please contact MassDEP's Boston Office. For coastal towns in the Southeast Region, please contact MassDEP's Southeast Regional Office.						
	c. Is t	this an aquaculture project?	d. 🗌 Yes 🛛 No			
	If yes, include a copy of the Division of Marine Fisheries Certification Letter (M.G.L. c. 130, § 57).					

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C. Other Applicable Standards and Requirements (cont'd)

	4.	Is any portion of the proposed project within an Area of Critical Environmental Concern (ACEC)?
Online Users: Include your document		a. Yes No If yes, provide name of ACEC (see instructions to WPA Form 3 or MassDEP Website for ACEC locations). Note: electronic filers click on Website.
transaction number		b. ACEC
(provided on your receipt page)	5.	Is any portion of the proposed project within an area designated as an Outstanding Resource Water (ORW) as designated in the Massachusetts Surface Water Quality Standards, 314 CMR 4.00?
with all supplementary information you		a. 🗌 Yes 🗵 No
submit to the Department.	6.	Is any portion of the site subject to a Wetlands Restriction Order under the Inland Wetlands Restriction Act (M.G.L. c. 131, § 40A) or the Coastal Wetlands Restriction Act (M.G.L. c. 130, § 105)?
		a. Yes No
	7.	Is this project subject to provisions of the MassDEP Stormwater Management Standards?
		a. Yes. Attach a copy of the Stormwater Report as required by the Stormwater Management Standards per 310 CMR 10.05(6)(k)-(q) and check if:
		 Applying for Low Impact Development (LID) site design credits (as described in Stormwater Management Handbook Vol. 2, Chapter 3)
		2. A portion of the site constitutes redevelopment
		3. Proprietary BMPs are included in the Stormwater Management System.
		b. No. Check why the project is exempt:
		1. Single-family house
		2. Emergency road repair
		3. Small Residential Subdivision (less than or equal to 4 single-family houses or less than or equal to 4 units in multi-family housing project) with no discharge to Critical Areas.
	D.	Additional Information
		This is a proposal for an Ecological Restoration Limited Project. Skip Section D and complete Appendix A: Ecological Restoration Notice of Intent – Minimum Required Documents (310 CMR 10.12).
		Applicants must include the following with this Notice of Intent (NOI). See instructions for details.
		Online Users: Attach the document transaction number (provided on your receipt page) for any of the following information you submit to the Department.
		1. USGS or other map of the area (along with a narrative description, if necessary) containing sufficient information for the Conservation Commission and the Department to locate the site (Electronic filers may omit this item.)
		2. Plans identifying the location of proposed activities (including activities proposed to serve as a Bordering Vegetated Wetland [BVW] replication area or other mitigating measure) relative to the boundaries of each affected resource area.

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	Document Transaction Number
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Massachusetts Wetlands Protection Act M.G.L. c. 131, §40				Document Transaction Number					
			_	City/Town					
D.	D. Additional Information (cont'd)								
	3.	Identify the method for BVW and other resource. Field Data Form(s), Determination of Application and attach documentation of the method.	bility, Order of Res						
	4. 🛛	ed with this NOI.							
4. List the titles and dates for all plans and other materials submitted with this NOI. Sargent's Wharf Water Taxi Dock Replacement Plans									
	a. F	Plan Title	Payson R. Whitne	v III					
	TR	Prepared By	c. Signed and Stamped	-					
		vember 2, 2022	Varies (see plans)	-					
		Final Revision Date	e. Scale	<u>'</u>					
	f. A	dditional Plan or Document Title		g. Date					
	5.	If there is more than one property owner, ple listed on this form.	ase attach a list of t	these property owners not					
	6.	Attach proof of mailing for Natural Heritage a	and Endangered Sp	ecies Program, if needed.					
	heries, if needed.								
	8. 🛛	Attach NOI Wetland Fee Transmittal Form							
	9.	Attach Stormwater Report, if needed.							
E.	Fees								
 Fee Exempt: No filing fee shall be assessed for projects of any city, town, county, or d of the Commonwealth, federally recognized Indian tribe housing authority, municipal h authority, or the Massachusetts Bay Transportation Authority. 									
Applicants must submit the following information (in addition to pages 1 and 2 of the NC Fee Transmittal Form) to confirm fee payment:									
	124249	,	08/25/22						
		ipal Check Number	3. Check date						
	124249		08/25/22						
		Check Number	5. Check date						
	Comm	onwealth of Massachusetts, City of Roston							

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7. Payor name on check: Last Name

6. Payor name on check: First Name



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Provi	ded by MassDEP:
=	MassDEP File Number
=	Document Transaction Number
-	City/Town

F. Signatures and Submittal Requirements

I hereby certify under the penalties of perjury that the foregoing Notice of Intent and accompanying plans, documents, and supporting data are true and complete to the best of my knowledge. I understand that the Conservation Commission will place notification of this Notice in a local newspaper at the expense of the applicant in accordance with the wetlands regulations, 310 CMR 10.05(5)(a).

I further certify under penalties of perjury that all abutters were notified of this application, pursuant to the requirements of M.G.L. c. 131, § 40. Notice must be made by Certificate of Mailing or in writing by hand delivery or certified mail (return receipt requested) to all abutters within 100 feet of the property line of the project location.

Marcia Gordon	11/2/2022 10:56:04 EDT
1. Signature of Applicant Docustigned by:	2. Date 11/2/2022 12:32:56 EDT
3. Signature of Property Owner (If afferent) Locusigned by: Kill Fisher	4. Date 11/2/2022 12:41:00 EDT
5. Signature of Representative (if any)	6. Date

For Conservation Commission:

Two copies of the completed Notice of Intent (Form 3), including supporting plans and documents, two copies of the NOI Wetland Fee Transmittal Form, and the city/town fee payment, to the Conservation Commission by certified mail or hand delivery.

For MassDEP:

One copy of the completed Notice of Intent (Form 3), including supporting plans and documents, one copy of the NOI Wetland Fee Transmittal Form, and a **copy** of the state fee payment to the MassDEP Regional Office (see Instructions) by certified mail or hand delivery.

Other:

If the applicant has checked the "yes" box in any part of Section C, Item 3, above, refer to that section and the Instructions for additional submittal requirements.

The original and copies must be sent simultaneously. Failure by the applicant to send copies in a timely manner may result in dismissal of the Notice of Intent.

wpaform3.doc • rev. 6/18/2020 Page 9 of 9



Massachusetts Department of Environmental Protection

Bureau of Resource Protection - Wetlands

NOI Wetland Fee Transmittal Form

Massachusetts Wetlands Protection Act M.G.L. c. 131, §40

Important: When filling out forms on the computer, use only the tab key to move your cursor - do not use the return





A. Applicant Information							
Location of Project:							
1 Eastern Avenue	Boston						
a. Street Address	b. City/Town						
1242492	77.50						
c. Check number	d. Fee amount						
2. Applicant Mailing Address:							
Marcia	Gordon						
a. First Name	b. Last Name						
Pilot House Properties LLC							
c. Organization							
32 Atlantic Avenue	32 Atlantic Avenue						
d. Mailing Address							
Boston	MA	02109					
e. City/Town	f. State	g. Zip Code					
(617) 854-3130	Marcia.Gordon@pilothou	Marcia.Gordon@pilothouse.com					
h. Phone Number i. Fax Num							
3. Property Owner (if different):							
a. First Name	b. Last Name						
Boston Planning and Development Agency (BPDA)							
c. Organization							
One City Hall, 9th Floor							
d. Mailing Address							
Boston	MA	02201					
e. City/Town	f. State	g. Zip Code					
(617) 722-4300	william.j.epperson@bosto	on.gov					

To calculate filing fees, refer to the category fee list and examples in the instructions for filling out WPA Form 3 (Notice of Intent).

B. Fees

h. Phone Number

Fee should be calculated using the following process & worksheet. *Please see Instructions before filling out worksheet.*

j. Email Address

Step 1/Type of Activity: Describe each type of activity that will occur in wetland resource area and buffer zone.

Step 2/Number of Activities: Identify the number of each type of activity.

i. Fax Number

Step 3/Individual Activity Fee: Identify each activity fee from the six project categories listed in the instructions.

Step 4/Subtotal Activity Fee: Multiply the number of activities (identified in Step 2) times the fee per category (identified in Step 3) to reach a subtotal fee amount. Note: If any of these activities are in a Riverfront Area in addition to another Resource Area or the Buffer Zone, the fee per activity should be multiplied by 1.5 and then added to the subtotal amount.

Step 5/Total Project Fee: Determine the total project fee by adding the subtotal amounts from Step 4.

Step 6/Fee Payments: To calculate the state share of the fee, divide the total fee in half and subtract \$12.50. To calculate the city/town share of the fee, divide the total fee in half and add \$12.50.

В



Massachusetts Department of Environmental Protection

Bureau of Resource Protection - Wetlands

NOI Wetland Fee Transmittal Form

Massachusetts Wetlands Protection Act M.G.L. c. 131, §40

. Fees (continued)			
Step 1/Type of Activity	Step 2/Number of Activities	Step 3/Individual Activity Fee	Step 4/Subtotal Activity Fee
5. work on docks, piers, revetments, dikes, etc. (coastal)	1	\$4/LF	120.00
6. Land Under the Ocean	1	\$2/LF	60.00
			· -
	Step 5/To	otal Project Fee:	180.00
	Step 6/	Fee Payments:	
	Total	Project Fee:	180.00 a. Total Fee from Step 5
	State share	of filing Fee:	77.50 b. 1/2 Total Fee less \$ 12.50
	City/Town share	e of filling Fee:	exempt (separate fee for BCC)

C. Submittal Requirements

 a.) Complete pages 1 and 2 and send with a check or money order for the state share of the fee, payable to the Commonwealth of Massachusetts.

> Department of Environmental Protection Box 4062 Boston, MA 02211

b.) **To the Conservation Commission:** Send the Notice of Intent or Abbreviated Notice of Intent; a **copy** of this form; and the city/town fee payment.

To MassDEP Regional Office (see Instructions): Send a copy of the Notice of Intent or Abbreviated Notice of Intent; a **copy** of this form; and a **copy** of the state fee payment. (E-filers of Notices of Intent may submit these electronically.)

From: Conese, Katherine
To: Fisher, Heidi

Subject: FW: Sargent's Wharf Water Taxi In-Kind Float Replacement Notice of Intent

Date: Tuesday, November 1, 2022 1:28:52 PM

Attachments: Sargent's Wharf Water Taxi In-Kind Float Replacement Notice of Intent.pdf

image001.png

Katie Conese

Environmental Scientist



Waltham, MA **T** 781.419.7709

From: Conese, Katherine

Sent: Wednesday, October 5, 2022 3:38 PM **To:** dmf.envreview-north@mass.gov

Cc: Whitney, Payson <PWhitney@trccompanies.com>; Fisher, Heidi <HFisher@trccompanies.com>

Subject: Sargent's Wharf Water Taxi In-Kind Float Replacement Notice of Intent

Environmental Reviewer,

Please see the attached electronic copy of the Sargent's Wharf Water Taxi In-Kind Float Replacement Notice of Intent. Let me know if you would like a hard copy sent as well.

Thanks, Katie

Katie Conese

Environmental Scientist



404 Wyman Street, Suite 375, Waltham, MA 02451 T 781.419.7709 | kconese@trccompanies.com
LinkedIn | Twitter | TRCcompanies.com



The Commonwealth of Massachusetts Division of Marine Fisheries

251 Causeway Street, Suite 400, Boston, MA 02114 p: (617) 626-1520 | f: (617) 626-1509 www.mass.gov/marinefisheries



CHARLES D. BAKER Governor KARYN E. POLITO Lt. Governor BETHANY A. CARD Secretary

RONALD S. AMIDON Commissioner

DANIEL J. MCKIERNAN Director

October 13, 2022

Boston Conservation Commission
City of Boston Environmental Department
Attn: N. Moreno
1 City Hall Square, Room 709
Boston, MA 02201

Dear Commissioners:

Massachusetts Division of Marine Fisheries (DMF) staff have reviewed the Notice of Intent (NOI) Application submitted by Pilot House Properties for the proposed replacement of an existing pile-held float off Eastern Avenue at Sargent's Wharf in Boston Harbor. All reconstruction and repairs will be conducted within the footprint of the existing structures. Three steel piles will be removed and replaced by three new steel piles and the existing 300sf float will be removed and replaced by a new float occupying the same footprint.

The proposed project is in Land Under the Ocean (310 CMR 10.25) in Boston Harbor. Land Under the Ocean in Beverly Harbor is considered suitable spawning habitat for winter flounder (*Psuedopleuronectus americanus*) and numerous diadromous fish species access important spawning and early development habitat through Boston Harbor including rainbow smelt (*Osmerus mordax*), american eel (*Anguilla rostrata*), alewife (*Alosa pseudoharengus*), blueback herring (*Alosa aestivalis*), American shad (*Alosa sepidissima*), white perch (*Morone americana*), and Atlantic tomcod (*Microgadus tomcod*).

Below is a list of concerns and associated recommendations by DMF for the avoidance, minimization, and mitigation of impacts by the proposed work to the fisheries resources listed above.

- **Pile removal and installation:** Piling removal and installation can result in turbidity and sound impacts that can affect early life history stages of winter flounder and the passage of diadromous fish.
 - o A Time of Year (TOY) restriction is not necessary for the proposed pile work as a small number of piles are planned to be removal and installed and the work will be restricted to a small portion of available migratory and spawning habitat.
 - o During pile driving, a slow-start should be used to reduce turbidity and to startle fish away from the site and vibratory driving should be used rather than impact driving or jetting to minimize impacts to fish through turbidity and noise.
 - o If currents allow, a silt curtain should be used around the site during pile removal and installation.

Thank you for considering our comments. Questions about this review may be directed to Forest Schenck in our Gloucester office at $\underline{Forest.Schenck@mass.gov}$.

Sincerely,

Forest Schenck, Ph.D.

J. 2. 2. 2. --

Environmental Analyst

Cc.

H. Fisher, TRC Environmental Corporation

R. Boeri, CZM

C. Jacek, ACOE

FS



Boston Wetlands Ordinance - Notice of Intent





INSTRUCTIONS FOR COMPLETING APPLICATION NOTICE OF INTENT – BOSTON NOI FORM (2021)

The Boston Notice of Intent Form is intended to be a supplement to the WPA Form 3 detailing impacts to locally designated wetland resource areas and buffer zones. Please read these instructions for assistance in completing the Notice of Intent application form. These instructions cover certain items on the Notice of Intent form that are not self-explanatory.

INSTRUCTIONS TO SECTION B: BUFFER ZONE AND RESOURCE AREA IMPACTS

<u>Item 1. Buffer Zone Only.</u> If you check the Buffer Zone Only box in this section you are indicating that the project is entirely in the Buffer Zone to a resource area **under both** the Wetlands Protection Act and Boston Wetlands Ordinance. If so, skip the remainder of Section B and go directly to Section C. Do not check this box if the project is within the Waterfront Area.

<u>Item 2</u>. The **boundaries of coastal resource areas** specific to the Ordinance can be found in Section II of the Boston Wetlands Regulations. You must also include the size of the proposed alterations (and proposed replacement areas) in each resource area.

<u>Item 3</u>. The **boundaries of inland resource areas** specific to the Ordinance can be found in Section II of the Boston Wetlands Regulations. You must also include the size of the proposed alterations (and proposed replacement areas) in each resource area.

INSTRUCTIONS TO SECTION C: OTHER APPLICABLE STANDARDS AND REQUIREMENTS

<u>Item 1. Rare Wetland Wildlife Habitat</u>. Except for Designated Port Areas, no work (including work in the Buffer Zone) may be permitted in any resource area that would have adverse effects on the habitat of rare, "state-listed" vertebrate or invertebrate animal species.

The most recent Estimated Habitat Map of State-Listed Rare Wetland Wildlife is published by the Natural Heritage and Endangered Species Program (NHESP). See: http://maps.massgis.state.ma.us/PRI_EST_HAB/viewer.htm or the Massachusetts Natural Heritage Atlas.

If any portion of the proposed project is located within Estimated Habitat, the applicant must send the Natural Heritage Program, at the following address, a copy of the Notice of Intent by certified mail or priority mail (or otherwise sent in a manner that guarantees delivery within two days), no later than the date of the filing of the Notice of Intent with the Conservation Commission.

Evidence of mailing to the Natural Heritage Program (such as Certified Mail Receipt or Certificate of Mailing for Priority Mail) must be submitted to the Conservation Commission along with the Notice of Intent.

Natural Heritage and Endangered Species Program
Division of Fisheries and Wildlife
1 Rabbit Hill Road
Westborough, MA 01581-3336
508.792.7270

City of Boston Environment

NOTICE OF INTENT APPLICATION FORM

Boston Wetlands Ordinance City of Boston Code, Ordinances, Chapter 7-1.4

Boston File Number

MassDEP File Number

A. GENERAL INFORMATION

1. Project Loca	ation		
1 Eastern Ave	enue	Boston	02110
a. Street Address		b. City/Town	c. Zip Code
		030303700	0
f. Assessors Map/P	lat Number	g. Parcel /Lot Num	
2. Applicant			
Marcia	Gordon	Pilot Hou	se Properties LLC
a. First Name	b. Last Name	c. Company	<u> </u>
32 Atlantic Ave	enue		
d. Mailing Address			
Boston		MA	02110
e. City/Town		f. State	g. Zip Code
(617) 854-313	80		n@pilothouse.com
h. Phone Number	i. Fax Number	j. Email address	
3. Property Ov	vner		
1 3		Boston Planning a	and Development Agency
a. First Name	b. Last Name	c. Company	
One City Hall,	9th Floor		
d. Mailing Address			
Boston		MA	02201
e. City/Town		f. State	g. Zip Code
(617) 722-4300			
h. Phone Number	i. Fax Number	j. Email address	
Check if m	ore than one owner		
, L		e attach a list of these property owner	rs to this form.)
•		1 1 0	,
4. Representat	` ,		
Heidi	Fisher		nental Corporation
a. First Name	b. Last Name	c. Company	
	street, Suite 375)	
d. Mailing Address			
Waltham		MA	02451
e. City/Town		f. State	g. Zip Code
(781) 419-7730		hfisher@trccomp	anies.com
h. Phone Number	i. Fax Number	j. Email address	

City of Boston Environment

NOTICE OF INTENT APPLICATION FORM

Boston File Number

Boston Wetlands Ordinance City of Boston Code, Ordinances, Chapter 7-1.4

MassDEP File Number

	Э.	Protection Act M.G.L. c. 131 §40?	ictioi	iai u	inder the massachusetts wetiands
		Yes			No
	If y	ves, please file the WPA Form 3 - Notice of Inte	ent w	rith 1	this form
	6.	General Information			
	Dila	ot House proposes to replace the Sarger	nt'e \	N/h≤	orf water taxi dock with a new
	pile	e-held float and guide piles within the exi	sting	foo	otprint. The proposed design
	ınc	ludes the in-kind replacement of a pile-h	eld t	loat	and three new piles.
	7.	Project Type Checklist			
		a. Single Family Home	b.		Residential Subdivision
		c. 📮 Limited Project Driveway Crossing	d.		Commercial/Industrial
		e. ■ Dock/Pier	f.		Utilities
		g. 🗖 Coastal Engineering Structure	h.		Agriculture – cranberries, forestry
		i. Transportation	j.		Other
	8.	Property recorded at the Registry of Deeds			
			1 1	2	AL L
	а. С	County	D. I	Page .	Number
_	c. I	Book	d. (Certif	ficate # (if registered land)
	9.	Total Fee Paid			
1,	69	77.50			1,620.00
	a. 7	Total Fee Paid b. WPA Fee Paid			c. Ordinance Fee Paid
B.		BUFFER ZONE & RESOURCE AREA IMPACT	S		
		ffer Zone Only - Is the project located only in	the E	Suffe	er Zone of a resource area protected by
	the	e Boston Wetlands Ordinance? Yes			✓ No
					<u>[♥]</u> - · · ·
	1.	Coastal Resource Areas			



NOTICE OF INTENT APPLICATION FORM

Boston Wetlands Ordinance City of Boston Code, Ordinances, Chapter 7-1.4

Boston File Number

MassDEP File Number

Resource Area	Resource <u>Area Size</u>	Proposed <u>Alteration*</u>	Proposed <u>Migitation</u>
Coastal Flood Resilience Zone			
25-foot Waterfront Area	Square feet	Square feet	Square feet
100-foot Salt Marsh Area	Square feet	Square feet	Square feet
Riverfront Area	Square feet	Square feet	Square fee
	Square feet	Square feet	Square feet
2. Inland Resource Areas			
Resource Area	Resource Area Size	Proposed Alteration*	Proposed Migitation
Inland Flood Resilience Zone			
Isolated Wetlands	Square feet	Square feet	Square feet
Vernal Pool	Square feet	Square feet	Square feet
Vernal Pool Habitat (vernal pool + 100 ft. upland area)	Square feet	Square feet	Square feet
	Square feet	Square feet	Square feet
25-foot Waterfront Area	Square feet	Square feet	Square fee
Riverfront Area			
	Square feet	Square feet	Square feet
C. OTHER APPLICABLE STANDARDS & REQUIREMEN	TS		
 What other permits, variances, or approvals are required herein and what is the status of such permits, variances. 		sed activity des	cribed
Chapter 91 Maintenance Letter - to be submitted			
USACE Self-Verification notification - to be submitted			

City of Boston Environment

NOTICE OF INTENT APPLICATION FORM

Boston File Number Boston Wetlands Ordinance

MassDEP File Number

City of Boston Code, Ordinances, Chapter 7-1.4

2.	indicated o published t habitat maj	on of the proposed project located in the most recent Estimated Habitat by the Natural Heritage and Endange os, see the Massachusetts Natural He w.mass.gov/dfwele/dfw/nhesp/nh	Map of State-Listo red Species Progra critage Atlas or go t	ed Rare Wetland Wildlife ım (NHESP)? To view
	Yes		√ No	
If yes	s, the project	is subject to Massachusetts Endang	ered Species Act (N	MESA) review (321 CMR 10.18).
	A. Submit	Supplemental Information for End	angered Species R	eview
		Percentage/acreage of property	to be altered:	
		(1) within wetland Resource	Area –	percentage/acreage
		(2) outside Resource Area	_	percentage/acreage
		Assessor's Map or right-of-way j	olan of site	
3.	Is any porti	on of the proposed project within ar	Area of Critical Er	nvironmental Concern?
	Yes		✓ No	
If y	yes, provide	he name of the ACEC:		
4.	Is the prop Standards?	osed project subject to provisions of	the Massachusetts	s Stormwater Management
		Attach a copy of the Stormwater Checomplying for a Low Impact Develop A portion of the site constitutes red Proprietary BMPs are included in the Check below & include a narrative as a Single-family house Emergency road repair Small Residential Subdivision (less than or equal to 4 units in a multiful Critical Areas	ment (LID) site descent evelopment he Stormwater Maro why the project in control of the control	ign credits nagement System s exempt oastal waters. ringle family houses or less
5.	Is the prop	osed project subject to Boston Water	and Sewer Comm	ission Review?
	Yes		✓ No	



NOTICE OF INTENT APPLICATION FORM

Boston Wetlands Ordinance
City of Boston Code, Ordinances, Chapter 7-1.4

Boston File Number

MassDEP File Number

D. SIGNATURES AND SUBMITTAL REQUIREMENTS

I hereby certify under the penalties of perjury that the foregoing Notice of Intent and accompanying plans, documents, and supporting data are true and complete to the best of my knowledge. I understand that the Conservation Commission will place notification of this Notice in a local newspaper at the expense of the applicant in accordance with the Wetlands Protection Ordinance.

Marcia F Gordon	Digitally signed by Marcia F Gordon Date: 2022.10.04 17:45:11 -04'00'	10/04/2022
Signature of Applicant		Date
Signature of Property Owner (if d	ifferent)	Date
Heidi Fisher	Digitally signed by Heidi Fisher Date: 2022.10.04 14:39:53 -04'00'	10/04/2022
Signature of Representative (if an	v)	Date



NOTICE OF INTENT APPLICATION FORM

Boston Wetlands Ordinance City of Boston Code, Ordinances, Chapter 7-1.4 Boston File Number

MassDEP File Number

D. SIGNATURES AND SUBMITTAL REQUIREMENTS

I hereby certify under the penalties of perjury that the foregoing Notice of Intent and accompanying plans, documents, and supporting data are true and complete to the best of my knowledge. I understand that the Conservation Commission will place notification of this Notice in a local newspaper at the expense of the applicant in accordance with the Wetlands Protection Ordinance.

Signature of Applicant

Digitally signed by William Epperson
Date: 2022.10.05 07:47:34 -04'00'

Signature of Property Owner (if different)

Heidi Fisher

Digitally signed by Heidi Fisher
Date: 2022.10.04 14:39:53 -04'00'

Signature of Representative (if any)

Date





APPENDIX A. - STATUTORY REVIEW & APPROVAL CHECKLIST

Applicants submitting a Notice of Intent to the Boston Conservation Commission are also required to include a list of all permits and approvals either obtained, or necessary to be obtained, for the proposed activity. This checklist is not fully comprehensive but Applicants may utilize this checklist to fulfill this requirement. Any additional permits and approvals needed should be discussed in the narrative accompanying the Notice of Intent.

FEDERAL REVIEWS AND APPROVALS

NEEDED	OBTAINED	REGULATION	REVIEW BODY
		National Environmental Policy Act (NEPA)	Varies
\checkmark		Section 404 Permit	U.S. Army Corps of Engineers
		National Pollution Discharge Elimination System Permit (NPDES)	U.S. Environmental Protection Agency
		Stormwater Construction General Permit	U.S. Environmental Protection Agency
		Federal Endangered Species Act (ESA)	U.S. Fish and Wildlife Service or National Marine Fisheries Service
		Federal Fisheries Regulations	National Marine Fisheries Service
COMMON	WEALTH OF M	ASSACHUSETTS REVIEWS AND A	APPROVALS
NEEDED	OBTAINED	REGULATION	REVIEW BODY
NEEDED	OBTAINED	Massachusetts Environmental Policy Act (MEPA)	Massachusetts Environmental Policy Act Office
NEEDED	OBTAINED	Massachusetts Environmental	Massachusetts Environmental Policy
NEEDED	OBTAINED	Massachusetts Environmental Policy Act (MEPA)	Massachusetts Environmental Policy Act Office
NEEDED	OBTAINED	Massachusetts Environmental Policy Act (MEPA) Federal Consistency Review Massachusetts Public Waterfront	Massachusetts Environmental Policy Act Office Office of Coastal Zone Management Massachusetts Department of Environmental Protection (Waterways
NEEDED	OBTAINED	Massachusetts Environmental Policy Act (MEPA) Federal Consistency Review Massachusetts Public Waterfront Act (Chapter 91) Section 401 Water Quality	Massachusetts Environmental Policy Act Office Office of Coastal Zone Management Massachusetts Department of Environmental Protection (Waterways Program) Massachusetts Department of Environmental Protection (Wetlands

****	City of Bo Environm		CITY of BOSTON Conservation Commission
		Historic Preservation	Massachusetts Board of Underwater Archaeological Resources
		Historic Preservation	Massachusetts Historical Commission
		Massachusetts Contingency Plan	Massachusetts Department of Environmental Protection
		Massachusetts Building Code Variance	Board of Building Regulations and Standards
CITY OF BO	OSTON LOCAL	REVIEWS AND APPROVALS	
NEEDED	OBTAINED	REGULATION	REVIEW BODY
NEEDED	OBTAINED	REGULATION Boston Zoning Code Article 80	Boston Planning and Development Agency
NEEDED	OBTAINED		Boston Planning and Development
NEEDED	OBTAINED	Boston Zoning Code Article 80	Boston Planning and Development Agency
NEEDED	OBTAINED	Boston Zoning Code Article 80 Boston Zoning Code	Boston Planning and Development Agency Inspectional Services Department
NEEDED	OBTAINED	Boston Zoning Code Article 80 Boston Zoning Code Boston Zoning Code Variance	Boston Planning and Development Agency Inspectional Services Department Zoning Board of Appeals
NEEDED	OBTAINED	Boston Zoning Code Article 80 Boston Zoning Code Boston Zoning Code Variance Project Design Review	Boston Planning and Development Agency Inspectional Services Department Zoning Board of Appeals Civic Design Commission
NEEDED	OBTAINED	Boston Zoning Code Article 80 Boston Zoning Code Boston Zoning Code Variance Project Design Review Utility Plan Review Boston Zoning Code Article 32	Boston Planning and Development Agency Inspectional Services Department Zoning Board of Appeals Civic Design Commission Boston Water and Sewer Commission

Public Realm Improvements

Massachusetts Building Code

Parking Freeze/Abrasive Blasting

Boston Public Improvement

Boston Air Pollution Control

Inspectional Services Department

Commission


Commission



Abutter Notification Materials

SITE_ADDR	SITE_CITY	SITE_STATE	SITE_ZIP	OWNER_NAME_1	OWNER_NAME_2	MAIL_ADDR	MAIL_CITY	MAIL_STATE	MAIL_ZIP
1 EASTERN AVE	BOSTON	MA	2109	BOSTON, REDEVELOPMENT AUTH	<null></null>	EASTERN AVE	BOSTON	MA	2150
103 UNION WHARF	BOSTON	MA	2109	BUCKLAND, ARTHUR R	BUCKLAND, ARTHUR	103 UNION WHARF	BOSTON	MA	2109
104 UNION WHARF	BOSTON	MA	2109	PRINN, MICHAEL D	PRINN, PETA-GAYE M	104 UNION WHARF	BOSTON	MA	2109
105 UNION WHARF	BOSTON	MA	2109	MELWANI, MICHELLE	<null></null>	105 UNION WHARF	BOSTON	MA	2109
109 UNION WHARF	BOSTON	MA	2109	KEOHANE FRANK REALTY LLC	<null></null>	343 COMMERCIAL ST	BOSTON	MA	2109
111 UNION WHARF	BOSTON	MA	2109	REGAN, GEORGE K	<null></null>	106 UNION WHARF	BOSTON	MA	2109
201 UNION WHARF	BOSTON	MA	2109	JURGENS, LORI	<null></null>	201 UNION WHARF	BOSTON	MA	2109
203 UNION WHARF	BOSTON	MA	2109	BAKER, MARK F	BAKER, AASMA S	203 UNION WHARF	BOSTON	MA	2109
204 UNION WHARF	BOSTON	MA	2109	CUTLER, ROBERT J	CUTLER, PAMELA J	204 UNION WHARF	BOSTON	MA	2109
205 UNION WHARF	BOSTON	MA	2109	GRUBER, WILLIAM R	<null></null>	75 HOPESTILL BROWN RD	SUDBURY	MA	1776
207 UNION WHARF	BOSTON	MA	2109	GRAY, STEPHEN S	<null></null>	207 UNION WHARF	BOSTON	MA	2109
209 UNION WHARF	BOSTON	MA	2109	CON JUDE LLC	<null></null>	<null></null>	<null></null>	<null></null>	<nuii></nuii>
211 UNION WHARF	BOSTON	MA	2109	CHARA, ZDENO	<null></null>	211 UNION WHARF	BOSTON	MA	2109
212 UNION WHARF	BOSTON	MA	2109	ABRANO, FRANK M	ABRANO, KIM S	8 RUBEN DUREN WAY	BEDFORD	MA	1730
295 COMMERCIAL ST # 30	BOSTON	MA	2109	LATTI, MICHAEL T	<null></null>	295 COMMERCIAL ST	BOSTON	MA	2109
295 COMMERCIAL ST # 31	BOSTON	MA	2109	LATTI, MICHAEL T	<null></null>	295 COMMERCIAL ST	BOSTON	MA	2109
295-343 COMMERCIAL ST	BOSTON	MA	2109	WHARF, UNION T	<null></null>	295 COMMERCIAL ST	BOSTON	MA	2109
301 UNION WHARF	BOSTON	MA	2109	CARBEAU, KEVIN	HARRINGTON, KATHRYN	301 UNION WHARF	BOSTON	MA	2109
302 UNION WHARF	BOSTON	MA	2109	WOLOSZ, JUSTIN J	WOLOSZ, ALLISON M	343 COMMERCIAL ST UNIT 302	BOSTON	MA	2109
303 UNION WHARF	BOSTON	MA	2109	NAJARIAN, MARK A	<null></null>	303 UNION WHARF	BOSTON	MA	2109
304 UNION WHARF	BOSTON	MA	2109	KREJCI, DAVID	<null></null>	304 UNION WHARF	BOSTON	MA	2109
305 UNION WHARF	BOSTON	MA	2109	MAZZARELLA, LYNN	<nuii></nuii>	305 UNION WHARF	BOSTON	MA	2109
307 UNION WHARF	BOSTON	MA	2109	ARDITO, FRANK T	DILLON, ROBIN	307 UNION WHARF	BOSTON	MA	2109
309 UNION WHARF	BOSTON	MA	2109	SMETANA, LAWRENCE P	<null></null>	309 UNION WHARF	BOSTON	MA	2109
310 UNION WHARF	BOSTON	MA	2109	ZAVRL, FRANK	ZAVRL, PAULA	87 SALEM ST	ANDOVER	MA	1810
343 COMMERCIAL ST # 101	BOSTON	MA	2109	MARY ROSE DUPUIS RET	DUPUIS, PETER A	343 COMMERCIAL ST # 101	BOSTON	MA	2109
343 COMMERCIAL ST # 106	BOSTON	MA	2109	REGAN, GEORGE K	<null></null>	343 COMMERCIAL ST # 106	BOSTON	MA	2109
343 COMMERCIAL ST # 107	BOSTON	MA	2109	SCAPPICHIO, ROSEMARY	SCAPPICHIO, RALPH	343 COMMERCIAL ST # 107	BOSTON	MA	2109
343 COMMERCIAL ST # 108	BOSTON	MA	2109	108 UNION WHARF LLC	<null></null>	343 COMMERCIAL ST # 108	BOSTON	MA	2109
343 COMMERCIAL ST # 110	BOSTON	MA	2109	REGAN, GEORGE K	<null></null>	343 COMMERCIAL ST # 110	BOSTON	MA	2109
343 COMMERCIAL ST # 111B	BOSTON	MA	2109	MCFARLAND, THOMAS J	MCFARLAND, KATYN B	343 COMMERCIAL ST # 111B	BOSTON	MA	2109
343 COMMERCIAL ST # 112	BOSTON	MA	2109	KETABI, MAHMOUD	KETABI, AFARIN	28 ATLANTIC AVE # 219	BOSTON	MA	2110
343 COMMERCIAL ST # 113	BOSTON	W :	2109	BOSTON 113 UNION WHARF	MONAHAN, WILLIAM O	28 GREEN ST	NEEDHAM	MA	2492
343 COMMERCIAL ST # 114	BOSTON	MA W	2109	343 COMMERCIAL ST 114	VERROCHI, PAUL M	33 BEAVER PL	BOSTON	MA	2108
343 COIVINIERCIAL ST # 208	NOTO	MA	2109	REGAN, GEORGE N	Single Si	343 COMMINERCIAL ST # 200	NOTSON	MA	2109
343 COININIERCIAL ST # 208	BOSTON	MA	2109	REGAIN, GEORGE N	SINGIIS	343 CUMINIERCIAL ST # 208	BOSTON	MA MA	2109
343 COMMAFFICIAL ST # 210	BOSTON	MA	2109	KAY, INIAKILYN I	SINGIIS	211 LINION WILLS F	BROOKLINE	MA	2445
343 COMMERCIAL 31 # 214	BOSTON	<u> </u>	2109	ODONNELL PATRICA E	CHARA, IATIANA	343 COMMERCIAL STE	BOSTON	<u> </u>	2109
343 COMMERCIAL ST # 308	ROSTON	Z A	2103	IACOBSON WILLIAM	\\\\\\\\\\\\\\\\\\\\\\\\\\\\\\\\\\\\\\	343 COMMERCIAL ST # 308	BOSTON	Z A	2109
343 COMMERCIAL ST # 311	BOSTON	MA	2109	COCOZZA, MARK	COCOZZA. SUSAN	343 COMMERCIAL ST # 311	BOSTON	ΨW	2109
343 COMMERCIAL ST # 312	BOSTON	MA	2109	ZEGHIBE, ROGER W	<null></null>	343 COMMERCIAL ST # 312	BOSTON	MA	2109
343 COMMERCIAL ST # 314	BOSTON	MA	2109	THRALL, JEAN M	THRALL, JAMES H	343 COMMERCIAL ST # 314	BOSTON	MA	2109
343 COMMERCIAL ST # 402	BOSTON	MA	2109	CAMPANELLI, NICOLE	<null></null>	343 COMMERCIAL ST # 402	BOSTON	MA	2109
343 COMMERCIAL ST # 403	BOSTON	MA	2109	COLLINS, MONICA	ALPER, BENNETT L	343 COMMERCIAL ST # 403	BOSTON	MA	2109
343 COMMERCIAL ST # 404	BOSTON	MA	2109	BRASSERT, WALTER L	BRASSERT, JOAN B	343 COMMERCIAL ST # 404	BOSTON	MA	2109
343 COMMERCIAL ST # 405	BOSTON	MA	2109	EDWARDS, F ROSS	EDWARDS, LORRAINE W	343 COMMERCIAL ST # 405	BOSTON	MA	2109
343 COMMERCIAL ST # 406	BOSTON	MA	2109	CONTI, MATTHEW J	<nuii></nuii>	343 COMMERCIAL ST # 406	BOSTON	MA	2109
343 COMMERCIAL ST # 408	BOSTON	MA	2109	PRIMO, A M	<null></null>	343 COMMERCIAL ST # 408	BOSTON	MA	2109
343 COMMERCIAL ST # 503	BOSTON	MA	2109	HOPKINS, MERITA A	<null></null>	343 COMMERCIAL ST # 503	BOSTON	MA	2109
343 COMMERCIAL ST # 504	BOSTON	MA	2109	CORTELL, MARY BRENDA	<null></null>	343 COMMERCIAL ST # 504	BOSTON	MA	2109
343 COMMERCIAL ST # 505	BOSTON	MA	2109	SCHILLER, PHILIP W	<nuii></nuii>	234 MIRAMONTES AVE	HALF MOON BAY	క	94019

SITE_ADDR	SITE_CITY	SITE_STATE	SITE_ZIP	OWNER_NAME_1	OWNER_NAME_2	MAIL_ADDR	MAIL_CITY	MAIL_STATE MAIL_ZIP	MAIL_ZIP
343 COMMERCIAL ST # 506	BOSTON	MA	2109	EISEN, WILLIAM J	<null></null>	343 COMMERCIAL ST # 506	BOSTON	MA	2109
343 COMMERCIAL ST # 507	BOSTON	MA	2109	SCHILLER, PHILIP W	<null></null>	234 MIRAMONTES AVE	HALF MOON BAY	5	94019
343 COMMERCIAL ST # 508	BOSTON	MA	2109	LOSCOCCO, JAMES N	<null></null>	343 COMMERCIAL ST # 508	BOSTON	MA	2109
343 COMMERCIAL ST # 602	BOSTON	MA	2109	DORNBROOK, MICHAEL	<null></null>	343 COMMERCIAL ST # 602	BOSTON	MA	2109
343 COMMERCIAL ST # 604	BOSTON	MA	2109	THOMAJAN, GREGORY Z	THOMAJAN, ANDREA D	343 COMMERCIAL ST # 604	BOSTON	MA	2109
343 COMMERCIAL ST # 606	BOSTON	MA	2109	SULLIVAN, DANIEL W	SULLIVAN, KATHERINE	343 COMMERCIAL ST # 606	BOSTON	MA	2109
343 COMMERCIAL ST # 607	BOSTON	MA	2109	SCHILLER, PHILIP W	<null></null>	234 MIRAMONTES AVE	HALF MOON BAY	5	94019
343 COMMERCIAL ST # 608	BOSTON	MA	2109	LOSCOCCO, JAMES N	<null></null>	343 COMMERCIAL ST # 608	BOSTON	MA	2109
343 COMMERCIAL ST UNIT 102	BOSTON	MA	2109	FILARDO, MARCO A	<null></null>	440 SEAVIEW CT APT 1405	MARCO ISLAND	FL	34145
343 COMMERCIAL ST UNIT 202	BOSTON	MA	2109	HICKS, LAURENCE M	HICKS, VICTORIA W	<null></null>	<null></null>	<iinn></iinn>	<null></null>
401 UNION WHARF	BOSTON	MA	2109	CHARA, ZDENO	CHARA, TATIANA	401 UNION WHARF	BOSTON	MA	2109
407 UNION WHARF	BOSTON	MA	2109	MIRABELLA, STEVEN	<null></null>	407 UNION WHARF	BOSTON	MA	2109
501 UNION WHARF	BOSTON	MA	2109	YACOBIAN, ANTONIETTE	ROBINSON, MARK E	501 UNION WHARF	BOSTON	MA	2109
502 UNION WHARF	BOSTON	MA	2109	ALBERT REALTY HOLDINGS	<null></null>	343 COMMERCIAL ST # 402	BOSTON	MA	2109
52-58 EASTERN AVE	BOSTON	MA	2109	PILOT HOUSE PROPS LLC	<null></null>	LEWIS WHARF	BOSTON	MA	2110
ATLANTIC AVE	BOSTON	MA	2205	PILOT HOUSE PROPS LLC	<null></null>	LEWIS WHARF	BOSTON	MA	2110

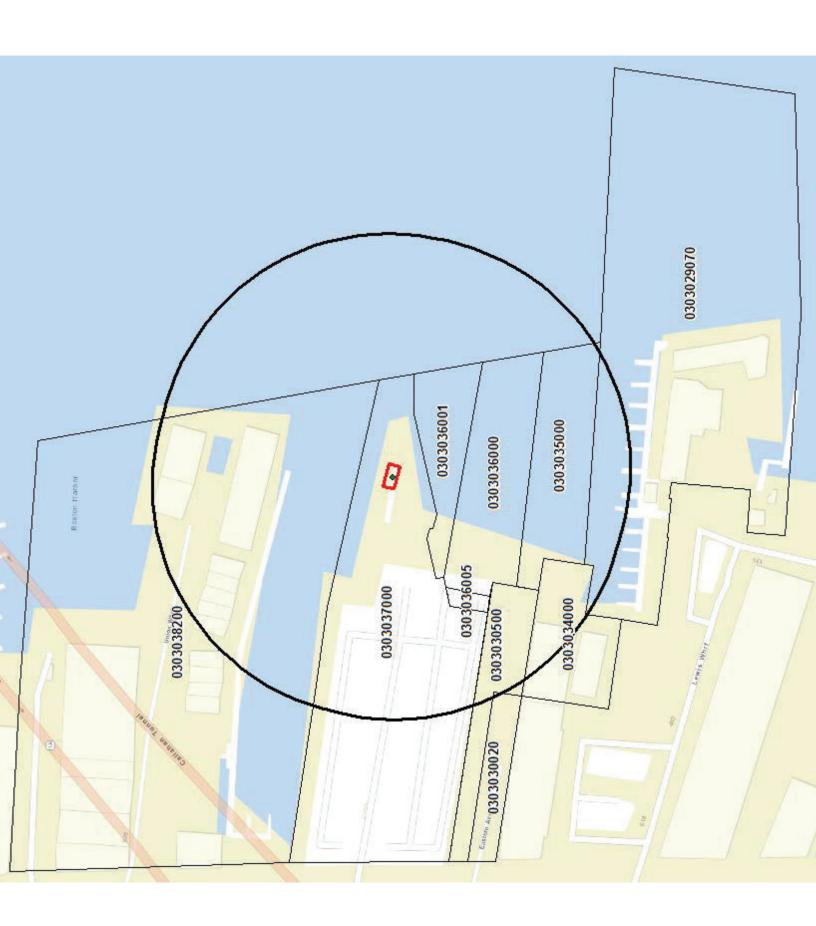





AFFIDAVIT OF SERVICE FOR ABUTTER NOTIFICATION

Under the Massachusetts Wetlands Protection Act and Boston Wetlands Ordinance

I, Heidi Fisher	, hereby certify under pains and penalties of perjury that that at least
	oublic hearing, I gave notice to abutters in compliance with the second
	setts General Laws Chapter 131, section 40, and the DEP Guide to Abutter
Notification dated Ap	il 8, 1994, in connection with the following matter:
A Notice of Inte	was filed under the Massachusetts Wetlands Protection Act
and/or the Bo	ston Wetlands Ordinance by Pilot House Properties LLC for
an in-kind dock repla	· ·
located at Sarg	nt's Wharf, Boston, MA
The Abutter Notificat attached to this Affida	on For, the list of abutters to whom it was given, and their addresses are vit of Service.
Heidi Fisher Digitally signed Date: 2022.08.1	Heidi Fisher 2:58:47 08/16/22
Name	Date





NOTIFICATION TO ABUTTERS BOSTON CONSERVATION COMMISSION

In accordance with the Massachusetts Wetlands Protection Act, Massachusetts General Laws Chapter 131, Section 40, and the Boston Wetlands Ordinance, you are hereby notified as an abutter to a project filed with the Boston Conservation Commission.

A. Pilot House Properties LLC has filed a Notice of Intent with the Boston Conservation Commission seeking permission to alter an Area Subject to Protection under the Wetlands Protection Act (General Laws Chapter 131, section 40) and/or the Boston Wetlands Ordinance.
B. The address of the lot where the activity is proposed is <u>1 Eastern Avenue, Boston, MA 02110</u>
C. The project involves the replacement and maintenance of an existing pile-held float. The float at Sargent's Wharf is used as one of the pick-up locations for the Boston Water Taxi.
D. Copies of the application may be obtained by contacting the Boston Conservation Commission at CC@boston.gov .
E. Copies of the application may be obtained from TRC Environmental Corporation— by contacting them at hisher@trccompanies.com——— between the hours of 9 AM—5 PM————, Monday-Friday————.
F. In accordance with the Chapter 107 of the Acts of 2022, the public hearing will take place virtually at https://zoom.us/j/6864582044 . If you are unable to access the internet, you can call 1-929-205-6099, enter Meeting ID 686 458 2044 # and use # as your participant ID.
G. Information regarding the date and time of the public hearing may be obtained from the Boston

G. Information regarding the date and time of the public hearing may be obtained from the **Boston Conservation Commission** by emailing <u>CC@boston.gov</u> or calling **(617) 635-3850** between the hours of **9 AM to 5 PM, Monday through Friday.**

NOTE: Notice of the public hearing, including its date, time, and place, will be published at least five (5) days in advance in the **Boston Herald**.

NOTE: Notice of the public hearing, including its date, time, and place, will be posted on www.boston.gov/public-notices and in Boston City Hall not less than forty-eight (48) hours in advance. If you would like to provide comments, you may attend the public hearing or send written comments to <a href="https://www.ccenter.com/ccenter.co

NOTE: If you would like to provide comments, you may attend the public hearing or send written comments to CC@boston.gov or Boston City Hall, Environment Department, Room 709, 1 City Hall Square, Boston, MA 02201

NOTE: You also may contact the Boston Conservation Commission or the Department of Environmental Protection Northeast Regional Office for more information about this application or the Wetlands Protection Act. To contact DEP, call: the Northeast Region: (978) 694-3200.

NOTE: If you plan to attend the public hearing and are in need of interpretation, please notify staff at CC@boston.gov by 12 PM the day before the hearing.



BABEL NOTICE

English:

IMPORTANT! This document or application contains **important information** about your rights, responsibilities and/or benefits. It is crucial that you understand the information in this document and/or application, and we will provide the information in your preferred language at no cost to you. If you need them, please contact us at cc@boston.gov or 617-635-3850.

Spanish:

¡IMPORTANTE! Este documento o solicitud contiene <u>información importante</u> sobre sus derechos, responsabilidades y/o beneficios. Es fundamental que usted entienda la información contenida en este documento y/o solicitud, y le proporcionaremos la información en su idioma preferido sin costo alguno para usted. Si los necesita, póngase en contacto con nosotros en el correo electrónico cc@boston.gov o llamando al 617-635-3850.

Haitian Creole:

AVI ENPÒTAN! Dokiman oubyen aplikasyon sa genyen <u>enfòmasyon ki enpòtan</u> konsènan dwa, responsablite, ak/oswa benefis ou yo. Li enpòtan ke ou konprann enfòmasyon ki nan dokiman ak/oubyen aplikasyon sa, e n ap bay enfòmasyon an nan lang ou prefere a, san ou pa peye anyen. Si w bezwen yo, tanpri kontakte nou nan <u>cc@boston.gov</u> oswa 617-635-3850.

Traditional Chinese:

非常重要!這份文件或是申請表格包含關於您的權利,責任,和/或福利的重要信息。請您務必完全理解 這份文件或申請表格的全部信息,這對我們來說十分重要。我們會免費給您提供翻譯服務。如果您有需要 請聯糸我們的郵箱 cc@boston.gov 電話# 617-635-3850..

Vietnamese:

QUAN TRỌNG! Tài liệu hoặc đơn yêu cầu này chứa **thông tin quan trọng** về các quyền, trách nhiệm và/hoặc lợi ích của bạn. Việc bạn hiểu rõ thông tin trong tài liệu và/hoặc đơn yêu cầu này rất quan trọng, và chúng tôi sẽ cung cấp thông tin bằng ngôn ngữ bạn muốn mà không tính phí. Nếu quý vị cần những dịch vụ này, vui lòng liên lạc với chúng tôi theo địa chỉ **cc@boston.gov** hoặc số điện thoại 617-635-3850.

Simplified Chinese:

非常重要!这份文件或是申请表格包含关于您的权利,责任,和/或福利的重要信息。请您务必完全理解这份文件或申请表格的全部信息,这对我们来说十分重要。我们会免费给您提供翻译服务。如果您有需要请联系我们的邮箱 cc@boston.gov 电话# 617-635-3850.

CITY of BOSTON

Cape Verdean Creole:

INPURTANTI! Es dukumentu ó aplikason ten <u>informason inpurtanti</u> sobri bu direitus, rasponsabilidadis i/ó benefisius. Ê krusial ki bu intendi informason na es dukumentu i/ó aplikason ó nu ta da informason na língua di bu preferênsia sen ninhun kustu pa bó. Si bu prisiza del, kontata-nu na cc@boston.gov ó 617-635-3850.

Arabic:

مهم! يحتوي هذا المستند أو التطبيق على معلومات مهمة حول حقوقك ومسؤولياتك أو فوائدك. من الأهمية أن تفهم المعلومات الواردة في هذا المستند أو التطبيق. سوف نقدم المعلومات بلغتك المفضلة دون أي تكلفة عليك. إذا كنت في حاجة إليها، يرجى الاتصال بنا على cc@boston.gov أو.635-3850 أو.cd

Russian:

ВАЖНО! В этом документе или заявлении содержится **важная информация** о ваших правах, обязанностях и/или льготах. Для нас очень важно, чтобы вы понимали приведенную в этом документе и/или заявлении информацию, и мы готовы бесплатно предоставить вам информацию на предпочитаемом вами языке. Если Вам они нужны, просьба связаться с нами по адресу электронной почты <u>cc@boston.gov</u>, либо по телефону 617-635-3850. Portuguese:

IMPORTANTE! Este documento ou aplicativo contém <u>Informações importantes</u> sobre os seus direitos, responsabilidades e/ou benefícios. É importante que você compreenda as informações contidas neste documento e/ou aplicativo, e nós iremos fornecer as informações em seu idioma de preferência sem nenhum custo para você. Se precisar deles, fale conosco: <u>cc@boston.gov</u> ou 617-635-3850.

French:

IMPORTANT! Ce document ou cette demande contient des <u>informations importantes</u> concernant vos droits, responsabilités et/ou avantages. Il est essentiel que vous compreniez les informations contenues dans ce document et/ou cette demande, que nous pouvons vous communiquer gratuitement dans la langue de votre choix. Si vous en avez besoin, veuillez nous contacter à <u>cc@boston.gov</u> ou au 617-635-3850.







NOTIFICACIÓN PARA PROPIETARIOS Y/O VECINOS COLINDANTES COMISIÓN DE CONSERVACIÓN DE BOSTON

De conformidad con la Ley de protección de los humedales de Massachusetts, el Capítulo 131, Sección 40 de las Leyes Generales de Massachusetts y la Ordenanza sobre los humedales de Boston, por la presente queda usted notificado como propietario o vecino colindante de un proyecto presentado ante la Comisión de Conservación de Boston.

A. <u>Pilot House Properties LLC</u> ha presentado una solicitud a la Comisión de Conservación de Boston pidiendo permiso para modificar una zona sujeta a protección en virtud de la Ley de protección de los humedales (Leyes generales, capítulo 131, sección 40) y la Ordenanza sobre los humedales de Boston.
B. La dirección del lote donde se propone la actividad es <u>1 Eastern Avenue, Boston, MA 02110</u>
C. El proyecto consiste en el reemplazo y mantenimiento de una plataforma flotante existente sostenida por pilares. La plataforma flotante de Sargent s Wharf se emplea como una de las paradas designadas para el T.
D. Se pueden obtener copias del Aviso de Intención comunicándose con la Comisión de Conservación de Boston en <u>CC@boston.gov</u> .
E. Las copias de la notificación de intención pueden obtenerse en <u>TRC Environmental Corporation</u> a hfisher@trccompanies.com _ entre las 9 AM y las 5 PM _, de lunes a viernes

- F. De acuerdo con el Capítulo 107 de las Actas de 2022, la audiencia pública se llevará a cabo virtualmente en https://zoom.us/j/6864582044. Si no puede acceder a Internet, puede llamar al 1-929-205-6099, ingresar ID de reunión 686 458 2044 # y usar # como su ID de participante.
- G. La información relativa a la fecha y hora de la audiencia pública puede solicitarse a la **Comisión** de Conservación de Boston por correo electrónico a <u>CC@boston.gov</u> o llamando al (617) 635-4416 entre las 9 AM y las 5 PM, de lunes a viernes.

NOTA: La notificación de la audiencia pública, incluida su fecha, hora y lugar, se publicará en el **Boston Herald** con al menos cinco (5) días de antelación.

NOTA: La notificación de la audiencia pública, incluida su fecha, hora y lugar, se publicará en www.boston.gov/public-notices y en el Ayuntamiento de Boston con no menos de cuarenta y ocho (48) horas de antelación. Si desea formular comentarios, puede asistir a la audiencia pública o enviarlos por escrito a CC@boston.gov o al Ayuntamiento de Boston, Departamento de Medio Ambiente, Sala 709, 1 City Hall Square, Boston, MA 02201.

NOTA: También puede comunicarse con la Comisión de Conservación de Boston o con la Oficina Regional del Noreste del Departamento de Protección Ambiental para obtener más información sobre esta solicitud o la Ley de Protección de Humedales. Para comunicarse con el DEP, llame a la Región Noreste: (978) 694-3200.





NOTA: si tiene previsto asistir a la audiencia pública y necesita servicios de interpretación, sírvase informar al personal en CC@boston.gov antes de las 12 PM del día anterior a la audiencia.



August, 17, 2022

The Cross Cultural Communication Systems, Inc., hereby certify, that this is a true translation of the document: Project Description - English Text-Pile Held Floats, with 27 English words, from English into Spanish, under project number TSP 08162201, requested by Heidi Fisher from TRC Environmental Solutions.

It was prepared to the best of the company's ability, this 17 days of august, 2022.

Cross Cultural Communication Systems, Inc. TM

Embracing linguistic and cultural connections!

Providing 24/7 language solutions.

Al. Donate

Alcionei Donato

Translation Services Quality Assurance Manager

CCCS, Inc. TM

PO Box 2308

Woburn, MA 01888

P: (781) 729-3736 X 108 F: (781) 729-1217

P: (888) 678-CCCS X 108 (out of state)

E: Adonato@embracingculture.com



Project Narrative



1.0 Introduction

TRC Environmental Corporation (TRC) has prepared this Notice of Intent (NOI) on behalf of Pilot House Properties, LLC (Pilot House) and the Boston Planning and Development Agency (BPDA) to request an Order of Conditions from the Boston Conservation Commission for the replacement of an existing float servicing the Boston Harbor water taxi. Pilot House intends to replace and maintain a pile-held float within the existing footprint (the Project) at Sargent's Wharf in the Boston Inner Harbor (the Project Site or Site). This NOI seeks approval to maintain the existing ramp and float structure, and replace the piles and float in kind.

The pile-held water taxi float is located to the east of Sargent's Wharf, which is between Union Wharf and Lewis Wharf in Boston's historic North End neighborhood. This area was historically used for the delivery of goods transported by sea to the colonial Province of Massachusetts Bay.

Today, the dock at Sargent's Wharf serves as one of the pick-up and drop-off locations for the Boston Water Taxi, a water taxi service that transports passengers to several locations around Boston Harbor, such as Logan Airport and the Charlestown Navy Yard. The Boston Water Taxi service owns a variety of vessels of varying capacities, which may transport up to 25-40 passengers per vessel.

2.0 Existing Conditions

The Project Site consists of an existing floating pile-held dock, three steel pipe piles, and aluminum gangway ramp. The dock system is located to the east of the Sargent's Wharf public parking lot. Both the parking lot and the dock system are part of a parcel that is owned by the Boston Planning and Development Agency (BPDA). Pilot House maintains the taxi dock pursuant to an agreement with the BPDA. The seaward boundary of the parking lot includes a paved walkway, which is part of Boston's Harborwalk, a walking trail along Boston's shoreline that includes several historic and notable locations. The pier leading down to the aluminum ramp includes a lookout spot to the Boston Harbor, and is located north of the Boston Sailing Center.

The Project Site is also located adjacent to several residential apartments and condos, including the condominium complex north of the Project Site at Union Wharf. The Abutter Mailing List Generator provided by the City of Boston Assessing Department generated a list of over six hundred properties abutting the Sargent's Wharf parking lot and dock system parcel. TRC used GIS to generate a list of properties located within 300 FT of the existing dock to gain a more accurate list of property owners in proximity to the Project. A picture of the circle drawn in GIS to create a 300 FT snap to the dock is included with the abutter notification materials following this Project narrative.

The ramp and float structure was built in approximately 1999-2000. As described below, the ramp and float structure received a Chapter 91 license on March 3, 1999. As part of that approval, an Order of Conditions would have been required. The Applicant has reviewed records from the



Suffolk County Registry of Deeds, Boston Conservation Commission (including archive files and consultation with the Conservation Agent), BPDA, and Massachusetts Department of Environmental Protection to search for an Order of Conditions, but has been unable to locate one. However, based on the fact that a Chapter 91 license was issued in 1999, and after discussion with staff at the BPDA, the Applicant believes that an Order of Conditions would have been issued. The pile-held floats and the three piles have reached the end of their service life.

The Project Site is limited to the footprint of the pile-held float and its piles. The Project is limited to replacement of these components and does not include any landside work.

2.1 Protected Resources under the Massachusetts Protection Act

Wetland resource areas that fall under the jurisdiction of the Massachusetts Wetland Protection Act (WPA) occur within and adjacent to the Project Site. Wetland resource area boundaries are shown on Figure 2. These resource areas include Land Under the Ocean and Land Subject to Coastal Storm Flowage. The Project Site is not located in a Designated Port Area. Projections for sea level rise as they affect these resource areas have been taken into consideration in the project design. These areas are described in greater detail in Section 4.1.

2.2 Protected Resources under the Boston Wetlands Ordinance

In addition to the resource areas that are protected under WPA, the Project Site is also subject to the protection of the Coastal Flood Resilience Zone (CFRZ) under the City of Boston Wetlands Ordinance (7.1.4(g)(ix)). This resource area is featured in Figure 2.

2.3 Chapter 91 Licensing Status

The existing pile-held float and ramp are fully authorized under MGL Chapter 91. The Massachusetts Department of Environmental Protection (MassDEP) issued License No. 7460 to the Boston Redevelopment Authority (now known as BPDA) on March 3, 1999 for an unlimited term. A maintenance letter will be submitted to the MassDEP Waterways office prior to this submittal describing the in-kind replacement of the existing pile-held float and piles.

3.0 Project Description

The proposed in-kind float replacement will entail the replacement of the existing pile-held float with a design that will occupy an identical footprint (30 feet by 10 feet). The Project has two components: (A) the replacement of existing piles with three (3) new 14-inch wide steel piles with a cut off elevation of approximately 15.8 feet NAVD88 (21 feet MLW), which will occupy an identical footprint to the existing piles, and (B) the replacement of the existing float with a new float.

The proposed improvements are planned to be made as soon as an Order of Conditions is issued and the necessary materials can be delivered to the site. Construction will be accomplished via equipment that will be transported to the site and operated from a barge.



The Project is limited to replacement of these components and does not include any landside repairs or improvements. Therefore, the Project is not located within any resource areas landward of the Project Site (such as the waterfront area, etc.) or any of their associated buffer zones.

4.0 Regulatory Compliance

Several wetland resource areas that fall under the jurisdiction of the Wetlands Protection Act and the Boston Wetlands Ordinance occur within and adjacent to the Project Site as previously described. Wetland resource area boundaries are shown on Figure 2. Wetland resource areas present in and around the Project Site are described in the sections below.

Since the work will occur within jurisdictional wetland resource areas, the Project is subject to the Massachusetts WPA (M.G.L. c. 131 § 40) and its implementing regulations (310 CMR 10.00) as well as the City of Boston Ordinance Protecting Local Wetlands and Promoting Climate Change Adaptation in the City of Boston (Ordinance 7.1.4 - Wetlands Protection and Climate Adaptation). The Project has been designed to comply with the relevant performance standards for the resource areas present at the Project Site.

4.1 Wetlands Protection Act

4.1.1 Land Under the Ocean

Per 310 CMR 10.25(2), Land Under the Ocean is defined as land extending from the MLW line seaward to the boundary of the municipality's jurisdiction and includes land under estuaries.

The existing float occupies approximately 305 square feet (SF) of Land Under the Ocean—300 SF occupied by the float and approximately 5 SF occupied by the three, 14 inch piles. The new float and piles are designed to occupy the same dimensions.

The extraction of the existing piles and the vibratory driving of the new piles, while within the same footprint, could result in impacts to benthic habitats and organisms in the immediate vicinity; however, these impacted areas are small relative to the surrounding benthic habitat. Non-motile organisms may be directly impacted, but these impacts are expected to be minor. Mobile species are anticipated to avoid the area during pile driving activities. Pile driving activities will occur within the Division of Marine Fisheries sanctioned Time of Year (TOY) restrictions. The TOY for the Project Area is February 15 through November 15. Construction activities will occur outside of this window.

The installation of the piles will result in temporary sediment dispersion in the immediate vicinity of the Project. Due to the regular tidal activity in this area, it is not anticipated that pile driving will result in any significant sediment dispersion to areas beyond the Project boundaries. However, construction crews will adhere to best management practices (BMPs), which may include but are not limited to:

extraction of old piles entirely by pulling,



- use of turbidity curtains about the Project boundary that rests on the mudline at all times (if work operations and currents allow them to be effective),
- o driving shall be without interruption to required tip elevation,
- o restricting the practice of manipulating piles to force them into position,
- piles shall be driven at the center of the pile bracket and shall be plumb their entire length above the mudline,
- maximum driving energy of the pile hammer shall be operated at the rate recommended by the manufacturer, and
- the driving helmet shall be fitted snugly to distribute energy evenly to the head of the pile.

Land Under the Ocean Performance Standards

310 CMR 10.25(5): "Projects not included in 310 CMR 10.25(3) [improvement dredging for navigational purposes] or (4) [maintenance dredging for navigational purposes] which affect nearshore areas of land under the ocean shall not cause adverse effects by altering the bottom topography so as to increase storm damage or erosion of coastal beaches, coastal banks, coastal dunes, or salt marshes."

The Project has been designed and will be conducted to avoid adverse effects to other resource areas. Bottom topography will not be altered as a result of the construction activities. Impacts to Land Under the Ocean includes pile driving within the same footprint as the existing piles. This will not increase storm damage or erosion of nearby resource areas. Pile driving is less disruptive to bottom sediments than a jetting installation alternative.

310 CMR 10.25(6): "Projects not included in 310 CMR 10.25(3) [improvement dredging] which affect land under the ocean shall if water-dependent be designed and constructed, using best available measures, so as to minimize adverse effects, and if non-water-dependent, have no adverse effects, on marine fisheries habitat or wildlife habitat caused by:"

- (a) "alterations in water circulation;"
- (b) "destruction of eelgrass (Zostera marina) or widgeon grass (Rupia maritina) beds;"
- (c) "alterations in the distribution of sediment grain size;"
- (d) "changes in water quality, including, but not limited to, other than natural fluctuations in the level of dissolved oxygen, temperature or turbidity, or the addition of pollutants;" or
- (e) "alterations of shallow submerged lands with high densities of polychaetes, mollusks or macrophytic algae."



The Project is water-dependent and involves the replacement of an existing pile-held float and its piles. The new float and piles will not alter water circulation since they will be the same as those that have existed at the Project Site for over 20 years.

There are no known eelgrass or widgeon grass beds within the Project Site or immediate vicinity.

The Project will not alter the distribution of sediment grain size. Pile removal and driving activities will result in minimal, temporary sediment dispersion within the immediate vicinity of the pile. However, the Boston Inner Harbor is subject to regular tidal fluctuations and currents, and pile driving activities for three piles are not anticipated to increase sediment dispersion or impair water quality in the Project Site or immediate vicinity.

There are no known high densities of polychaetes, mollusks, or macrophytic algae in the Project Site. The Project Area is not mapped by the Division of Marine Fisheries as suitable habitat for any harvestable shellfish species. Therefore, the Project will not alter or impact these habitats or species.

310 CMR 10.25(7): "Notwithstanding the provisions of 310 CMR 10.25(3) through (6), no project may be permitted which will have any adverse effect on specified habitat sites of rare vertebrate or invertebrate species, as identified by procedures established under 310 CMR 10.37."

The Project is not located within NHESP-mapped habitat areas (Figure 3). Therefore, impacts to listed species from in-water work affecting Land Under the Ocean resource area are not anticipated.

4.1.2 Land Subject to Coastal Storm Flowage

Per 310 CMR 10.04, Land Subject to Coastal Storm Flowage (LSCSF) means land subject to any inundation caused by coastal storms up to and including that caused by the 100-year storm, surge of record, or storm of record, whichever is greater.

The Project Site is located within LSCSF, or the 100-year floodplain. The FEMA Flood Insurance Rate Map (FIRM) for the proposed Project Site (map number 25025C0081J, effective date 03/16/2016) indicates that the Project Site is within Flood Zone VE, 100-year flood zone, with a Base Flood Elevation (BFE) of 13 feet NAVD88 (18.2 feet MLW).

The in-kind replacement float replacement and pile driving will not have any effect on coastal storm flowage. The Project is located entirely within a coastal waterbody, therefore the Project will have no impact on flooding of adjacent lands and structures due to storms, nor on the flood storage capacity of the area. As shown on the plans (Appendix A), the float has been designed such that the float will move up and down the piles with the changing water level. These allowances would minimize the potential for damage to adjacent structures from the dock in such a flooding event. To accommodate storm-induced water levels and in anticipation of projected sea level rise, the tops of the proposed mooring piles will be cut off at an elevation of



approximately 15.8 feet NAVD88 (21 feet MLW) or higher to secure the piles in place in the event water levels rise beyond 13 feet NAVD88 (18.2 feet MLW, the FEMA VE Zone BFE listed above) and 14.3 feet NAVD88 (19.5 feet MLW, Coastal Flood Resilience Design Guidelines). Therefore, the Project is not anticipated to have an impact on LSCSF. While Land Subject to Coastal Storm Flowage is an Area Subject to Protection under the WPA, no performance standards for this area have been defined in the WPA regulations (see discussion of performance standards under the Boston Wetlands Ordinance below).

4.2 Boston Wetlands Protection Ordinance

4.2.1 Land Subject to Coastal Storm Flowage

4.2.1.1 Performance Standards – Boston Wetlands Regulations

Section XVII(E)(1): "When the Commission determines that LSCSF overlays or overlaps with other resource areas protected under the Ordinance, the applicable performance standards for each resource area shall be independently as well as collectively applied, and the project shall be conditioned to protect the Resource Area Values of all resource areas affected by the project and the ability of such other resource areas to protect the Resource Area Values described in Section XVII(A)."

The Project has been designed to account for the Resource Area Values of both Land Under the Ocean and Land Subject to Coastal Storm Flowage. Work within LSCSF will not interfere with the ability of Land Under the Ocean to protect Resource Area Values within that resource area, and vice versa. The Project is anticipated to have negligible to no effect on storm damage prevention, flood control, protection of wildlife and wildlife habitat, prevention of pollution, erosion and sedimentation control, and mitigation of the impacts of climate change.

Section XVII(E)(2): "If LSCSF affected by proposed activity or work is significant to the Resource Area Values described in Section XVII(A), such activity shall not have an adverse impact on the subject site, adjacent properties, properties located in the adjacent Coastal Flood Resilience Zone, or any public or private way by increasing the elevation or velocity of flood or storm waters or by increasing flows due to a change in drainage or flowage characteristics."

Not applicable. As a pile-held float, increases in water level from flooding events or sea level rise will not affect the float since it will rise and fall as water levels change. The three steel piles will be cut off at elevation 15.8 FT NAVD88, which is significantly higher than the base flood elevation.

Section XVII(E)(3): "If LSCSF is significant to flood control or storm damage prevention, the proposed activity or work shall not result in flood damage due to filling, which causes lateral displacement of flood waters that, in the judgment of the Commission, would otherwise be confined within said area. The Commission, in its sole discretion, may permit such activity so long as the activity will not have an adverse impact on said area's ability to provide storm damage prevention and flood control; provided, further, that the activity or work incorporate best



management practices to reduce or eliminate damage resulting from SLR and coastal storms."

Not applicable. See prior response regarding flood waters. Additionally, no filling is proposed and the waters of Boston Inner Harbor provide unrestricted flood storage capacity.

Section XVII(E)(4): "If LSCSF receives and holds coastal flood waters, the proposed activity or work shall not impact the ability of the area to receive, hold, and laterally spread flood waters if it causes unnatural redirection, refraction, diffraction, or reflection of coastal flood waters and waves."

Not applicable. The Project is located on Boston Inner Harbor. See prior responses regarding flood waters.

Section XVII(E)(5): "If LSCSF receives coastal flood waters that naturally flow across the landform surface without redirecting or channeling the flow, the proposed activity or work shall not cause flood water to become redirected or channeled or increase in velocity, so as to cause erosion, scour, and increased storm damage to the project's locus and adjacent areas."

Not applicable. Project is located entirely within Land Under the Ocean and does not involve landside work.

Section XVII(E)(6): "If LSCSF is significant to wildlife and their habitat, proposed activity or work shall not impair the capacity of those portions of LSCSF to provide important wildlife habitat functions."

Not applicable. Project is located entirely within Land Under the Ocean and does not involve landside work. Project will have no significant impact on wildlife or their habitat. See prior discussion of existing species in the Project Area and their habitats.

Section XVII(E)(7): "If LSCSF is significant to the prevention of pollution, proposed activity or work shall not have an adverse impact on the characteristic of the LSCSF to remove suspended solids and other contaminants from runoff before entering into other wetland resource areas or a body of water."

Not applicable. Project is located on Boston Inner Harbor and is subject to tidal action. As such, the LSCSF at the location of the pile-held float does not have the capacity to remove suspended solids and other contaminants from runoff before entering into other wetland resource areas or a body of water.

Section XVII(E)(8): "Proposed work or activity in LSCSF which results in alteration to vegetative cover, interruptions in the beneficial supply of sediment to other wetland resource areas, or changes to the form or volume of a dune or beach, and such result will have an adverse impact on said dune or beach's ability to provide storm damage prevention and flood control, is prohibited."



Not applicable. Project is located on Boston Inner Harbor and is subject to tidal action. As such, the Project will not result alteration to vegetative cover, interruptions in the beneficial supply of sediment to other wetland resource areas, or changes to the form or volume of a dune or beach.

Section XVII(E)(9): "Notwithstanding Sections XVII(E)(1) through (8), the Commission may, in its sole discretion, permit the following activities provided that the applicant demonstrates to the satisfaction of the Commission that best available measures, as defined by the Ordinance, are utilized to minimize or eliminate adverse impacts on the critical characteristics of and Resource Area Values protected by LSCSF described in Section XVII(A) herein, and provided further that all other performance standards for overlapping or overlaying wetland resource areas are met..."

Not applicable. The Project does not involve any of these actions.

Section XVII(E)(10): "In the interest of storm damage prevention, flood control, and prevention of pollution, should the Commission permit activity or work in LSCSF that is part of new construction or constitutes substantial improvement to an existing structure, the Commission may condition the permitted activity or work so that any critical building systems, infrastructure, or equipment is located two (2) feet above the anticipated BFE expected to occur within the next 50 years based on the best available data and projections of SLR."

Not applicable. The Project's pile-held float cannot be located two feet above the current or anticipated BFE.

Section XVII(E)(11): "When any proposed work or activity in LSCSF is located within an ACEC, the proposed work or activity shall have no adverse impact upon the Resource Area Values described in Section XVII(A) and shall fully mitigate any impacts resulting from the proposed work or activity."

Not applicable. Project is not located within an ACEC.

Section XVII(E)(12): "Section XVII(E)(11) shall supersede the provisions of Section XVII(E)(9)(i) through (viii), but it shall not apply if the presumption set forth in Section XVII(D) is overcome."

Not applicable.

Section XVII(E)(13): "Notwithstanding the provisions of Section XVII(E)(2) through (X), no project may be permitted which will have any adverse impact on specified habitat sites of rare vertebrate or invertebrate species indicated on the most recent Estimated Habitat Map of State-listed Rare Wetlands Wildlife (if any) published by the Massachusetts NHESP."

Not applicable. See Figure 3.

4.2.2 Climate Change Resilience

The Boston Wetland Ordinance requires that projects take into consideration the potential for



effects on the Project from projected sea level rise, changes in storm intensity and frequency, and other consequences of climate change may have on resource areas and the activities proposed in the permit application.

- Projected Sea Level Rise: As previously described, the pile cut-off elevations will be high
 enough to accommodate increases in water levels during storms or through sea level rise. If sea
 level rises to a point that it is adversely affecting the float at some time during the planned life of
 the float, additional length could be added to the piles or the piles replaced, to allow the float
 system to continue to operate.
- Changes in Storm Intensity/Frequency: The proposed float is located well into the Boston Inner Harbor, which provides some protection from larger waves. By replacing the existing float, which is reaching the end of its service life, with new materials, the float is expected to better handle changes in storm intensity/frequency that may occur over time.
- Increased/Decreased Precipitation: Potential increases or decreases in precipitation will not affect the pile-held float or its piles at Sargent's Wharf, nor will the proposed float contribute to such changes.
- Heat-Island Effect: The proposed float is identical in size to the existing float (10 feet by 30 feet) and is not expected to contribute to the heat-island effect.

4.2.3 Climate Equity and Environmental Justice

It is anticipated that the Project will in no way prevent any individual community from having access to Sargent's Wharf, nor will it place any undue environmental burden on any individual community during the construction and lifespan of the Project. In fact, the availability of the water taxi dock provides a means of access to the North End and downtown Boston from other parts of the Boston waterfront. The Project will improve the public's use of the Harbor for transportation purposes.

4.3 Massachusetts Stormwater Management Standards


The Project is not subject to the Massachusetts Stormwater Standards because the float replacement is located within Boston Inner Harbor at Sargent's Wharf. Therefore, the project does not require a stormwater management plan.


4.4 United States Army Corps of Engineers General Permit

The Project is eligible under the U.S. Army Corps of Engineers (USACE) New England District General Permit 1 for Maintenance (replacement of a currently serviceable structure). The Project does not require the submission of a Preconstruction Notification. A Self-verification notification describing the proposed work at Sargent's Wharf will be submitted to USACE concurrent with the submission of this NOI.



Figures

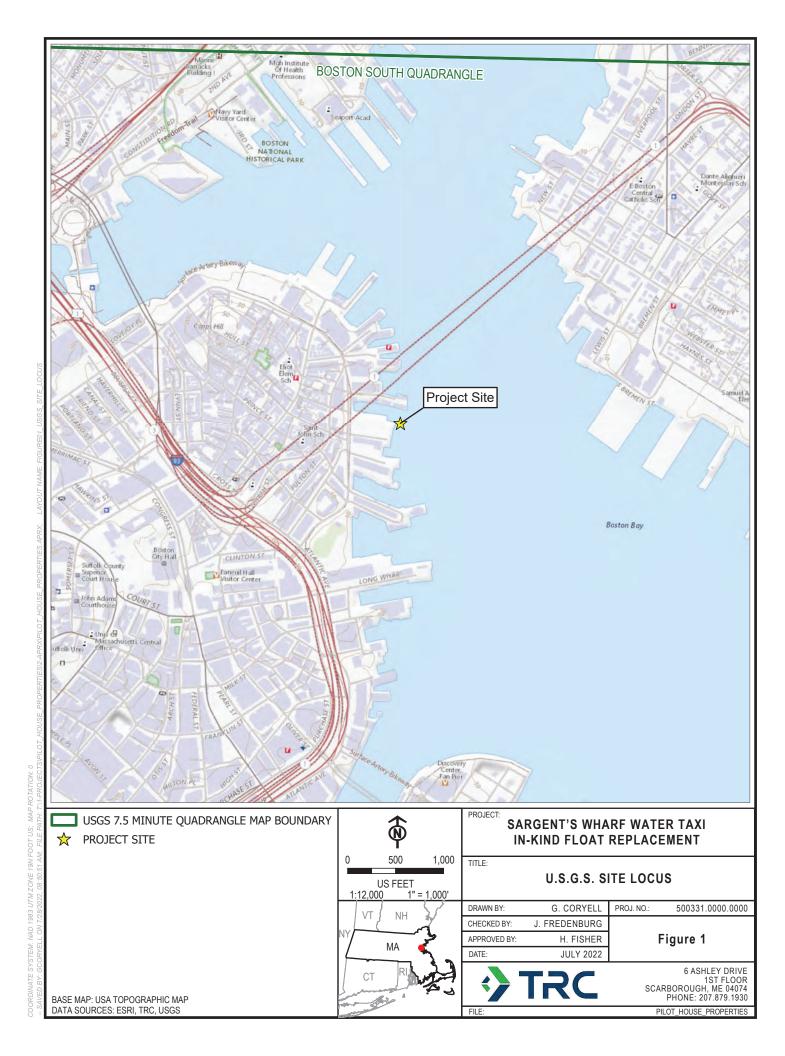

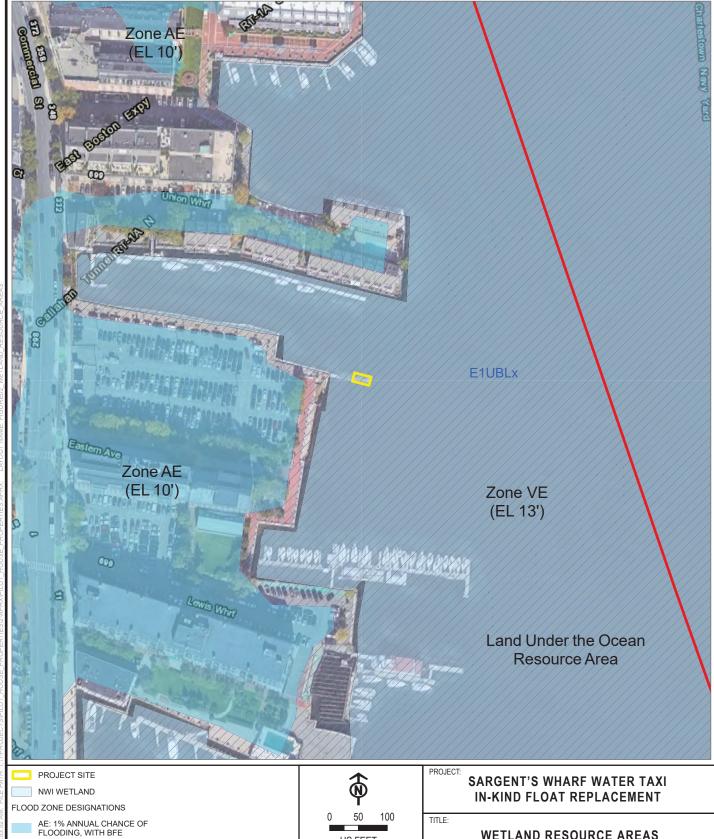



BASE MAP: GOOGLE SATELLITE DATA SOURCES: ESRI, TRC, USGS

VE: HIGH RISK COASTAL AREA SOUTH BOSTON DPA

US FEET

WETLAND RESOURCE AREAS

0510	DRAWN BY:	G. CORYELL	PROJ. NO.:	500331.0000.0000
EA.	CHECKED BY:	J. FREDENBURG		
9	APPROVED BY:	H. FISHER		Figure 2
	DATE:	JULY 2022		
Lav				6 ASHLEY DRIVE




1ST FLOOR SCARBOROUGH, ME 04074 PHONE: 207.879.1930 PILOT HOUSE PROPERTIES



NHESP ESTIMATED HABITATS OF RARE WILDLIFE



NHESP PRIORITY HABITATS OF RARE SPECIES

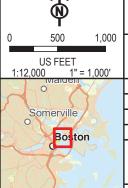

SARGENT'S WHARF WATER TAXI **IN-KIND FLOAT REPLACEMENT**

TITLE:
NHESP ESTIMATED HABITATS OF RARE WILDLIFE AND PRIORITY HABITATS OF RARE SPECIES

DRAWN BY:	G. CORYELL	PROJ. NO.:	500331.0000.0000
CHECKED BY:	J. FREDENBURG		
APPROVED BY:	H. FISHER		Figure 3
DATE:	JULY 2022		_



6 ASHLEY DRIVE 1ST FLOOR SCARBOROUGH, ME 04074 PHONE: 207.879.1930 PILOT HOUSE PROPERTIES

BASE MAP: GOOGLE SATELLITE DATA SOURCES: ESRI, TRC, USGS



Attachment A: Project Plans

SARGENT'S WHARF WATER TAXI IN-KIND DOCK REPLACEMENT PROJECT NOTICE OF INTENT PLANS

PROPERTY


SARGENT'S WHARF BOSTON, MA 02110

PREPARED FOR:

PILOT HOUSE PROPERTIES, LLC PILOT HOUSE - LEWIS WHARF BOSTON, MA 02110

NOVEMBER 2, 2022



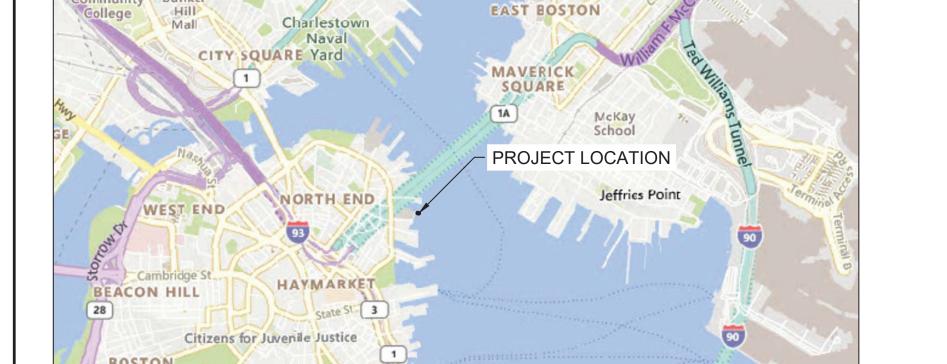

COMMON

ZE THEATRE

SQUARE

LOCATION MAP SCALE 1"=2000'

Boston Inner Harbor

PREPARED BY:



404 WYMAN STREET, SUITE 375 WALTHAM, MASSACHUSETTS 02451 P 781.419.7696


SHEET LIST TABLE


Sheet Number	Sheet Title
	COVER
C-1	EXISTING CONDITIONS
C-2	PROPOSED CONDITIONS
C-3	ELEVATION VIEW
	ATTACHMENTS
"WATER TAXI DOCK, I LLC. DATED MARCH 1	BOSTON, MA" BY BLUE ATLANTIC FABRICATORS, 16, 2022. *


"WATER TAXI DOCK - PILE GUIDES, BOSTON, MA" BY BLUE ATLANTIC FABRICATORS, LLC. DATED MARCH 18, 2022.

* PROJECT NORTH SHOWN ON THE ATTACHED DRAWINGS BY BLUE ATLANTIC FABRICATORS IS GEOGRAPHIC SOUTH

FOR PERMITTING PURPOSES ONLY

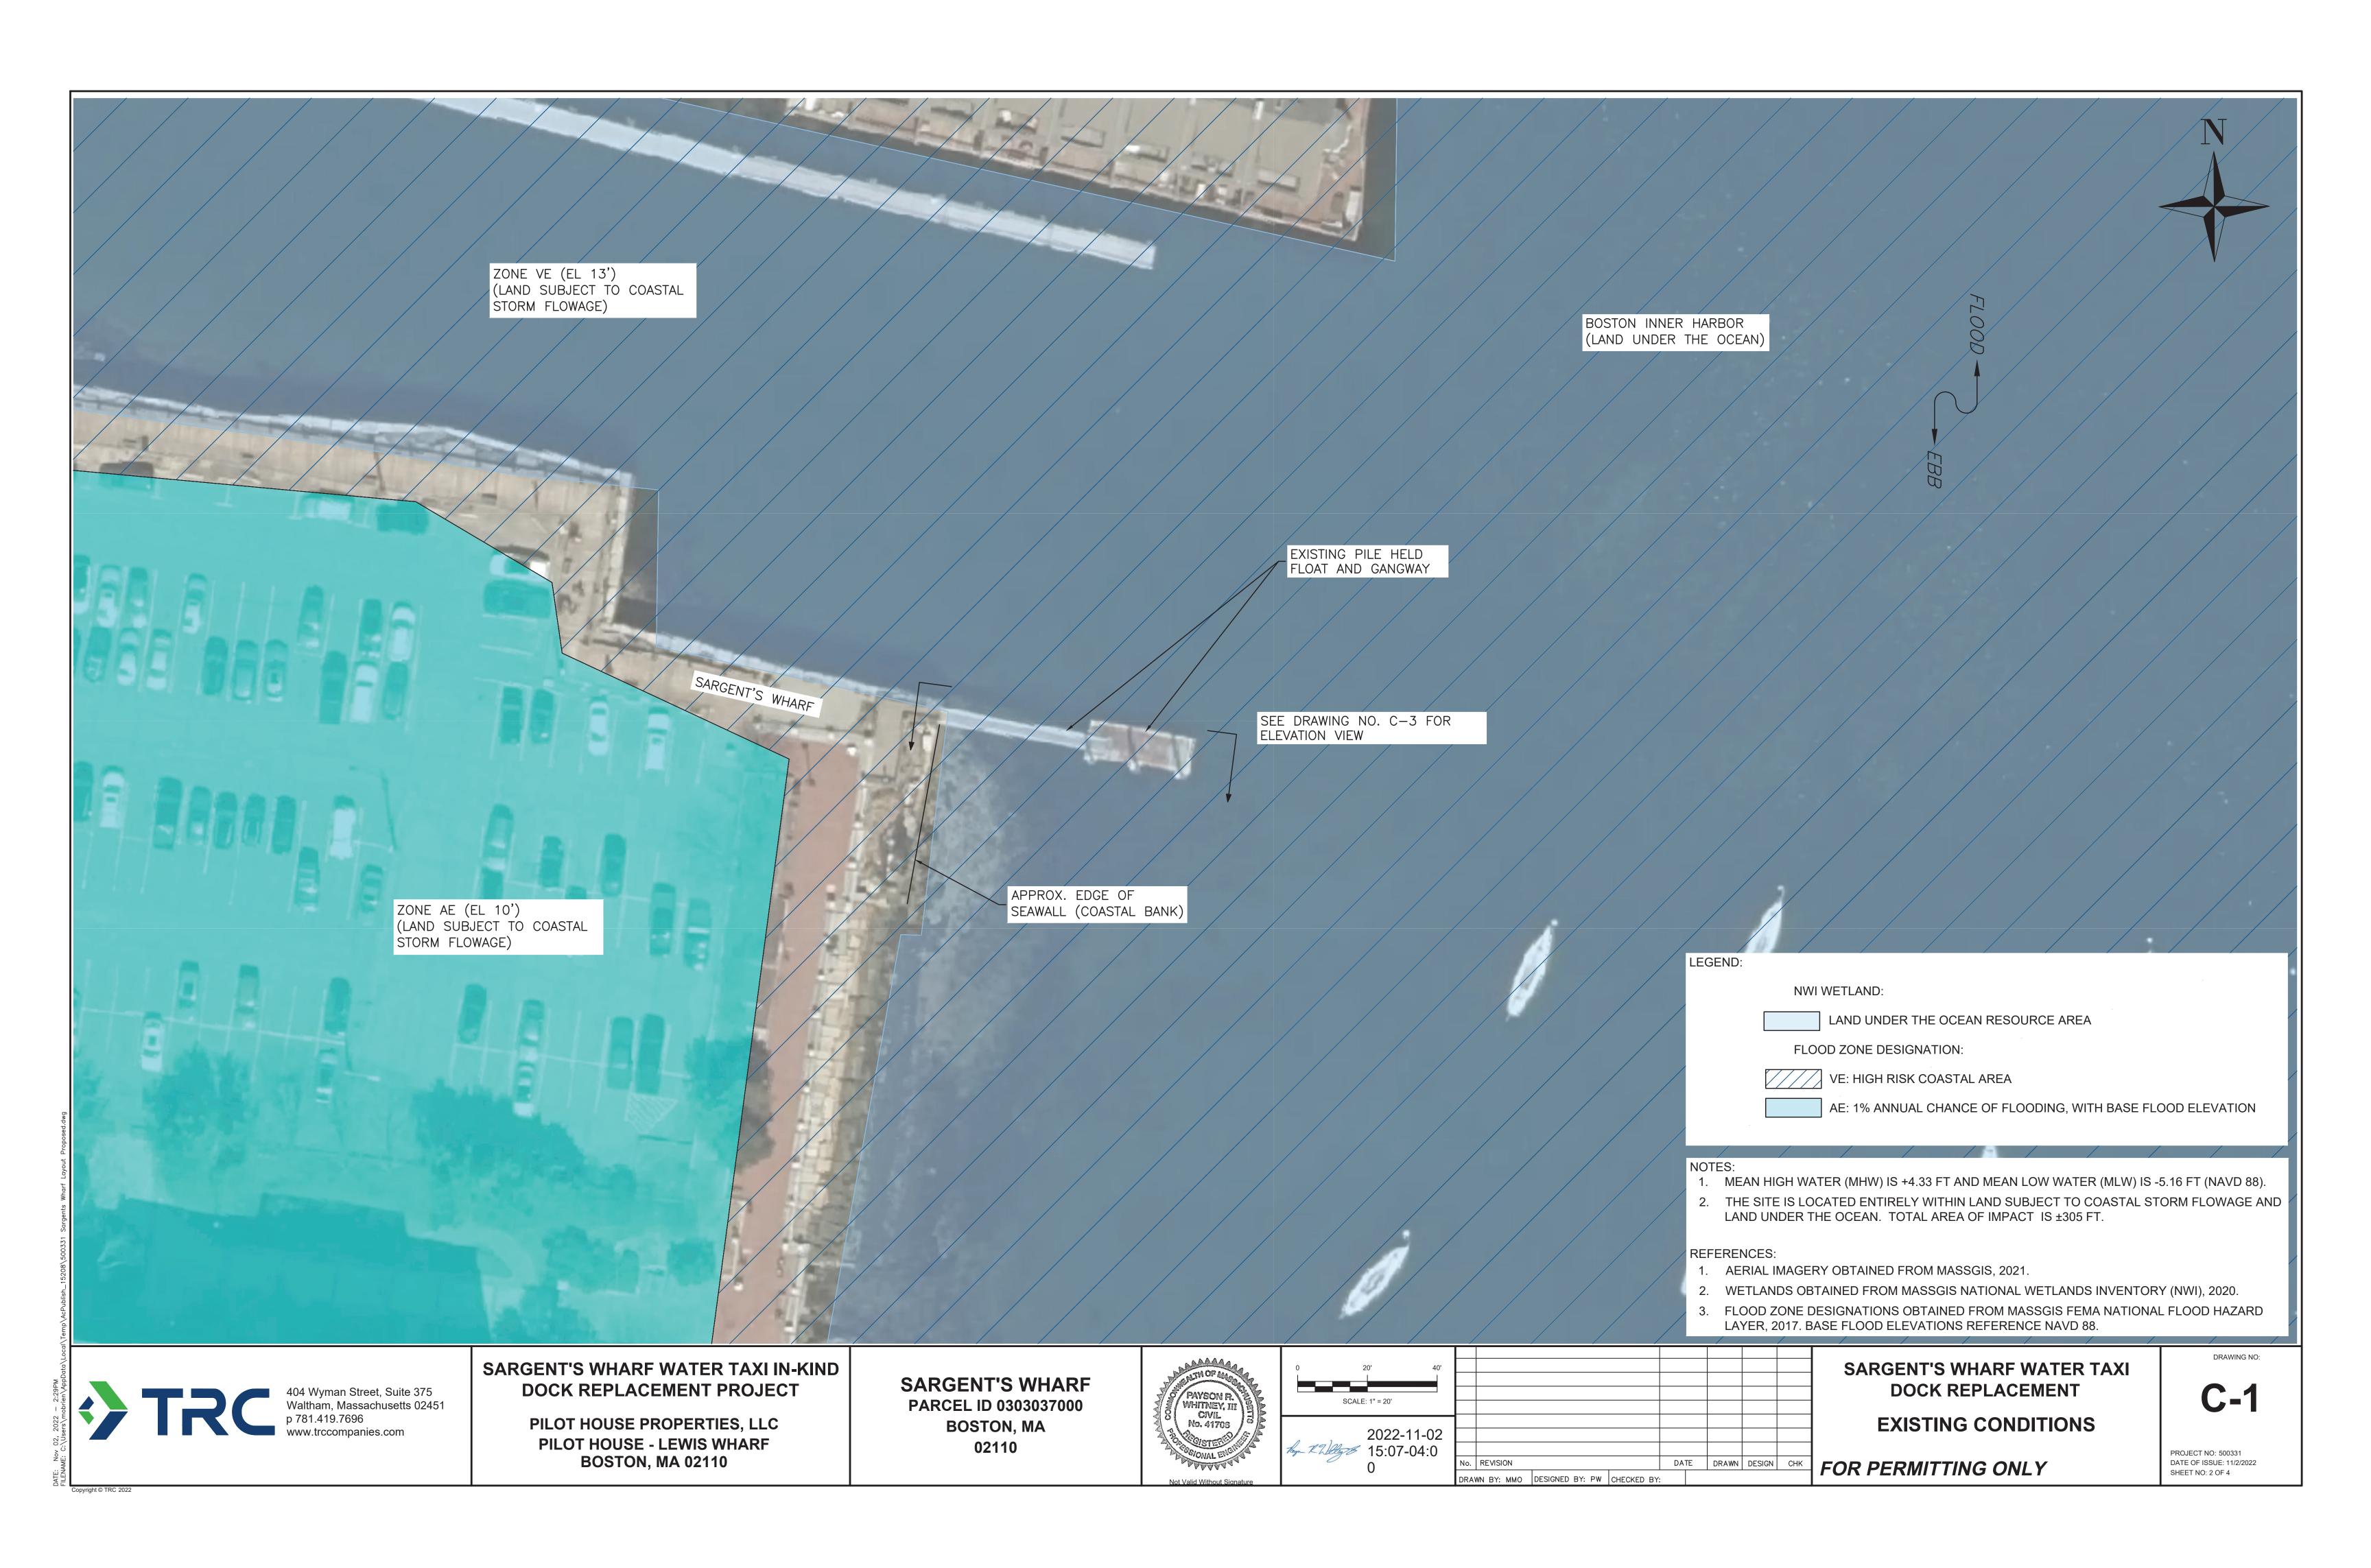

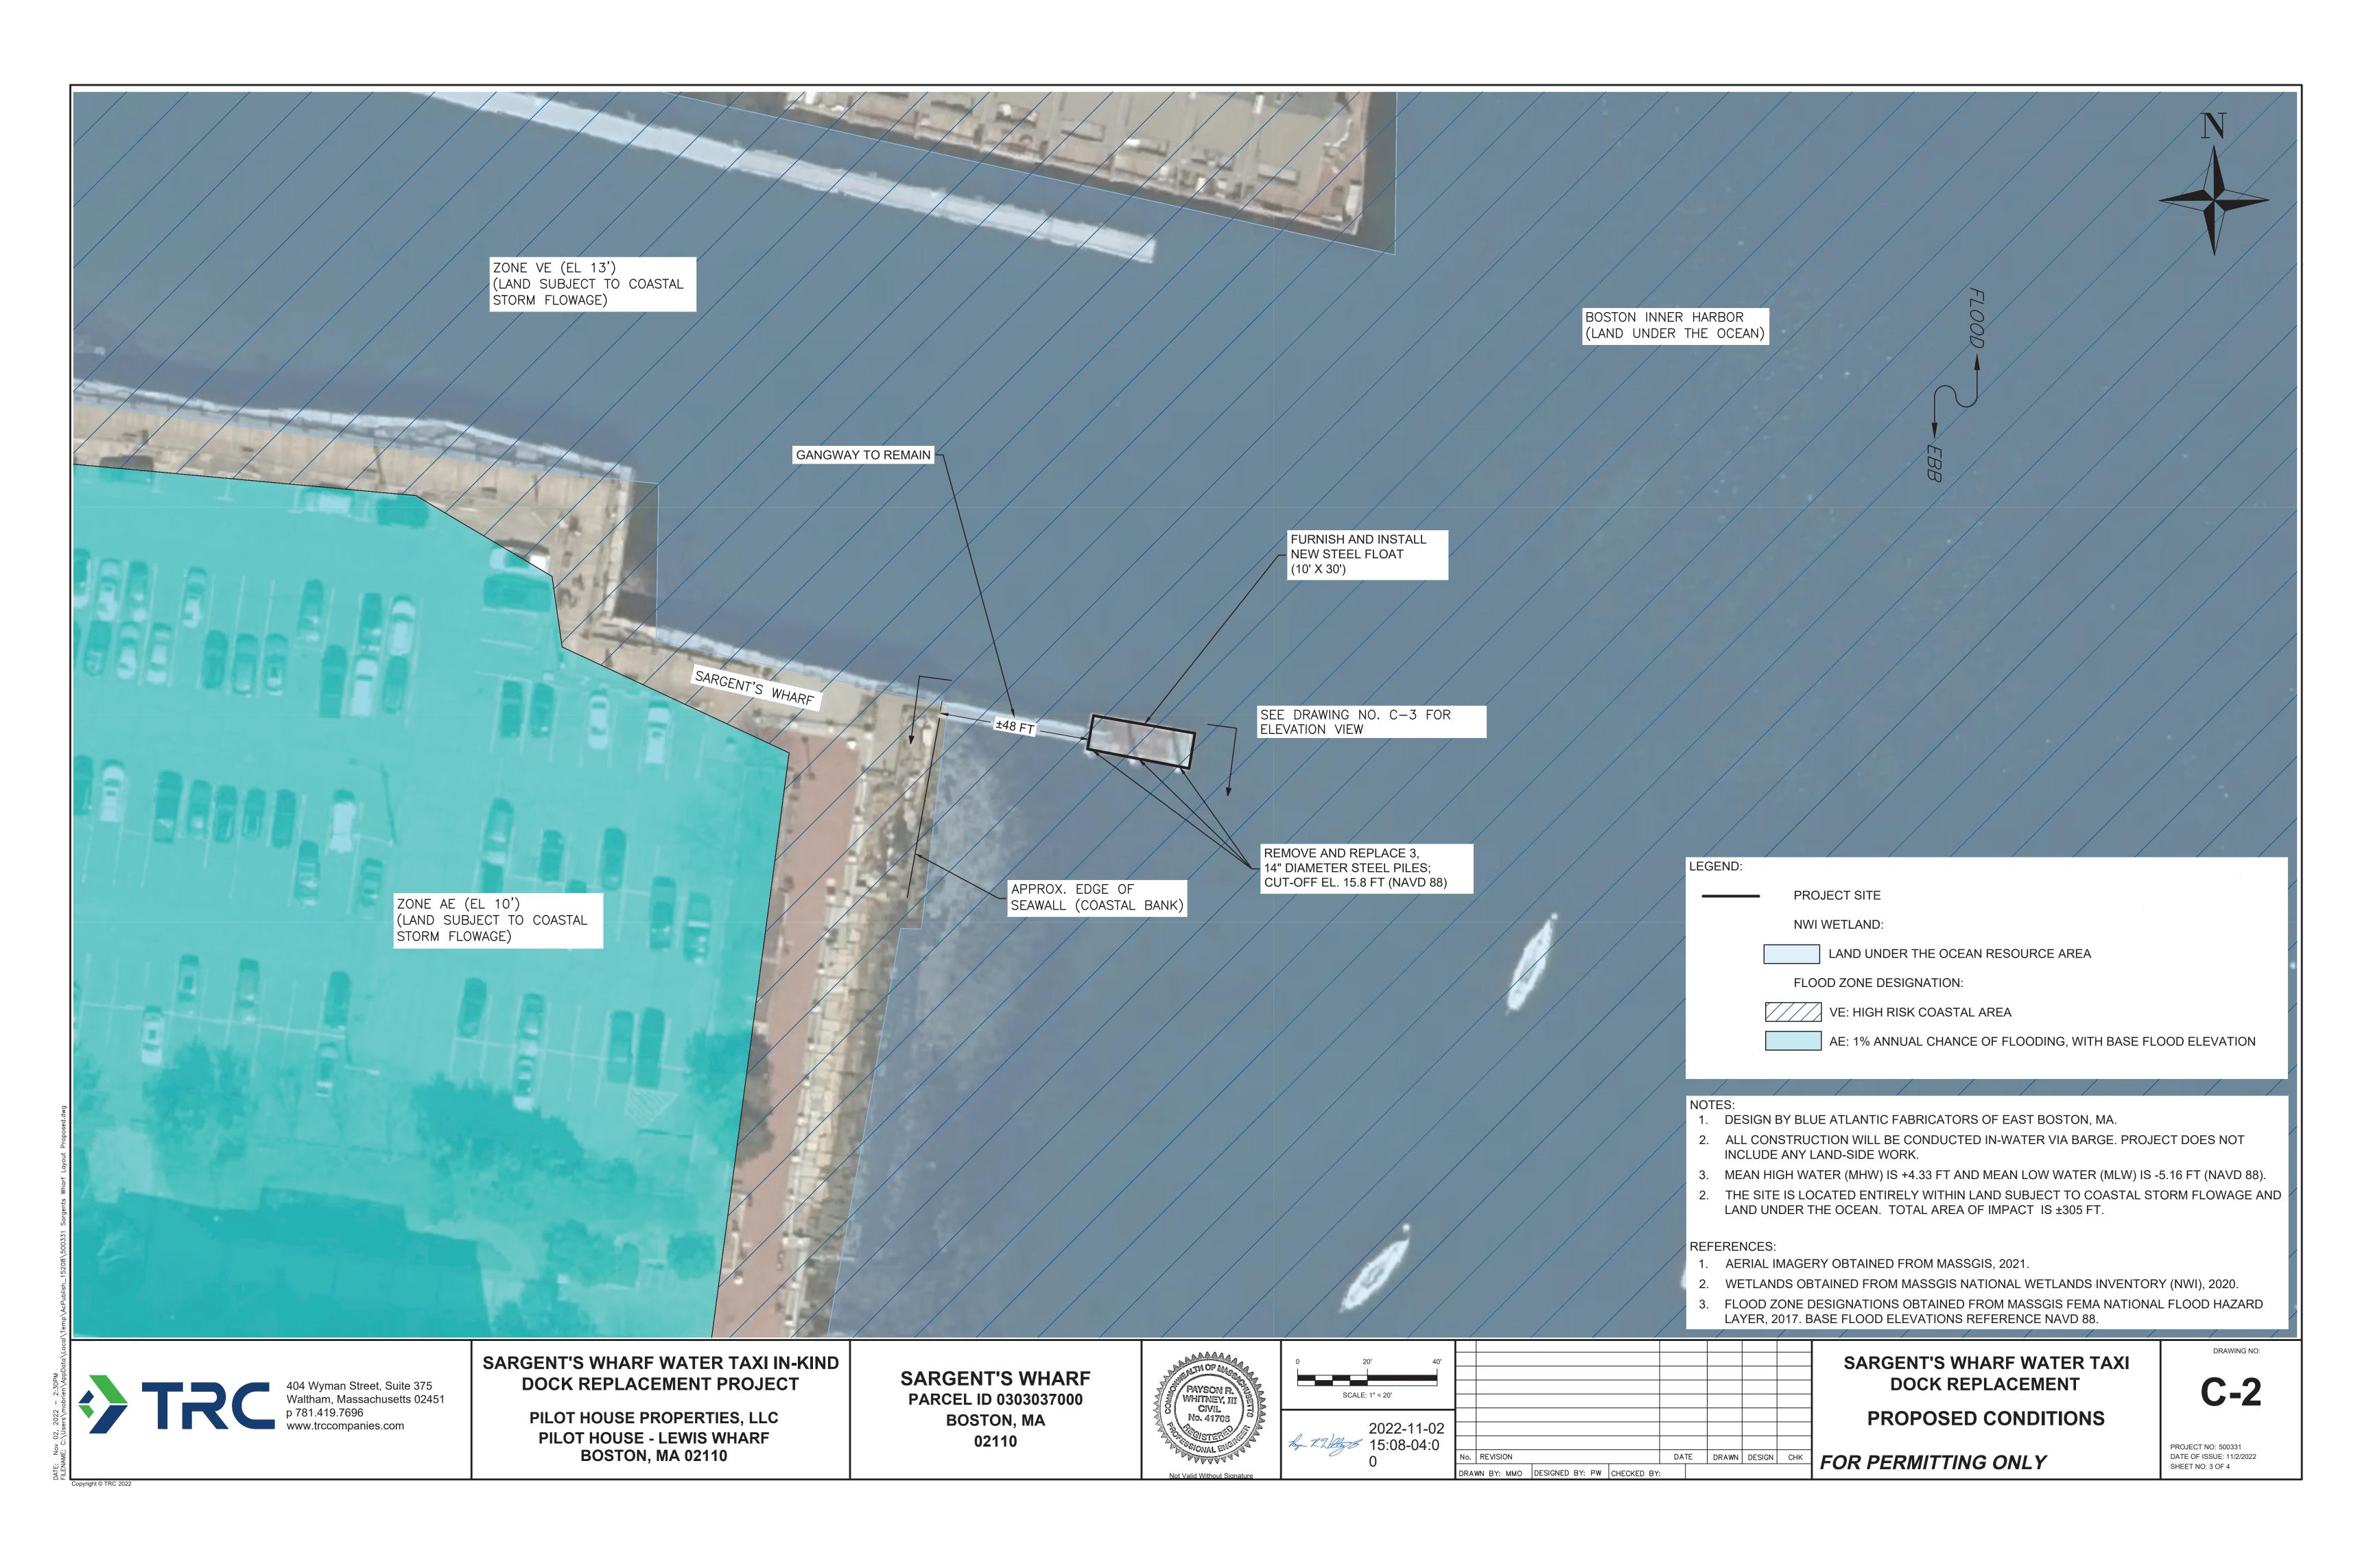

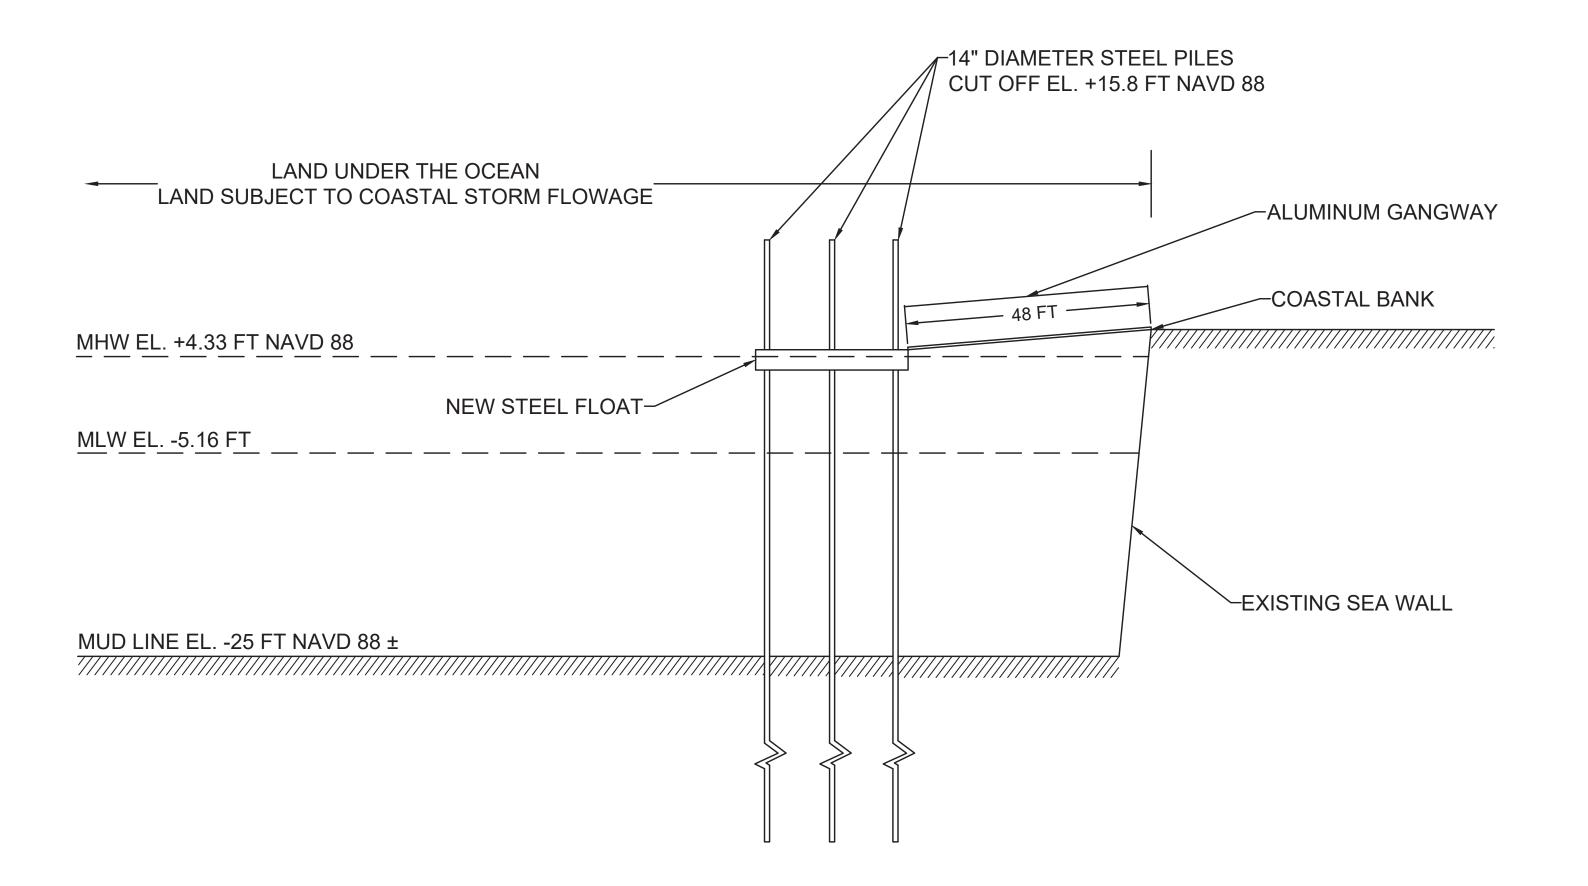

40 HORIZONTAL 20 VERTICAL

NOTES:
1. ELEVATIONS REFERENCE NAVD 88

SARGENT'S WHARF WATER TAXI IN-KIND DOCK REPLACEMENT PROJECT

> PILOT HOUSE PROPERTIES, LLC PILOT HOUSE - LEWIS WHARF **BOSTON, MA 02110**

SARGENT'S WHARF PARCEL ID 0303037000 BOSTON, MA 02110



A COLUMN TO THE PARTY OF THE PA						
	Payor L. D. May 18	2022-11-02 15:08-04:0				
		\cap	No.	REVISION		
ianature		O	DRAV	WN BY: MMO	DESIGNED BY: PW	CHECKED

SARGENT'S WHARF WATER TAXI **DOCK REPLACEMENT ELEVATION VIEW**

FOR PERMITTING ONLY

DATE DRAWN DESIGN CHK

C-3

DRAWING NO:

PROJECT NO: 500331 DATE OF ISSUE: 11/2/2022 SHEET NO: 4 OF 4

GENERAL FABRICATION NOTES

1. WORKMANSHIP:

WORKMANSHIP SHALL BE IN ACCORDANCE WITH LATEST EDITION OF 'STANDARD SPECIFICATIONS FOR HIGHWAY BRIDGES' ADOPTED BY THE AMERICAN ASSOCIATION OF STATE HIGHWAY AND TRANSPORTATION OFFICIALS (AASHTO), INCLUDING INTERIM SPECIFICATIONS, ABS, D1.1 WELDING CODE AND THE LATEST EDITION OF MASSDOT SECTION 960.

2. MATERIAL:

STRUCTURAL STEEL SHALL CONFORM TO ASTM A36 U.N.O. STRUCTURAL STEEL FOR HSS SHALL CONFORM TO ASTM A500B STRUCTURAL STEEL FOR PIPE SHALL CONFORM TO ASTM A53B

3. FASTENERS:

BOLTS, WELDED STUDS, NUTS AND WASHERS SHALL BE 18-8 OR TYPE 316 STAINLESS STEEL AS SHOWN ON THE DRAWINGS

4. WELDING:

WELDING SHALL BE IN ACCORDANCE WITH AWS D1.1 STRUCTURAL WELDING CODE. ALL GROVE WELDS PART OF HULL STRUCTURE SHALL BE CJP WELDS.

5. SURFACE PREPARATION AND PAINING:

INTERIOR: STEEL SHALL BE BLAST CLEANED TO SSPC-SP10 AND APPLIED ZINC PRE-CONSTRUCTION PRIMER

EXTERIOR: STEEL SHALL BE BLAST CLEANED PER SSPC-SP10 AND PRIMED WITH PRE-CONSTRUCTION PRIMER.

AFTER CONSTRUCTION, PREPARE SURFACES PER SSPC-SP1/SP2 AND APPLY (2) COATS OF MARINE EPOXY.

DECK SURFACE SHALL RECEIVE ALUMINUM OXIDE NON-SKID DECK UV RESISTANT "HAZE GRAY" FINISH COAT

6. TESTING:

AIR TESTS SHALL BE PERFORMED PER SPECIFICATIONS AND PER ABS **RULES**

7. CLASSING:

STEEL FLOAT SHALL NOT BE CLASSED

8. VENTING:

AT LEAST ONE VENT PER COMPARTMENT SHALL BE PROVIDED



GENERAL NOTES

 DRAWN BY:
 ID
 CHECKED BY:
 PA
 JOB NO.
 DWG. NO.

 DATE:
 3/15/2022
 DATE:
 3/16/2022
 22-03397
 G


GN1 0

DWG TITLE:

SHOP PAINT

WELDING CODE AWS D1.1

RADIUS ½" U.N.O.

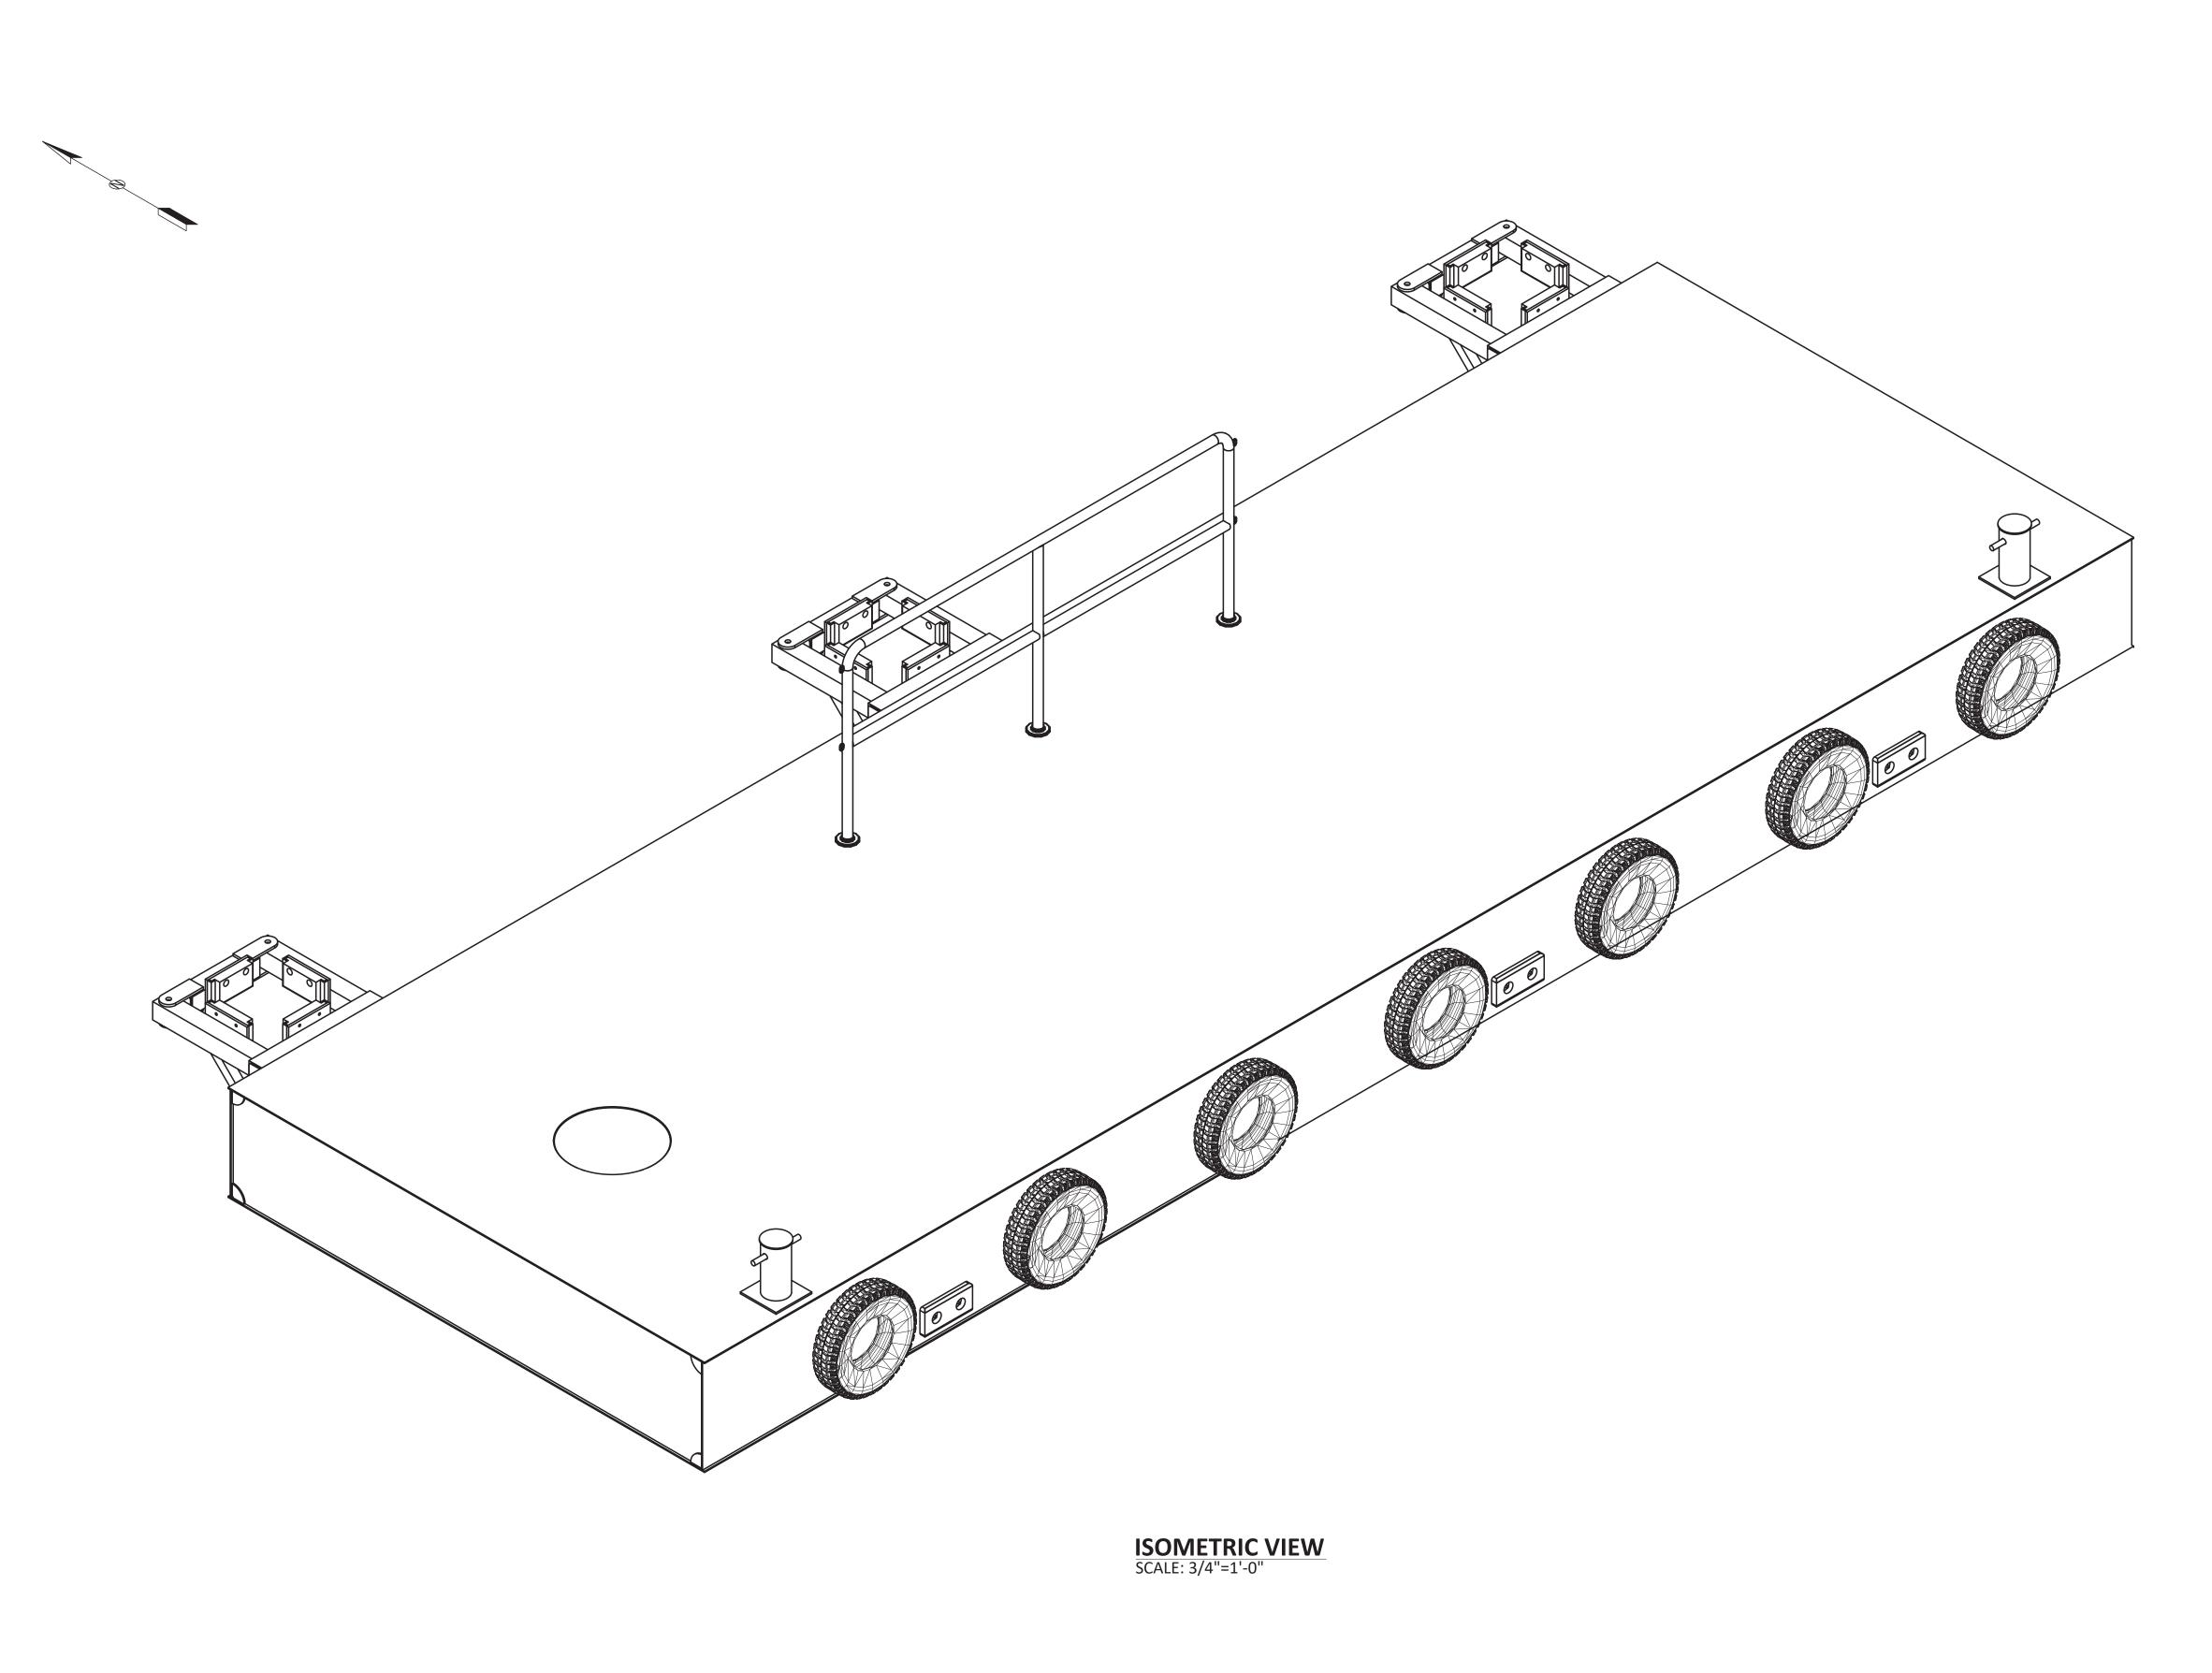


BLUE ATLANTIC FABRICATORS, LLC 256 MARGINAL ST EAST BOSTON, MA 02128 PROJECT NAME: WATER TAXI DOCK LOCATION: BOSTON, MA ARCHITECT: SURFACE PREP. PER GN1 BLUE ATLANTIC FABRICATORS, LLC ENGINEER: CUSTOMER: C. WHITE MARINE, INC. ELECTRODES E-70XX WELDING CODE AWS D1.1 RADIUS ½" U.N.O.

O DENOTES CONNECTION SIDE ID CHECKED BY: PA JOB NO. DWG. NO. E2


REVISION NOTE:

DATE:

REV:

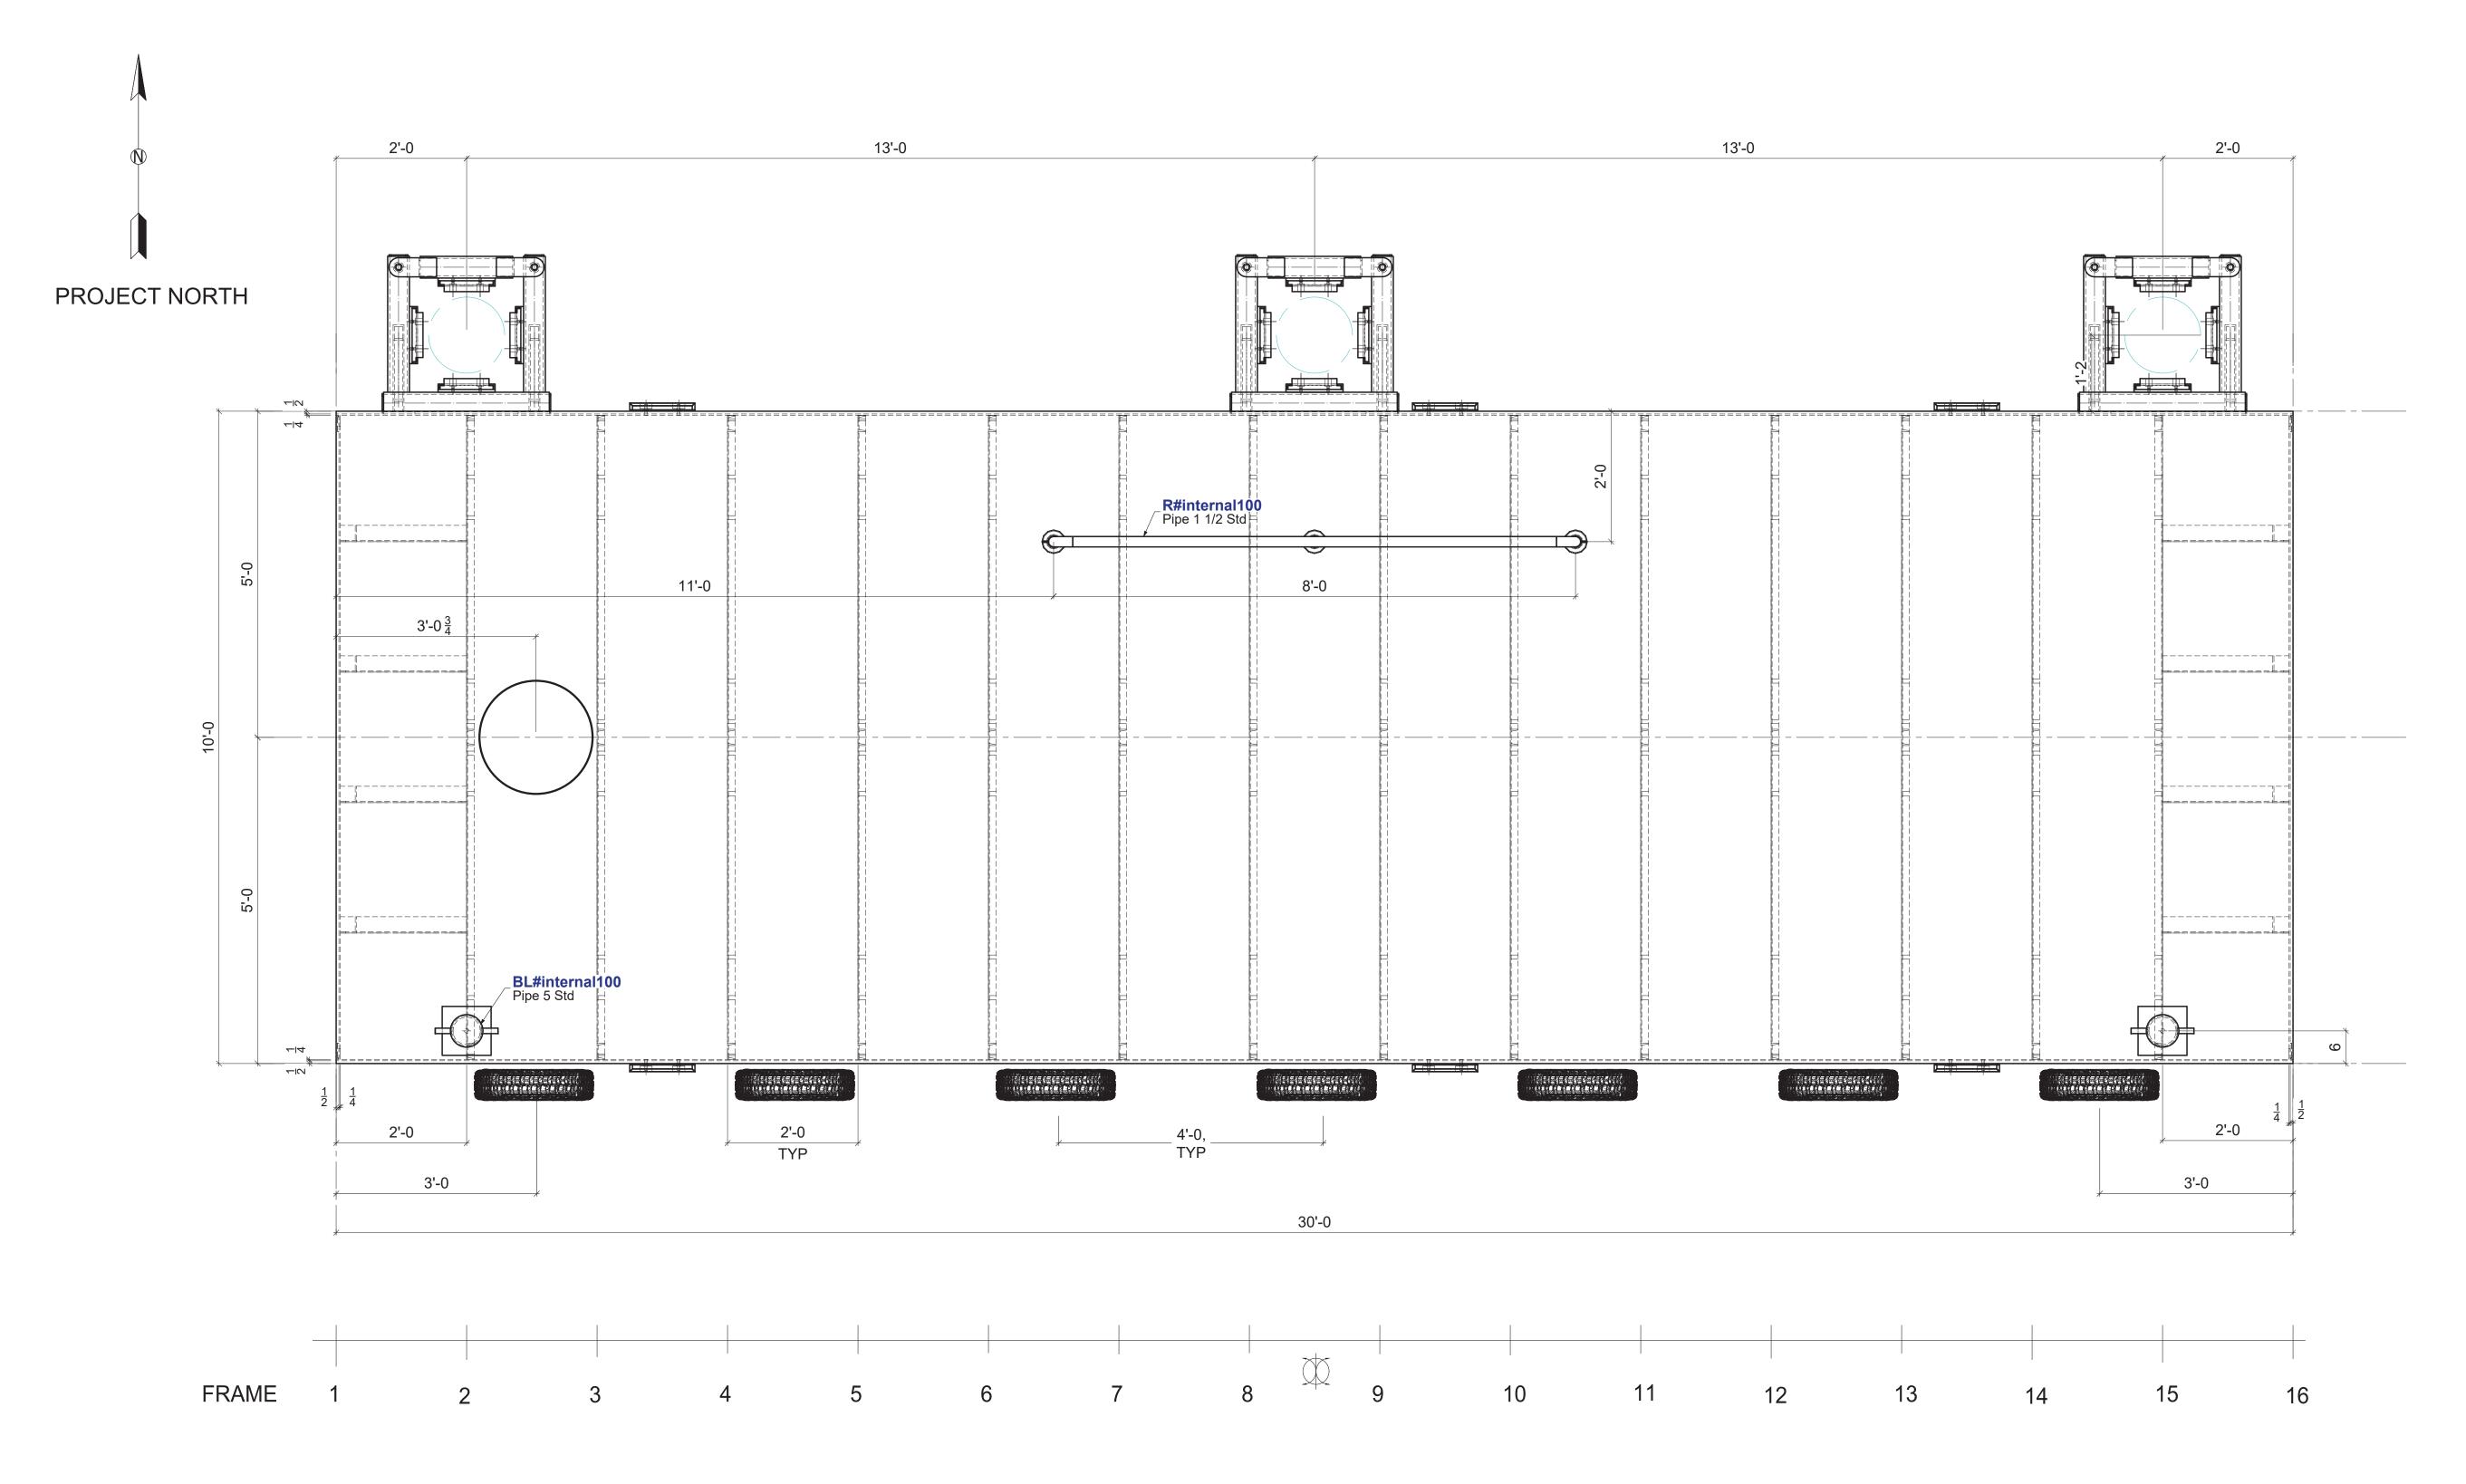

DECK PLAN-GENERAL ASSEMBLY SCALE: 3/4"=1'-0"

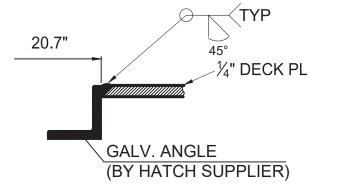

WATERTIGHT HATCH DETAIL

18" HATCH, AL COVER, MS RING, 2404 BY FREEMAN MARINE OR EQUAL

REV: REVISION NOTE: DATE:

BLUE ATLANTIC FABRICATORS, LLC

256 MARGINAL ST
EAST BOSTON, MA 02128

PROJECT NAME: WATER TAXI DOCK
LOCATION: BOSTON, MA


ARCHITECT: -

HOLES 13/16"Ø U.N.O. SURFACE PREP. PER GN1 U.N.O. SHOP PAINT PER GN1 U.N.O. MATERIAL PER GN1 U.N.O. ELECTRODES E-70XX


WELDING CODE AWS D1.1

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⊗ - DENOTES CONNECTION SIDE DATE: 3/16/2022 DATE: 3/16/2022 22-03397 E3

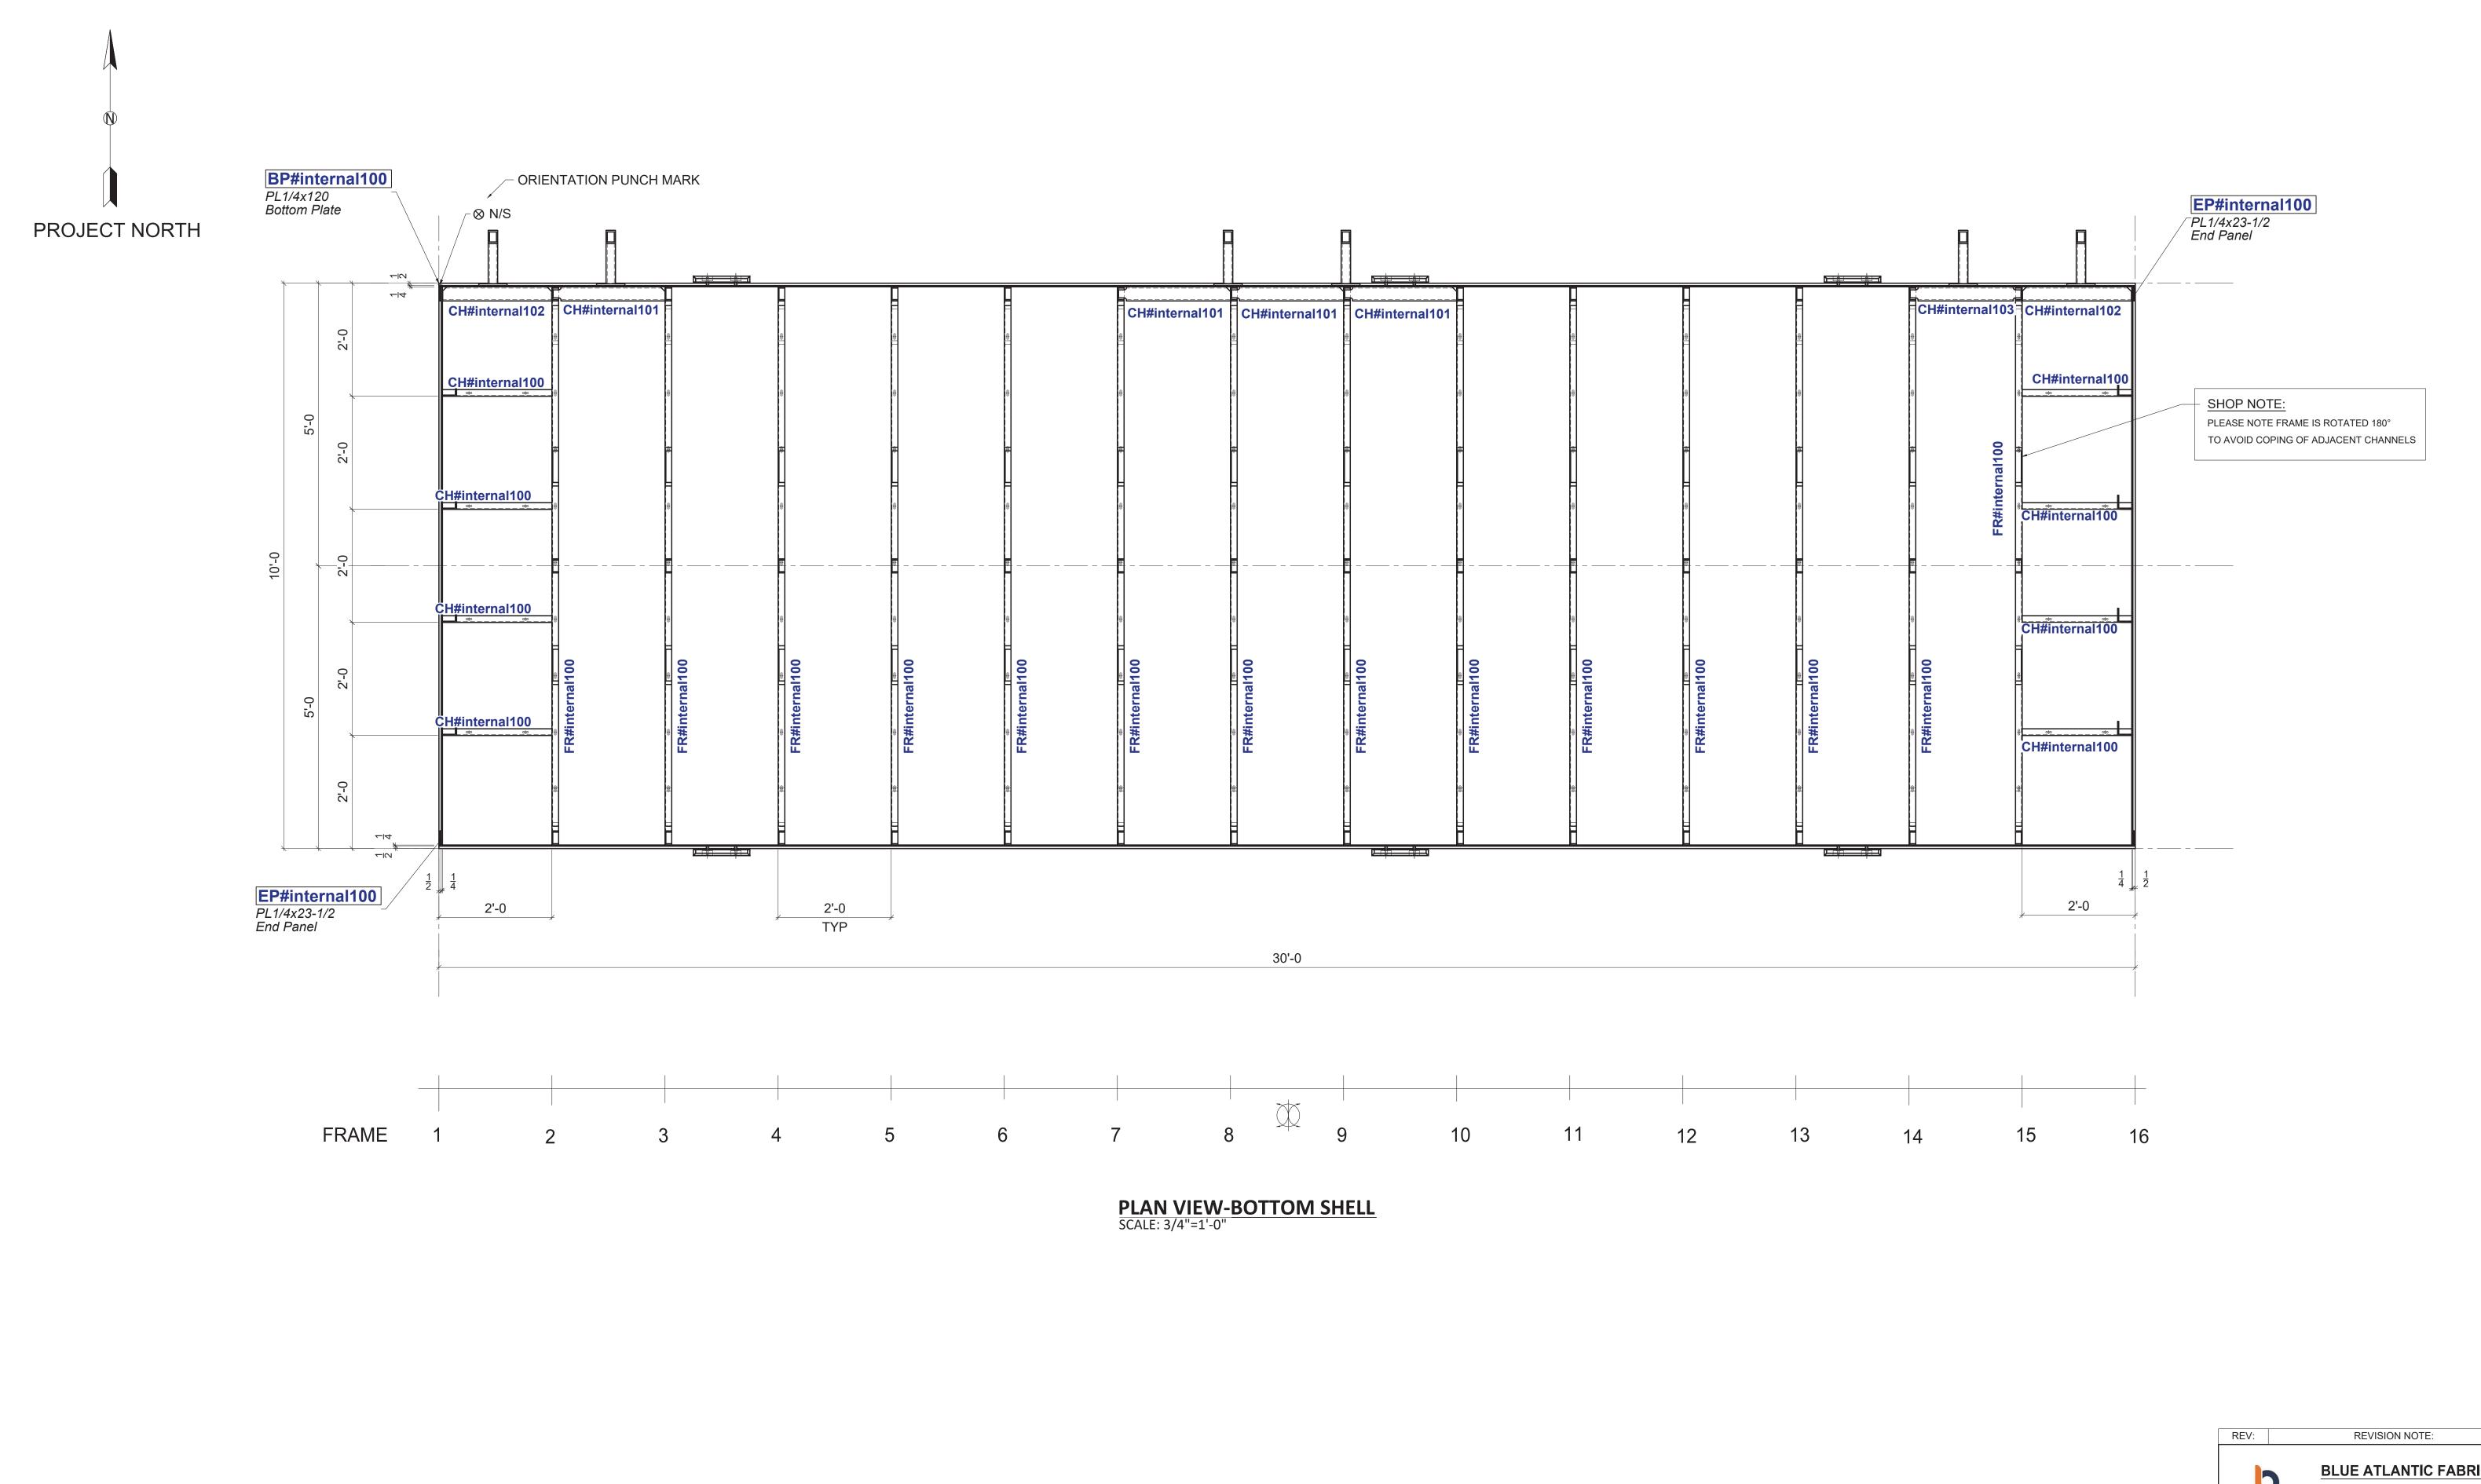


DATE: **BLUE ATLANTIC FABRICATORS, LLC** 256 MARGINAL ST **BLUE ATLANTIC** EAST BOSTON, MA 02128 PROJECT NAME: WATER TAXI DOCK LOCATION: BOSTON, MA ARCHITECT: HOLES 13/16"Ø
SURFACE PREP. PER GN1 BLUE ATLANTIC FABRICATORS, LLC ENGINEER: SHOP PAINT CUSTOMER: C. WHITE MARINE, INC. ELECTRODES E-70XX DWG TITLE: WELDING CODE AWS D1.1 RADIUS ½" U.N.O. ID CHECKED BY: PA JOB NO. DWG. NO. 21/15/2022 DATE: 3/16/2022 22-03397 E4

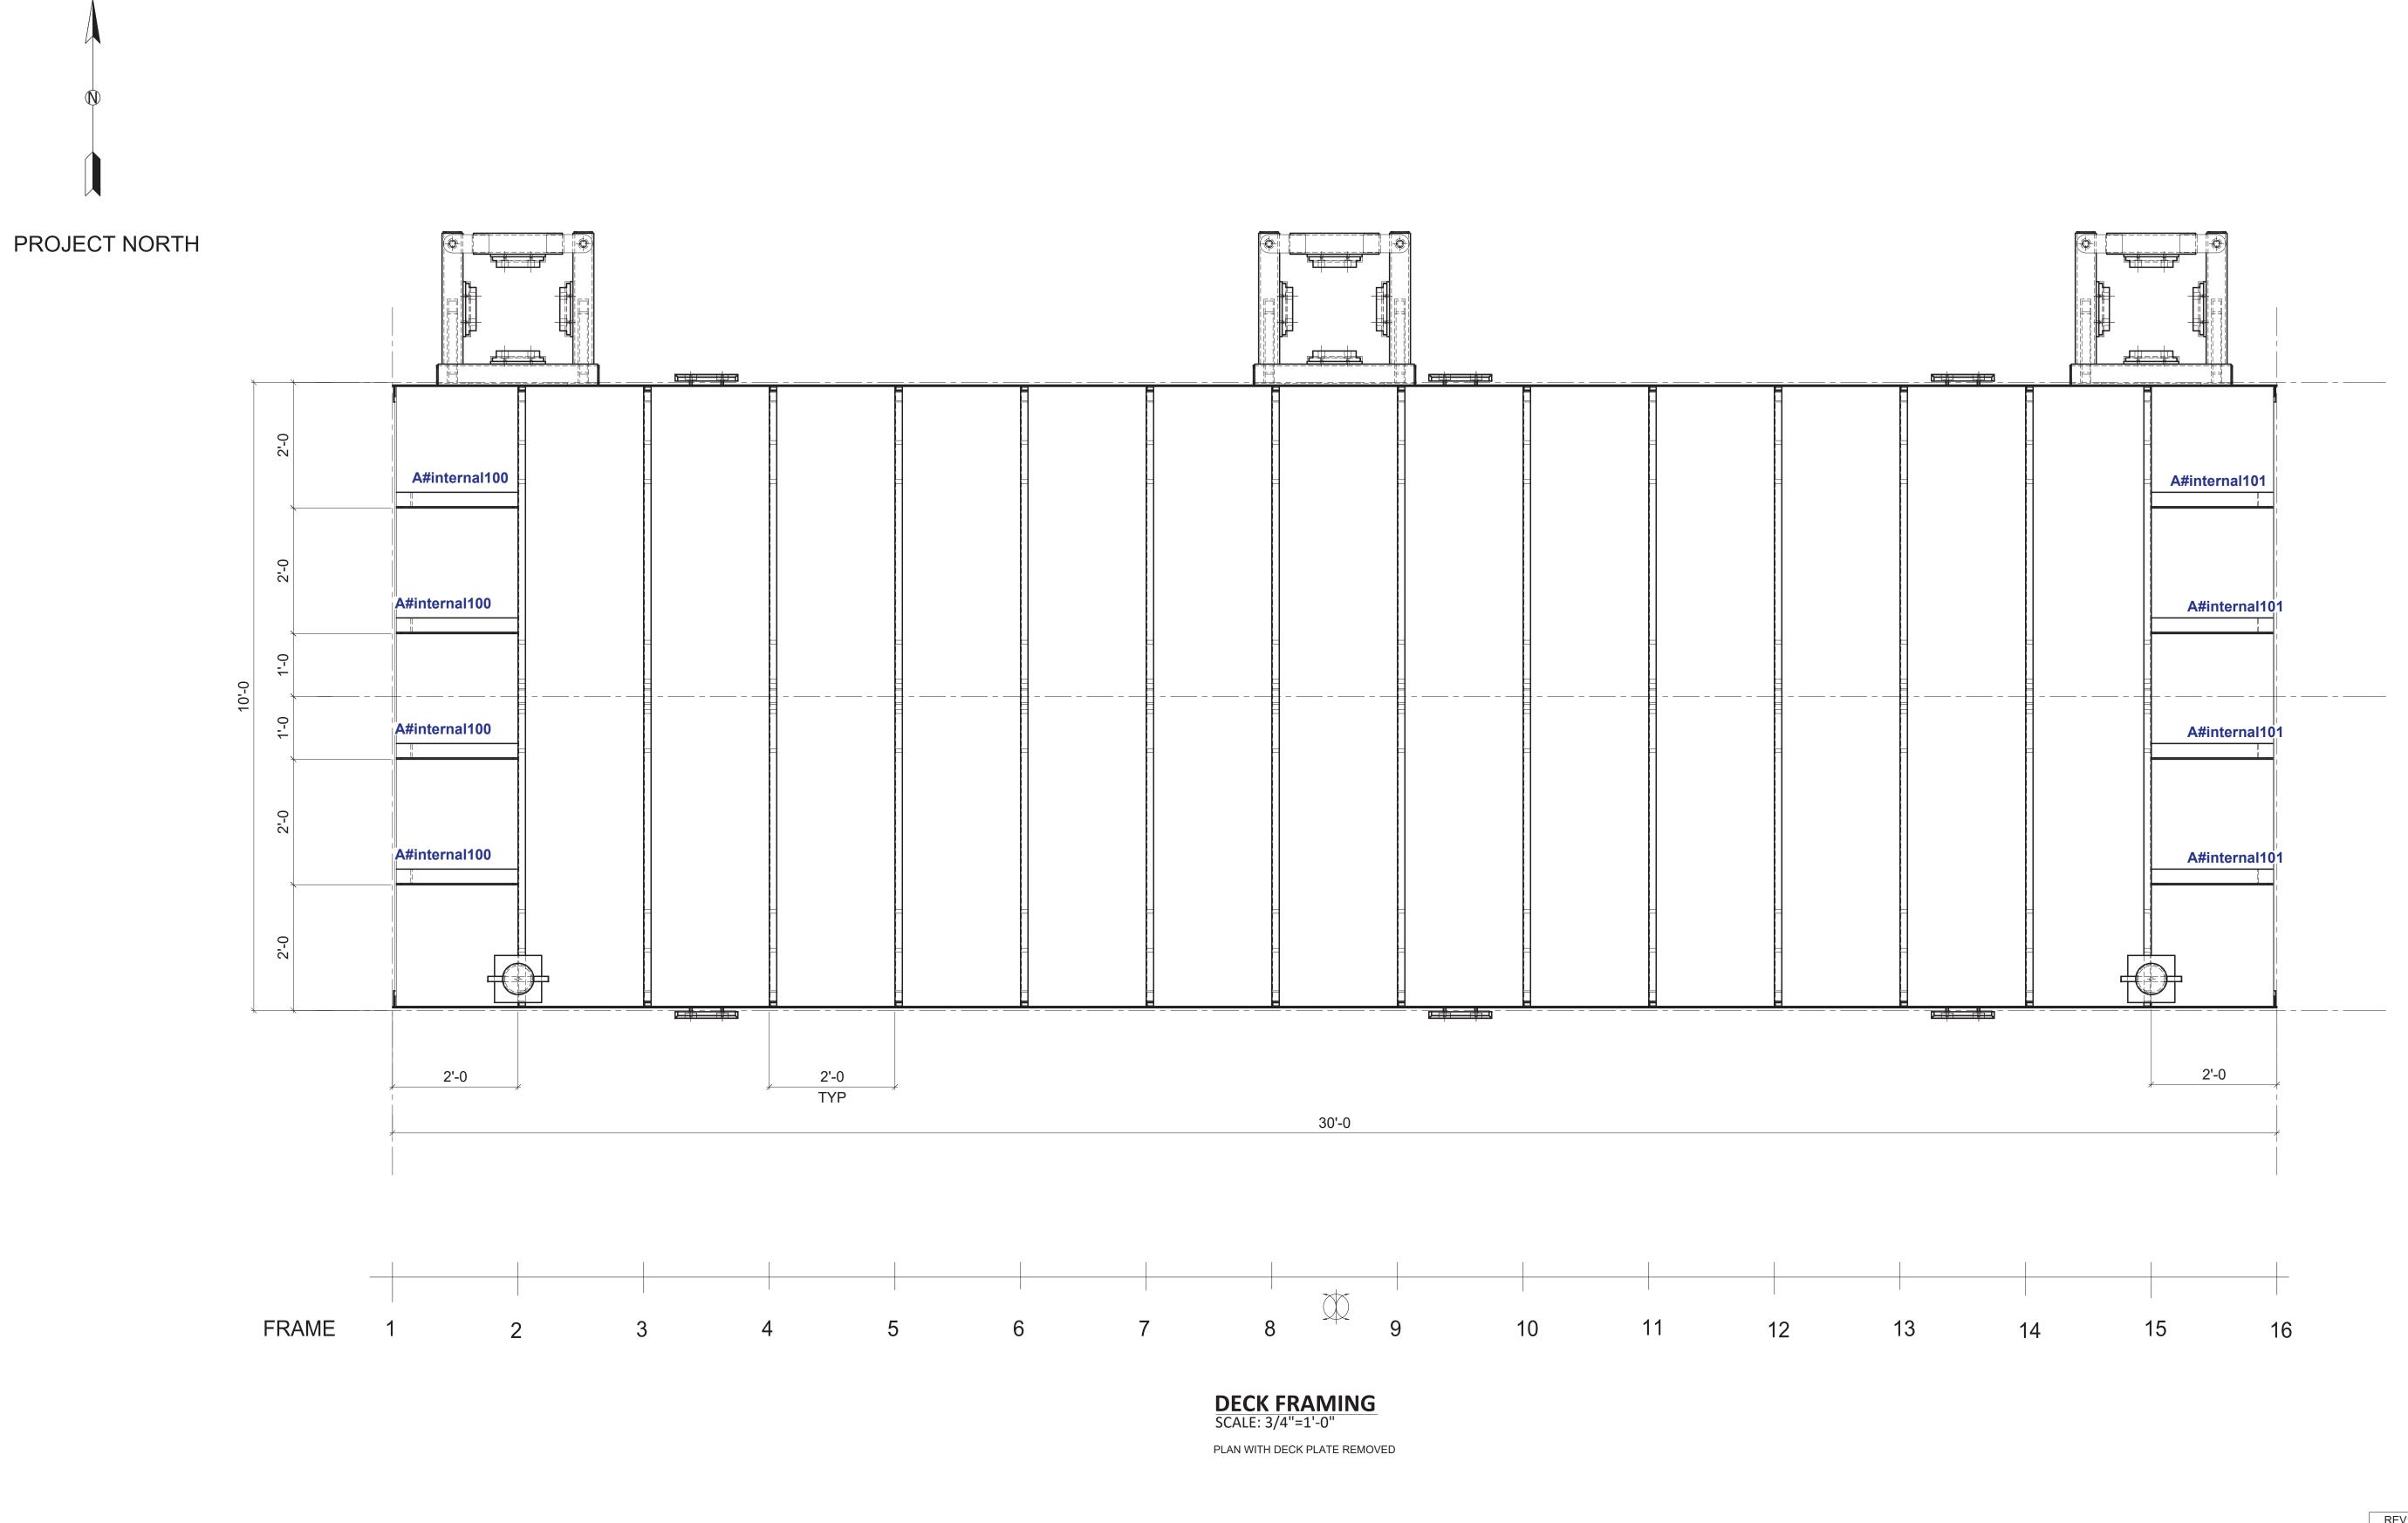


REV: REVISION NOTE: DATE: **BLUE ATLANTIC FABRICATORS, LLC** 256 MARGINAL ST BLUE ATLANTIC EAST BOSTON, MA 02128 PROJECT NAME: WATER TAXI DOCK BOSTON, MA LOCATION: SURFACE PREP. PER GN1 BLUE ATLANTIC FABRICATORS, LLC ENGINEER: C. WHITE MARINE, INC. N.O. CUSTOMER: ELECTRODES E-70XX WELDING CODE AWS D1.1


RADIUS ½" U.N.O.


⊗ - DENOTES CONNECTION SIDE **DECK FRAMING** DRAWN BY: | ID | CHECKED BY: | PA | JOB NO. | DWG. NO. | DATE: | 3/15/2022 | DATE: | 3/16/2022 | 22-03397 | E5

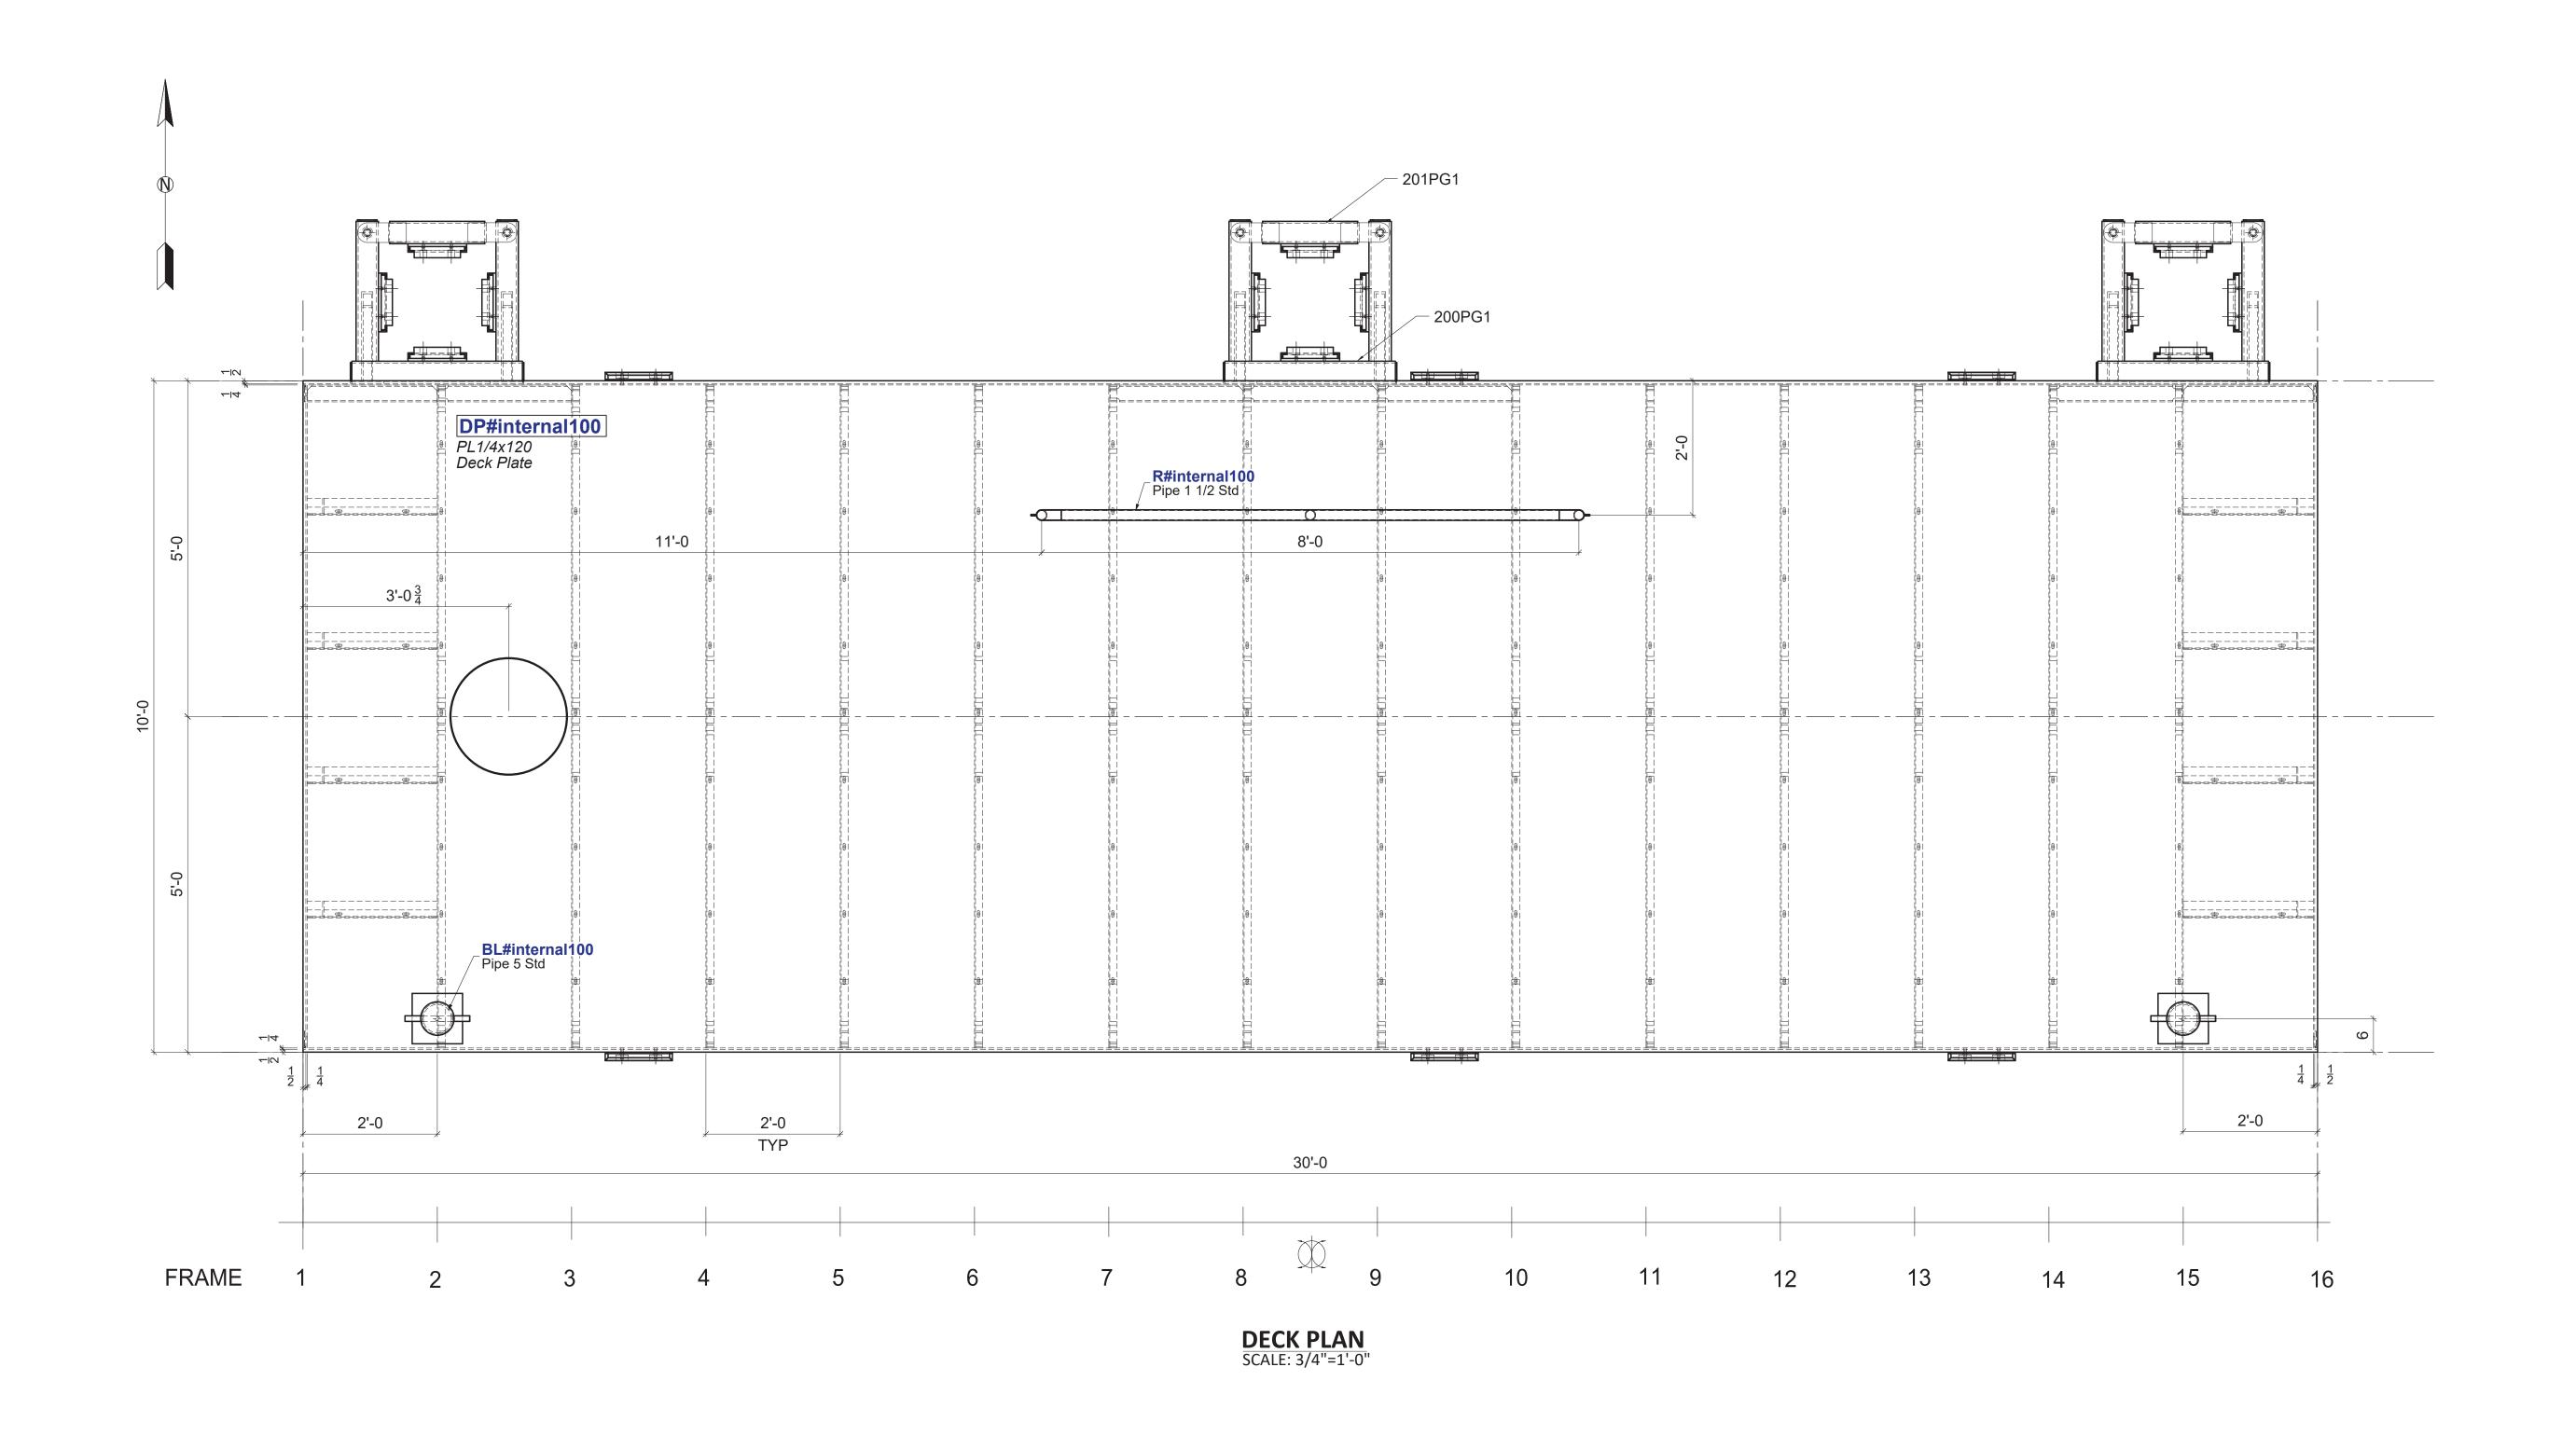



REV: REVISION NOTE: DATE: **BLUE ATLANTIC FABRICATORS, LLC** 256 MARGINAL ST BLUE ATLANTIC EAST BOSTON, MA 02128 PROJECT NAME: WATER TAXI DOCK LOCATION: BOSTON, MA ARCHITECT: SURFACE PREP. PER GN1 BLUE ATLANTIC FABRICATORS, LLC ENGINEER: SHOP PAINT CUSTOMER: C. WHITE MARINE, INC. ELECTRODES E-70XX DWG TITLE: WELDING CODE AWS D1.1 RADIUS ½" U.N.O. ID CHECKED BY: PA JOB NO. DWG. NO. 21/15/2022 DATE: 3/16/2022 22-03397 E6

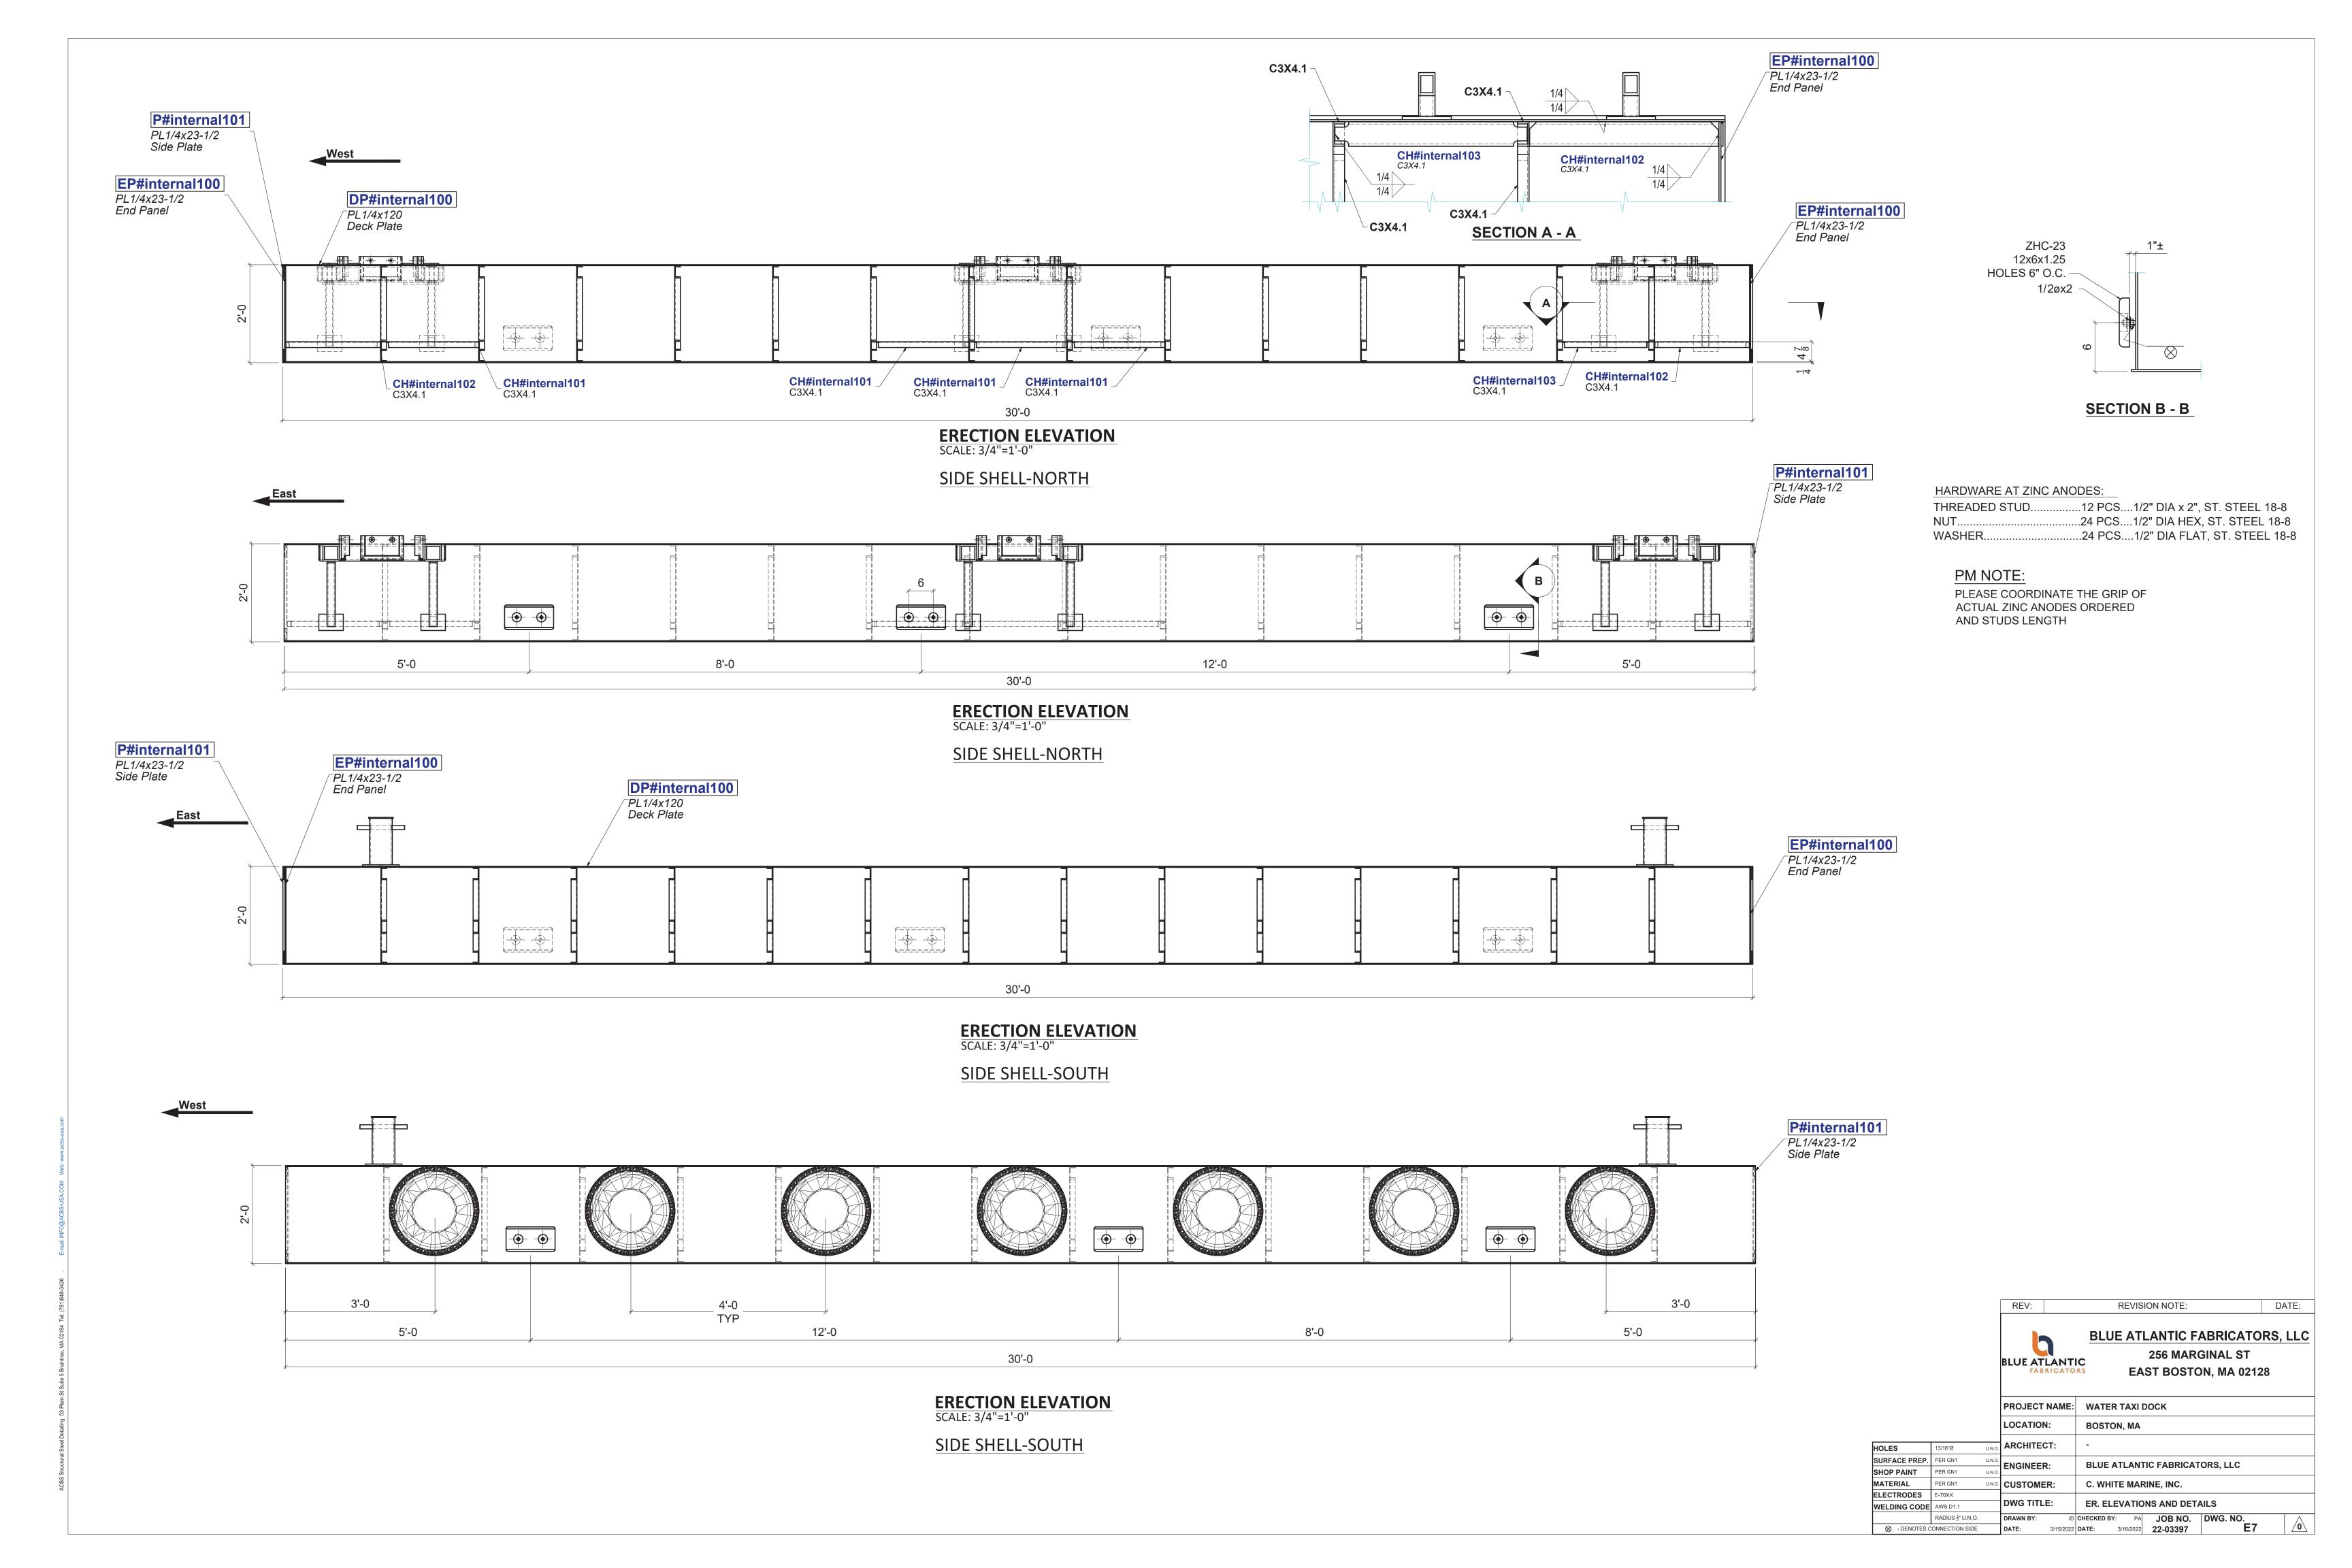

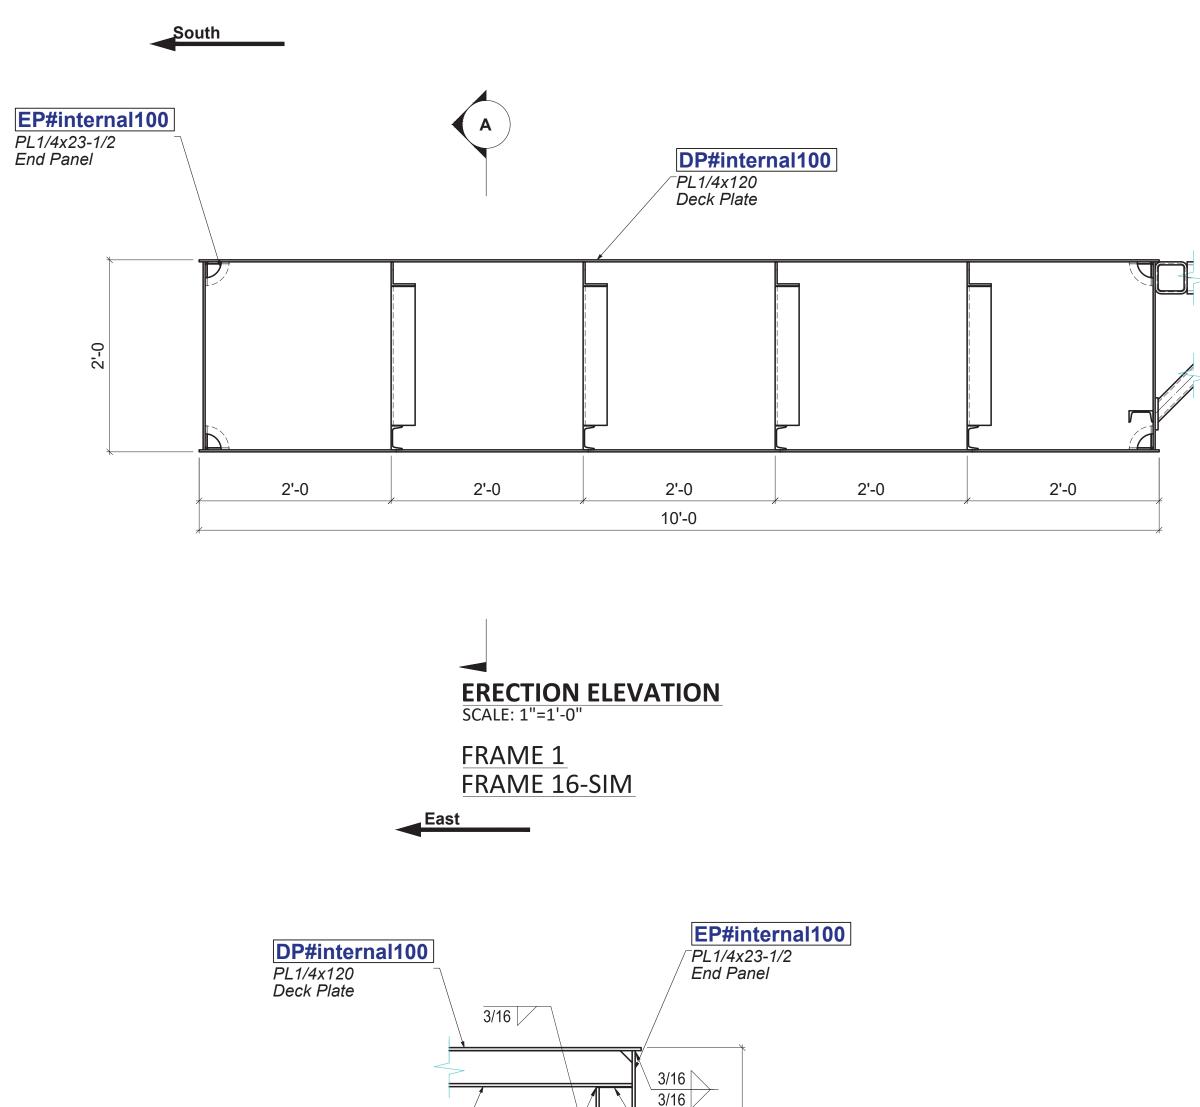

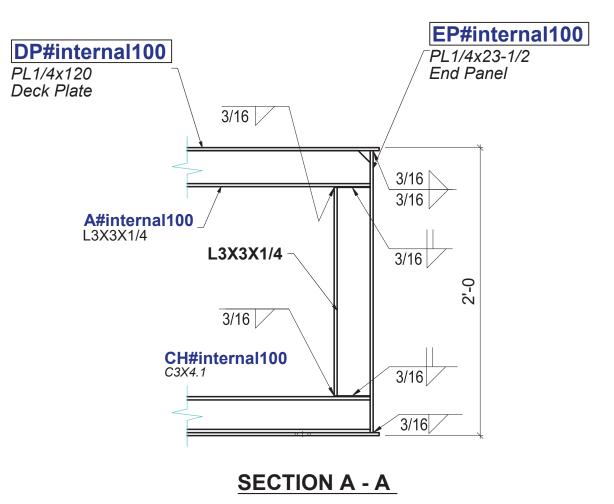


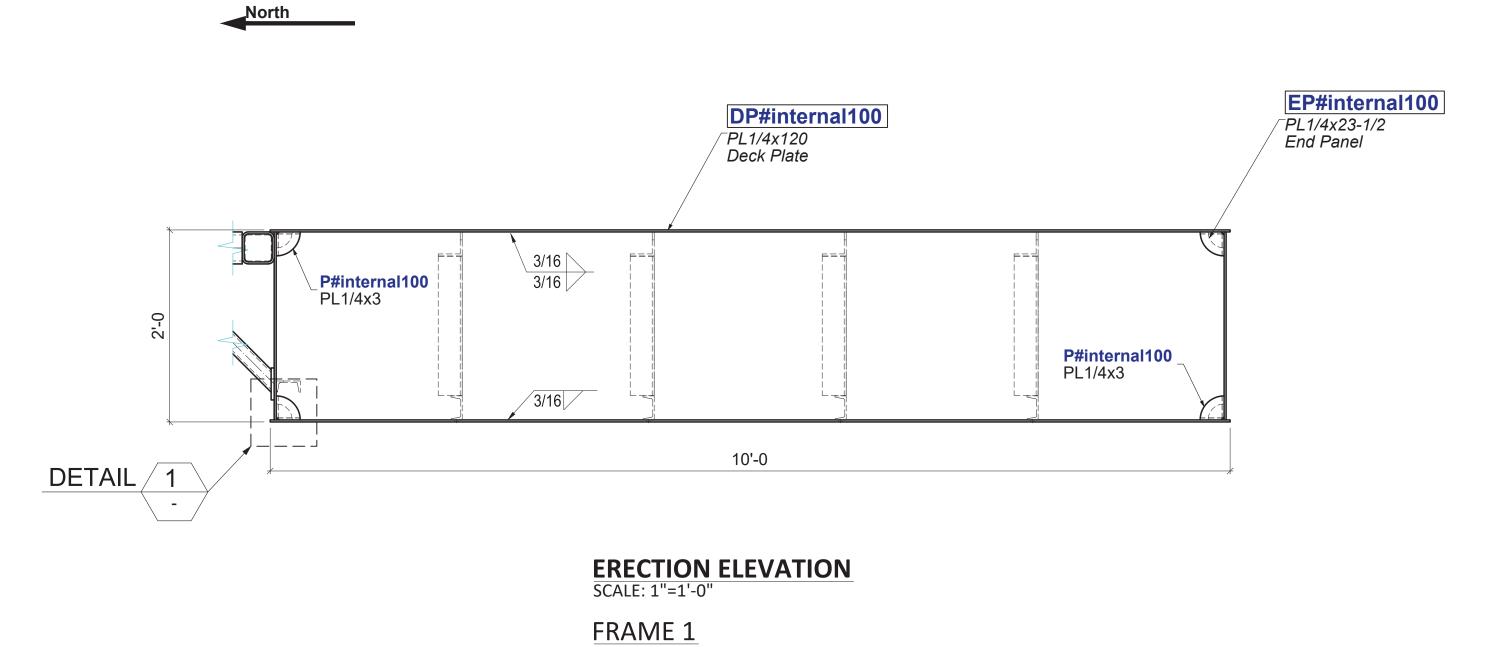

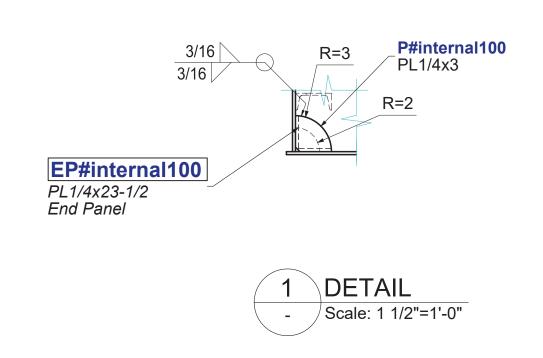


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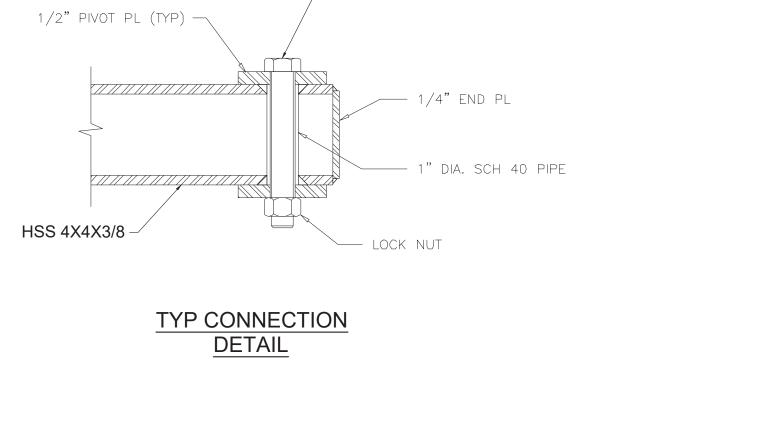


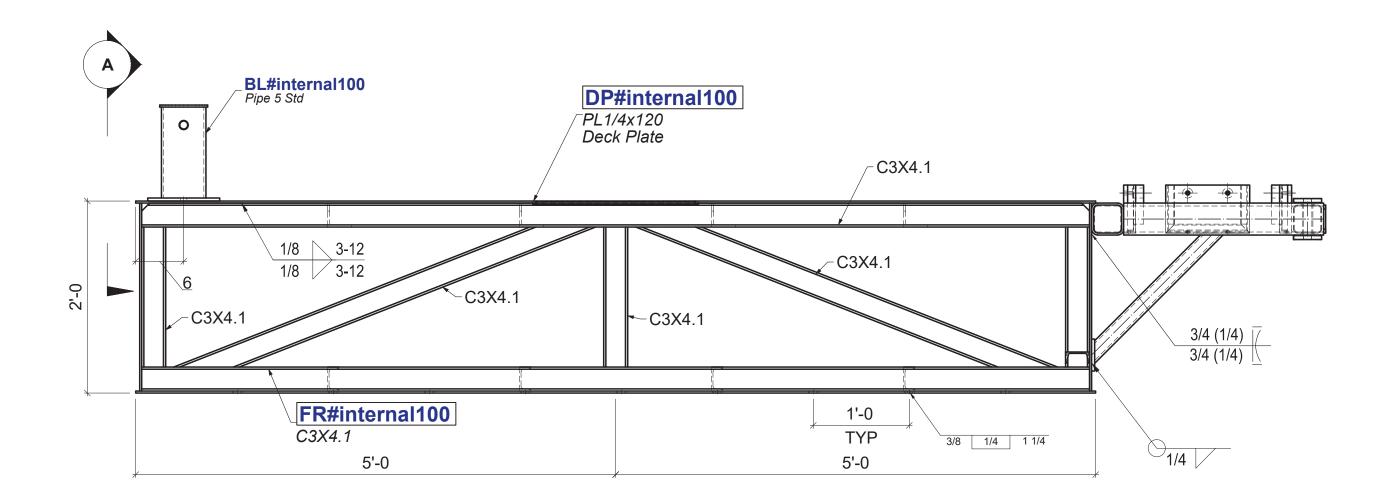

ERECTION ELEVATION SCALE: 1"=1'-0"

TYP TRANSVERSE SECTION



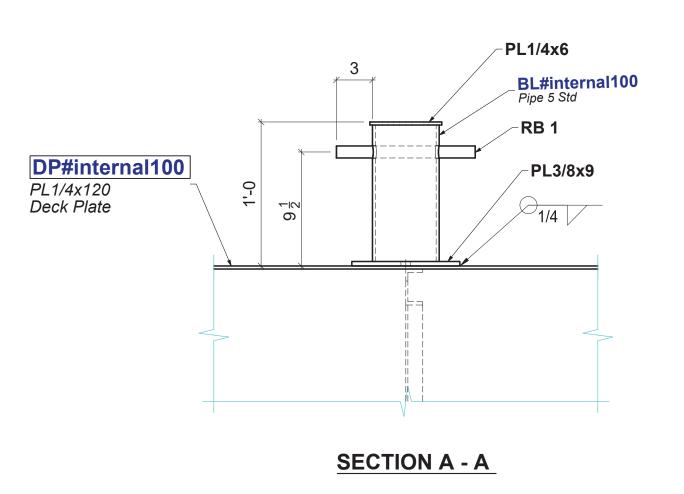


 $\sqrt{\frac{7}{8}}$ "Øx6 $\frac{1}{2}$ " BOLT WITH LOCK NUT, ST. STEEL 316

SHOP BOLTS 3/8"Ø x 0'-2" ST. STEEL 316 B / LOCK NUT / 2W FULL THREAD 24 EA

FIELD BOLTS

7/8"Ø x 0'-6 1/2" ST. STEEL 316 B / LOCK NUT 6 EA

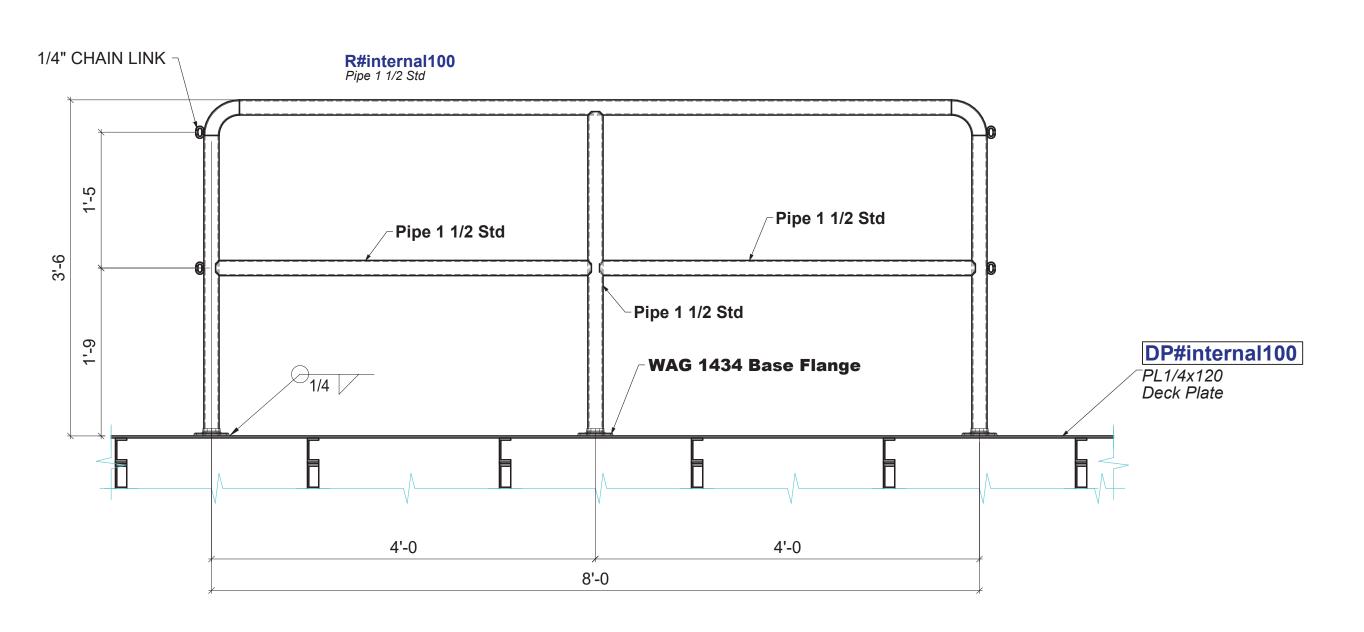

ERECTION DETAIL
SCALE: 1"=1'-0"

8'-0" RAIL PANEL

			BLUE ATLANT	
			PROJECT NAME:	WATER TAXI DOCK
			LOCATION:	BOSTON, MA
HOLES	13/16"Ø	U.N.O.	ARCHITECT:	-
SURFACE PREP.	PER GN1	U.N.O.	ENGINEED.	DI HE ATLANTIC EARDICATORS I I C
SHOP PAINT	PER GN1	U.N.O.	ENGINEER:	BLUE ATLANTIC FABRICATORS, LLC
MATERIAL	PER GN1	U.N.O.	CUSTOMER:	C. WHITE MARINE, INC.
LECTRODES	E-70XX]	
WELDING CODE	AWS D1.1		DWG TITLE:	ER. ELEVATIONS AND DETAILS
	RADIUS ½" U.N.O.		DRAWN BY: ID	CHECKED BY: PA JOB NO. DWG. NO.
	ONNECTION SIDE		DATE : 3/15/2022	DATE: 3/16/2022 22-03397 E9 /0

REVISION NOTE:

DATE:


REV:

ISOMETRIC VIEW-FLOAT FLIPPED
BOTTOM SHELL REMOVED
SCALE: 3/4"=1'-0"

REV: REVISION NOTE: DATE: **BLUE ATLANTIC FABRICATORS, LLC** 256 MARGINAL ST EAST BOSTON, MA 02128 PROJECT NAME: WATER TAXI DOCK LOCATION: BOSTON, MA ARCHITECT: BLUE ATLANTIC FABRICATORS, LLC ENGINEER: C. WHITE MARINE, INC. ELECTRODES E-70XX RADIUS ½" U.N.O. CHECKED BY: PA JOB NO. 22-03397 DWG. NO. E10


PLAN VIEW-FLOAT FLIPPED
BOTTOM SHELL REMOVED
SCALE: 3/4"=1'-0"


REV: REVISION NOTE: DATE: **BLUE ATLANTIC FABRICATORS, LLC 256 MARGINAL ST** BLUE ATLANTIC FABRICATORS EAST BOSTON, MA 02128 PROJECT NAME: WATER TAXI DOCK LOCATION: BOSTON, MA ARCHITECT: SURFACE PREP. PER GN1 BLUE ATLANTIC FABRICATORS, LLC ENGINEER: SHOP PAINT CUSTOMER: C. WHITE MARINE, INC. ELECTRODES E-70XX DWG TITLE: PLAN VIEW-BOTTOM SHELL REMOVED WELDING CODE AWS D1.1

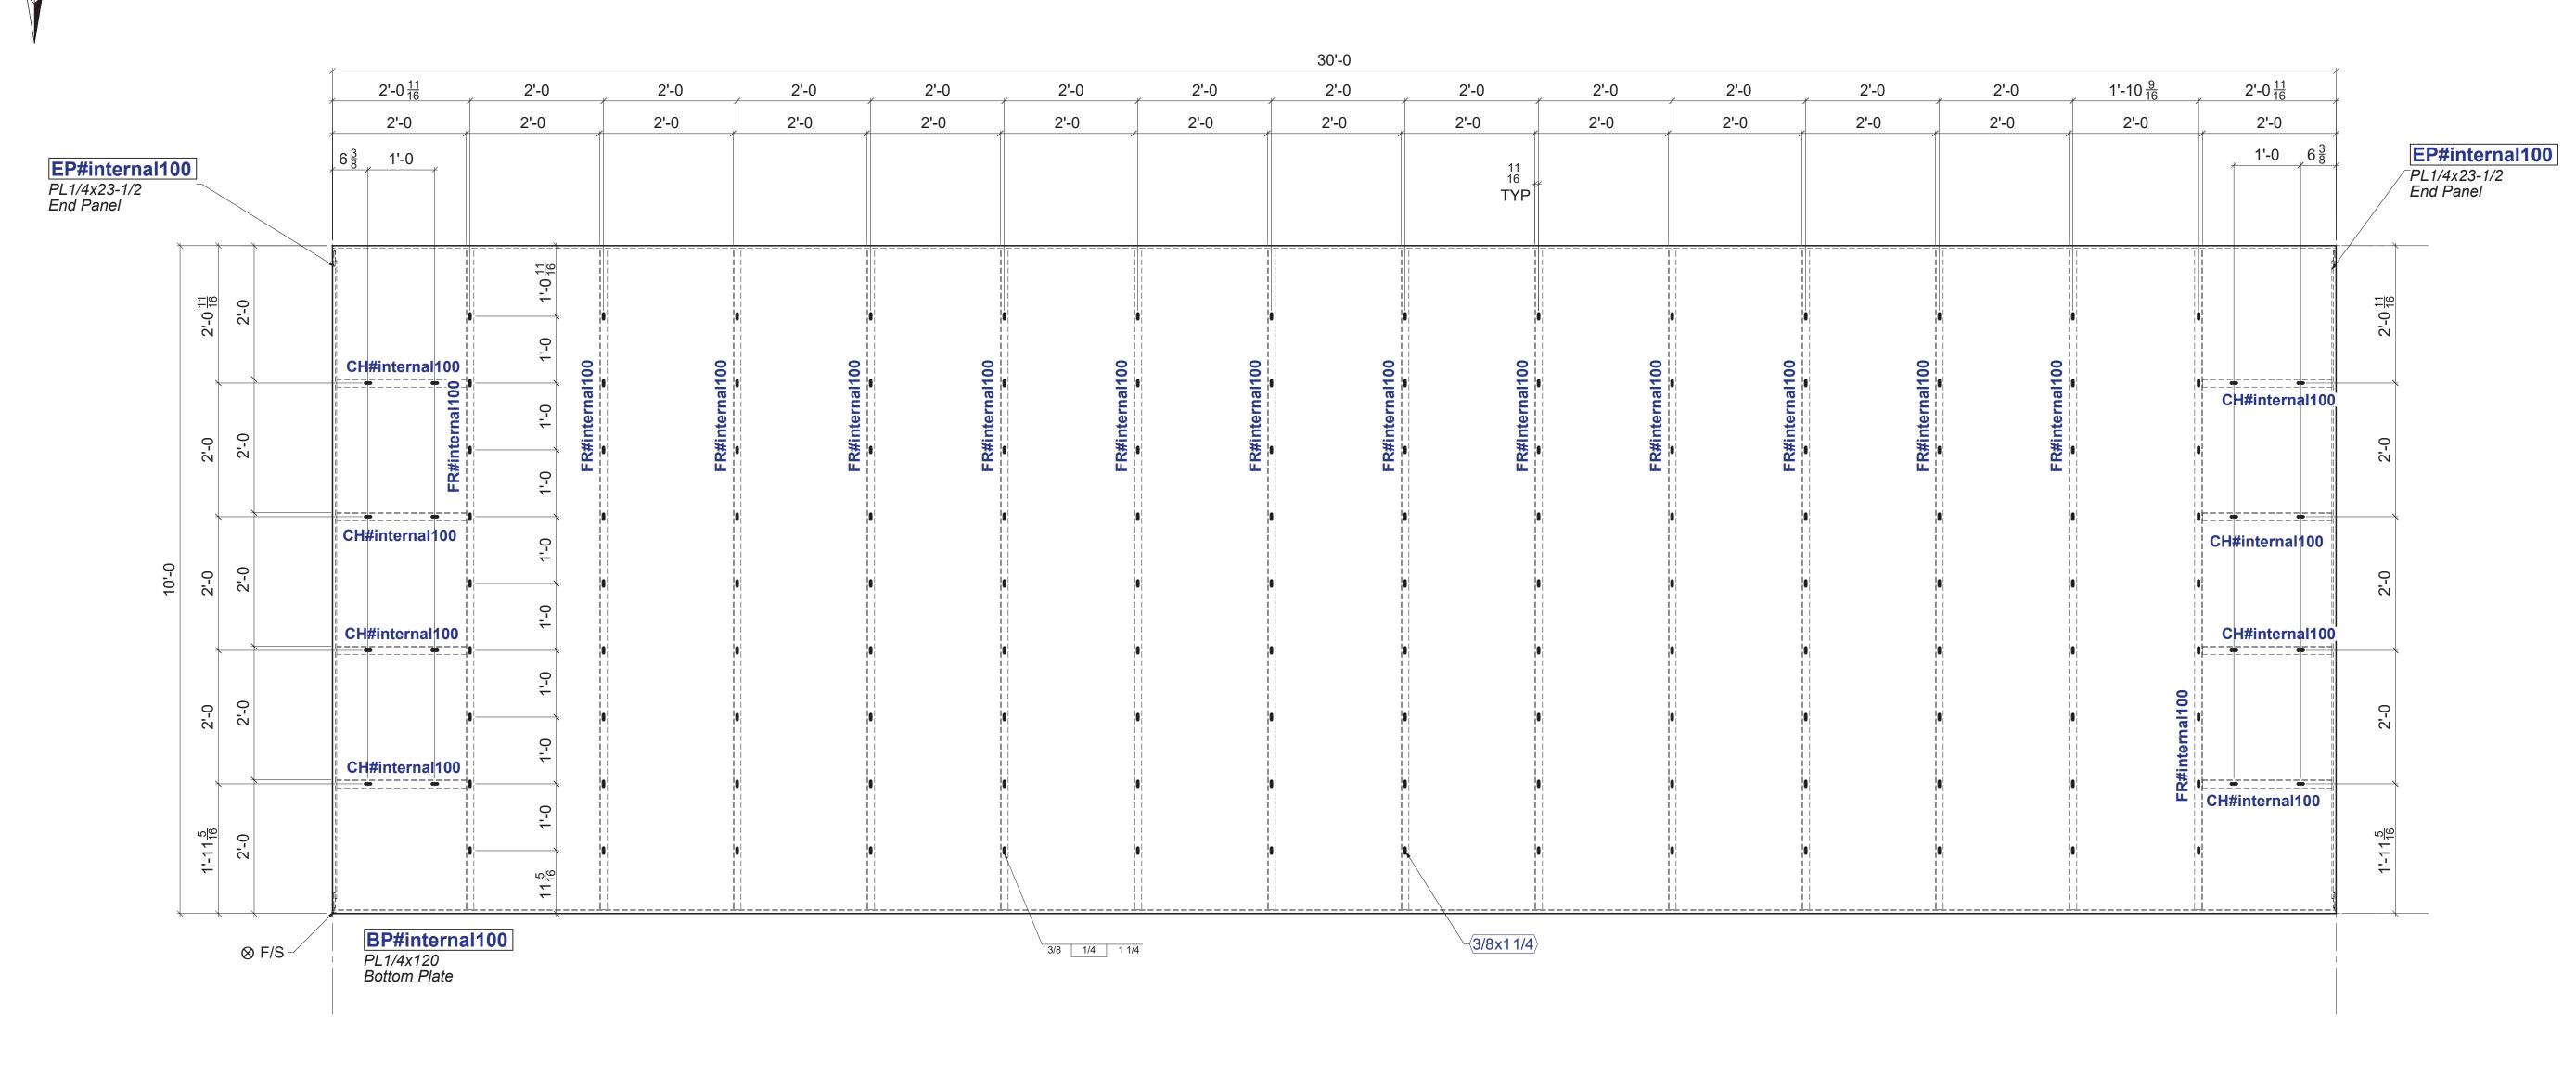

PLAN VIEW-BOTTOM SHELL FLOAT FLIPPED SCALE: 3/4"=1'-0"

			REV:		REVIS	ION NOTE:		DATE:
			BLUE ATLA			256 MAR	ABRICATO GINAL ST DN, MA 0212	,
			PROJECT NA	AME:	WATER TAXI	DOCK		
			LOCATION:		BOSTON, MA			
HOLES	13/16"Ø	U.N.O.	ARCHITECT:		-			
SURFACE PREP.	PER GN1	U.N.O.	ENCINEED.		BLUE ATLAN	TIC EARDICAT	TOPS LLC	
SHOP PAINT	PER GN1	U.N.O.	ENGINEER:		BLUE ATLAN	IIC PABRICAT	OKS, LLC	
MATERIAL	PER GN1	U.N.O.	CUSTOMER:		C. WHITE MAR	RINE, INC.		
ELECTRODES	E-70XX							
WELDING CODE	AWS D1.1		DWG TITLE:		BOTTOM SHE	LL-FLOAT FL	IPPED	
	RADIUS ½" U.N.O.		DRAWN BY:	ID	CHECKED BY: PA	JOB NO.	DWG. NO.	
	ON PUNCH MARK		DATE: 3/	15/2022	DATE : 3/16/2022	22-03397	E12	2 \(\sqrt{0} \)

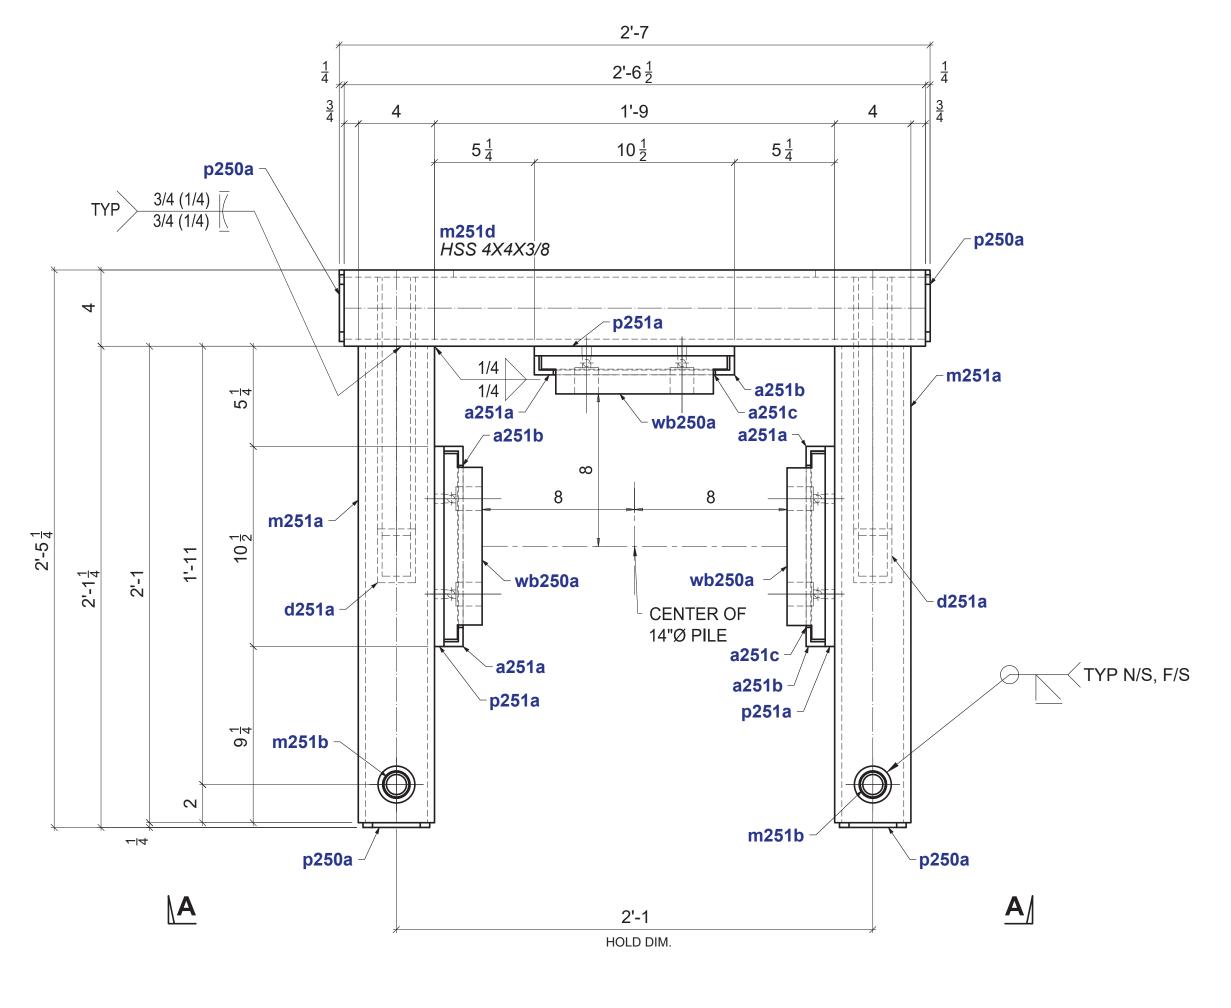

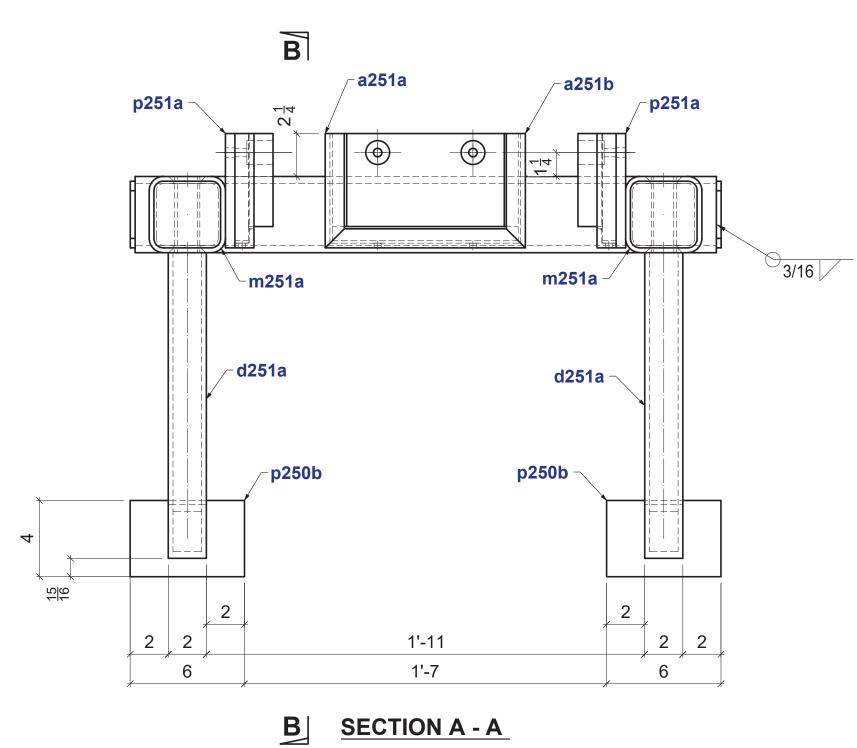

 $2'-5\frac{1}{4}$

 $10\frac{1}{2}$

m251d

1/4

−**p250**b

d251a -


SECTION B - B

2'-1

1/4


1/4

3 - 200PG1 HSS 4X4X3/8x2'-6 1/2

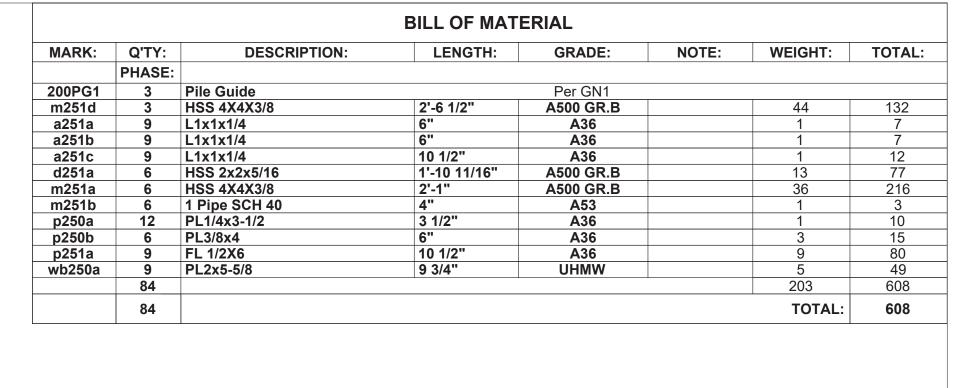

SHOP BOLTS

3/8"Ø x 0'-2" ST. STEEL 316 B / LOCK NUT / 2W FULL THREAD18 EA

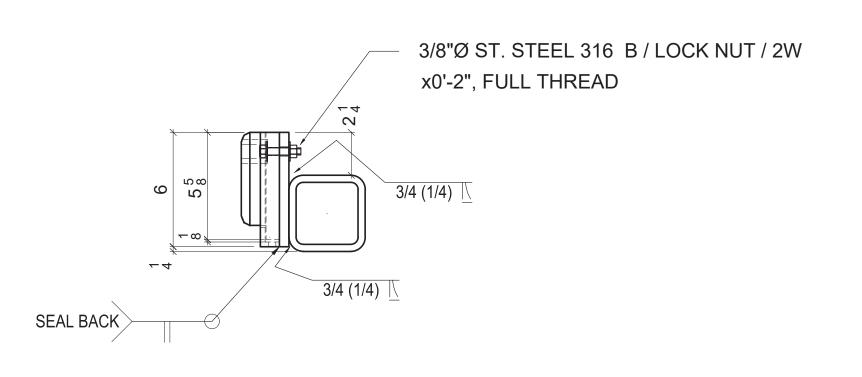






			BILL OF MAT	ERIAL			
MARK:	Q'TY:	DESCRIPTION:	LENGTH:	GRADE:	NOTE:	WEIGHT:	TOTAL:
	PHASE:						
201PG1	3	Pile Guide		Per GN1			
m251c	3	HSS 4X4X3/8	1'-5"	A500 GR.B		24	73
a251a	3	L1x1x1/4	6"	A36		1	2
a251b	3	L1x1x1/4	6"	A36		1	2
a251c	3	L1x1x1/4	10 1/2"	A36		1	4
p250a	6	PL1/4x3-1/2	3 1/2"	A36		1	5
p250c	12	PL1/2x3-1/2	8 3/4"	A36		4	50
p251a	3	FL 1/2X6	10 1/2"	A36		9	27
wb250a	3	PL2x5-5/8	9 3/4"	UHMW		5	16
-	36					60	180
	36					TOTAL:	180

SHOP BOLTS

3/8"Ø x 0'-2" ST. STEEL 316 B / LOCK NUT / 2W FULL THREAD6 EA

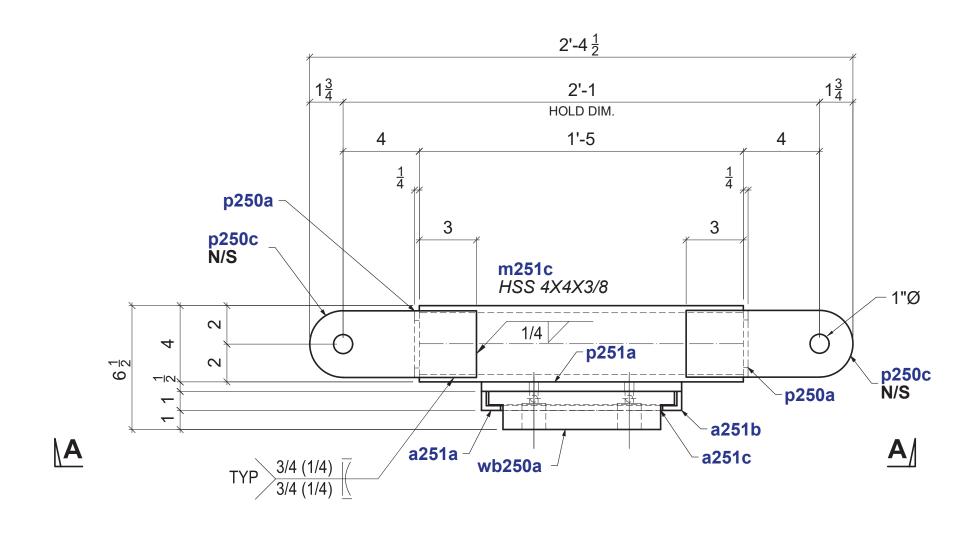

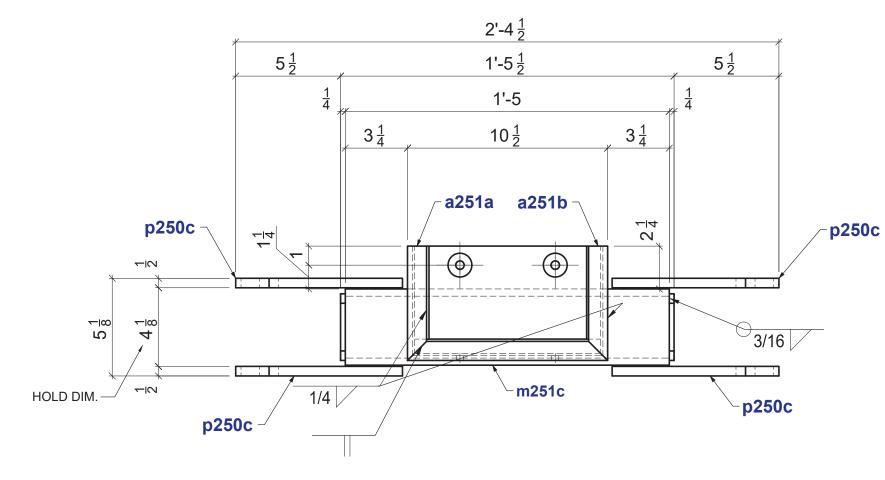


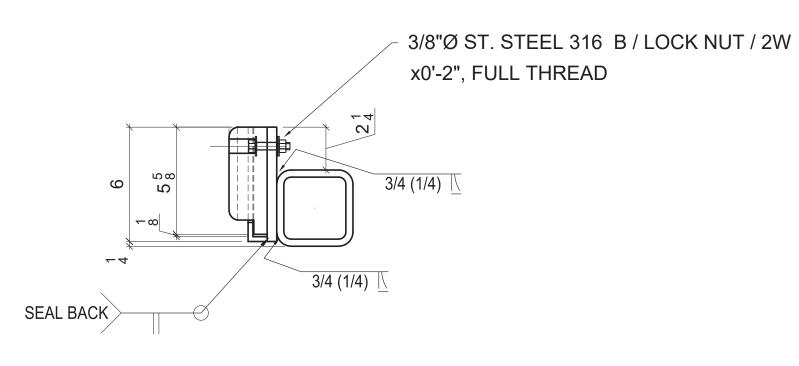


SECTION A - A

3 - 201PG1 HSS 4X4X3/8x1'-5




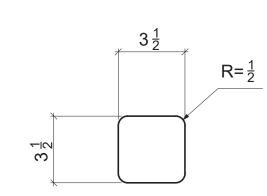


18 - **p250a** PL1/4x3-1/2 x3 1/2 A36

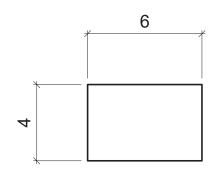


6 - **p250b** PL3/8x4 x6 A36

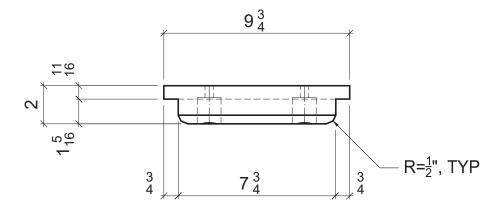


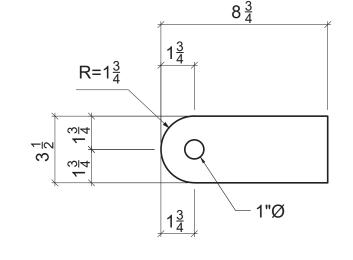

12 - **p250c** PL1/2x3-1/2 x8 3/4 A36

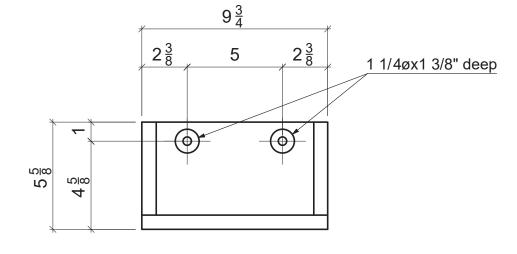

12 - **wb250a** PL2x5-5/8 x9 3/4 UHMW

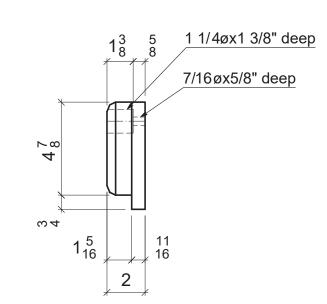

A FOR A		
REV:		
BLUE AT	ВІ	
BLU	BL	
	SIZE:	DRAWING S
LOCATION		
LOCATION: BOSTON		
U.N.O. ARCHITECT: -		
ENGINEER: BLUE ATLANTIC	er spec's u.n.o. En one, Per GN1 u.n.o.	SURFACE PREP. PER SHOP PAINT None
UNO. CUSTOMER: C. WHITE MARINE		
	70XX	ELECTRODES E-70
DWG TITLE: JOB STANDARDS	vs D1.1	WELDING CODE AWS
DRAWN BY: ID CHECKED BY: PA	ADIUS 1 U.N.O. DRA	RAD

 DRAWN BY:
 ID
 CHECKED BY:
 PA
 JOB NO.
 DWG. NO.


 DATE:
 3/18/2022
 DATE:
 3/18/2022
 22-03397
 250

St Suite 5 Braintree, MA 02184 Tel: (781)848-3426 E-mail: INFO@ACBS-USA.COM Web: www

MARK:

p250a p250a p250b p250c wb250a

wb250a

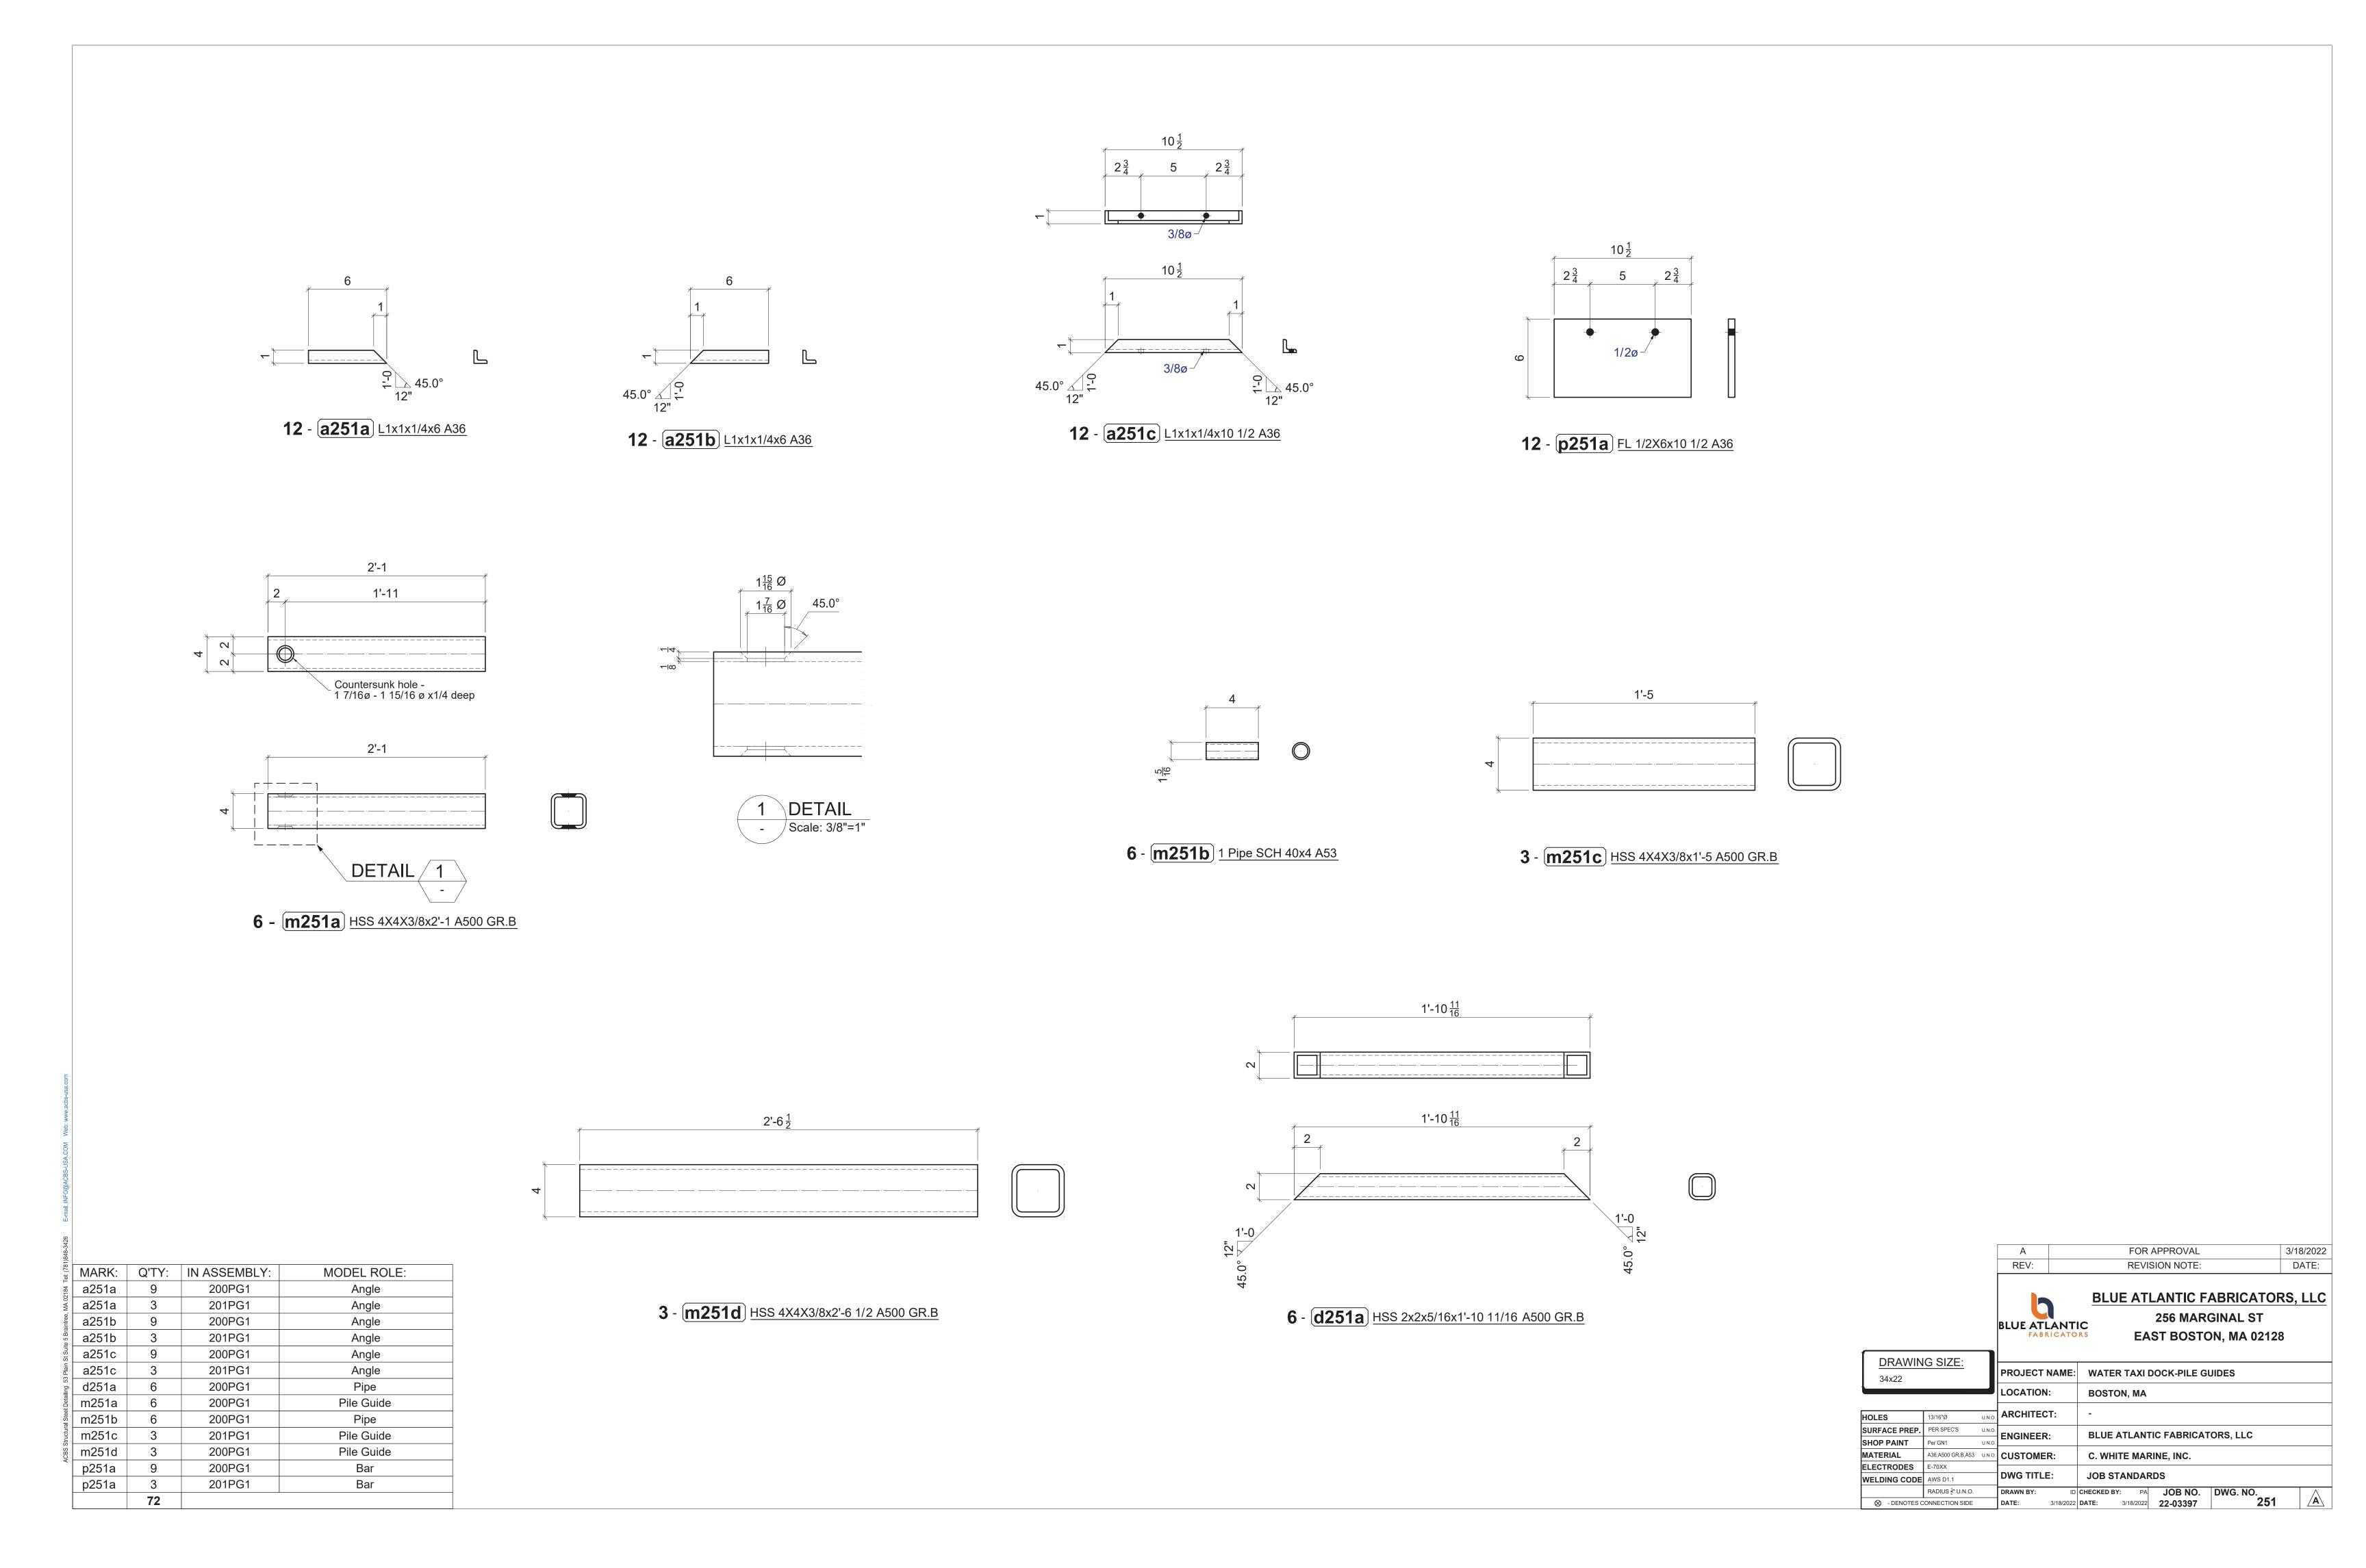




Attachment B: Photo Log



Photograph No.: 1
View of access ramp and dock system looking northeast towards Boston Harbor

Photograph No.: 2
View of access ramp and dock system looking
east towards Boston Harbor

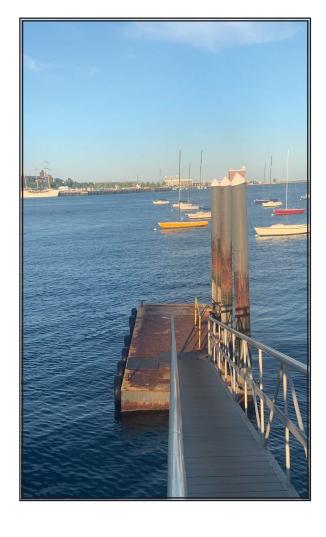






Attachment C: FEMA Flood Map

National Flood Hazard Layer FIRMette




Basemap: USGS National Map: Orthoimagery: Data refreshed October, 2020

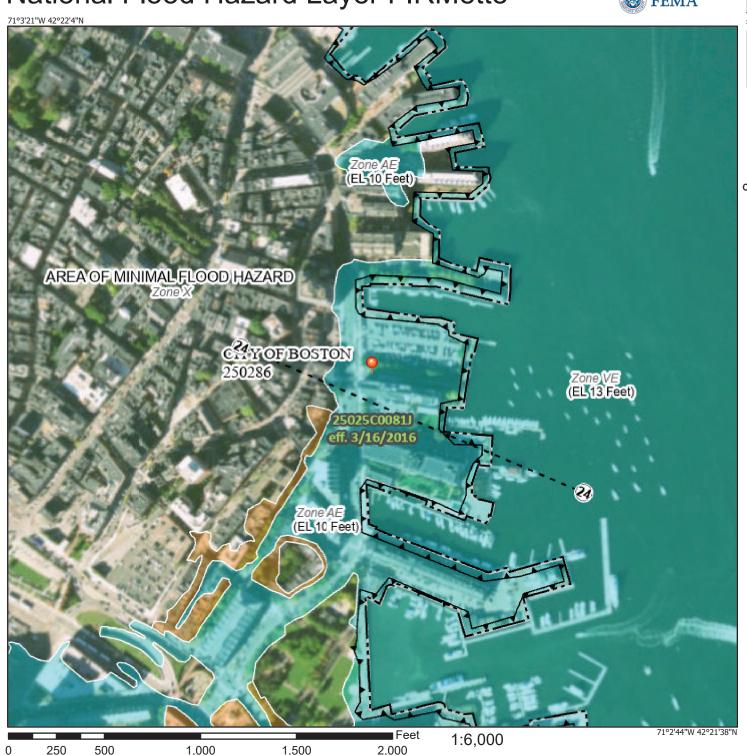

Legend

SEE FIS REPORT FOR DETAILED LEGEND AND INDEX MAP FOR FIRM PANEL LAYOUT

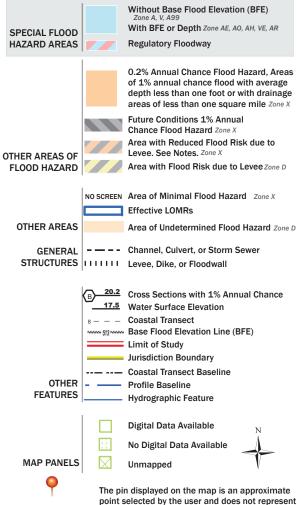

This map complies with FEMA's standards for the use of digital flood maps if it is not void as described below. The basemap shown complies with FEMA's basemap accuracy standards

The flood hazard information is derived directly from the authoritative NFHL web services provided by FEMA. This map was exported on 7/28/2022 at 1:15 PM and does not reflect changes or amendments subsequent to this date and time. The NFHL and effective information may change or become superseded by new data over time.

an authoritative property location.

This map image is void if the one or more of the following map elements do not appear: basemap imagery, flood zone labels, legend, scale bar, map creation date, community identifiers, FIRM panel number, and FIRM effective date. Map images for unmapped and unmodernized areas cannot be used for regulatory purposes.