



APPLICATION ARTICLE 85 DEMOLITION DELAY REVIEW

Mailing Address:
Environment Dept
Boston City Hall, Rm 709
Boston, MA 02201

For Office Use Only

APPLICATION # _____

RECEIVED _____

SIGNIFICANT _____

HEARING DATE _____

SCAN AND EMAIL TO BLC@BOSTON.GOV AND MAIL HARD COPY

I. PROPERTY ADDRESS 300 The Fenway, Boston, MA 02115 (Parcel ID: 0401842-001)

Simmons University - Park Science Center

NAME of BUSINESS/PROPERTY

The names, phone numbers, postal and email addresses requested below will be used for all subsequent communications relating to this application. Environment Department personnel cannot be responsible for illegible, incomplete or inaccurate contact information provided by applicants.

II. APPLICANT Laura Brink Pisinski VP of University Real Estate & Facilities Mgmt

CONTACT NAME <u>300 The Fenway</u>	RELATIONSHIP TO PROPERTY <u>Boston</u>	MA	02115
MAILING ADDRESS <u>617-521-2127</u>	CITY <u>brink@simmons.edu</u>	STATE	ZIP CODE

PHONE <u>Simmons University</u>	EMAIL <u>Dr. Lynn Wooten</u>
------------------------------------	---------------------------------

PROPERTY OWNER <u>300 The Fenway</u>	CONTACT NAME <u>Boston</u>	MA	02115
MAILING ADDRESS <u>617-521-2127</u>	CITY <u>president@simmons.edu</u>	STATE	ZIP CODE

PHONE	EMAIL
-------	-------

III. DOES THIS PROPOSED PROJECT REQUIRE ZONING RELIEF? No

IF YES, PLEASE INDICATE STATUS OF ZBA PROCESS _____

(If necessary, attach additional pages to provide more information.)

IV. DESCRIPTION OF PROPOSED DEMOLITION:

A BRIEF OUTLINE OF THE PROPOSED WORK **MUST** BE GIVEN IN THE SPACE PROVIDED BELOW, OR THE APPLICATION WILL **NOT** BE ACCEPTED. This description should describe the structure(s) to be demolished and the proposed condition of the site after demolition, including any proposed new construction or site improvements. Additional pages may be attached if necessary to provide more detailed information. See also 4. on page two.

The Park Science Building is situated on the southwest corner of Simmons University campus quad and its western edge abuts Avenue Louis Pasteur. Park Science opened in 1972 and has been the main science facility for Simmons University since that time. It is a 4-story building that contains approximately 103,000 square feet of classrooms, offices and academic laboratories. Please refer to Exhibit 1 for additional detail about the Park Science Building.

Once the current enabling renovations are complete and the Park Science Building is vacant, Simmons proposes to demolish the Park Science Building and construct a new Living and Learning Center (LLC). This new LLC will accommodate relocated athletics facilities, a dining hall, and over 1,000 dormitory beds from aged buildings on the University's Brookline Avenue campus, thus achieving Simmons' vision for One Campus at the Fenway. By unifying Simmons University into one campus with the Living and Learning Center as a new signature building, Simmons will enhance its institutional identity.

V. REQUIRED DOCUMENTATION: The following is a list of documents that **MUST** be submitted with this application. Failure to include adequate documentation will cause a delay in the review process and may result in a rejected application. No documents should be larger than 11x17. See Exhibit 2

- PHOTOGRAPHS:** 3x5 or larger *current* color photographs of the property, properties affected by the proposed demolition and surrounding areas must be labeled with addresses and dates. Major elevations of the building(s) and any deterioration or reason for demolition should be documented. Photographs of the subject property seen from a distance with neighboring properties are required. All photographs must be keyed to a map (see below) to provide a thorough location description. **Images from the internet are not acceptable.**
- MAP:** A map showing the location of the property affected by the proposed demolition must be submitted with this application. The map must be an 8 1/2 x 11 portion of a street map, such as from a BPDA locus map or an internet mapping site.
- PLOT PLAN:** A plot plan showing the existing building footprint and those of buildings in the immediate vicinity must be submitted with this application. Assessing parcel maps will be accepted, if the footprint of the relevant structure(s) is illustrated.
- PLANS and ELEVATIONS:** If a new structure is being planned, a site plan, building plans and elevations of the new structure(s) must be submitted. If no new building is planned, submit plans for site improvements and a written narrative describing the proposed use and treatment of parcel. (Parking, landscaping, clear debris, fill excavations, etc.) **Do not submit sheets larger than 11x17.**
- PROOF OF OWNERSHIP:** Proof of ownership must be submitted with the application. A copy of a property deed, property tax assessment bill, or other official documentation of property ownership is required.

NOTE: Copies of all documentation submitted with this application (photographs, maps, plot plans, etc.) should be retained by the applicant should additional copies be necessary for a commission hearing. Additional materials will be requested if a hearing is required.

VI. NOTARIZED SIGNATURES: Both the applicant's and the legal property owner's signatures must be notarized. In cases of multiple ownership, the chair of the condominium or cooperative association or authorized representative (such as a property manager) shall sign as owner; in cases of institutional ownership, an authorized representative of the organization shall sign as owner.

The facts set forth above in this application and accompanying documents are a true statement made under penalty of perjury.

APPLICANT Laura Brink Pisinski

OWNER* Lynn Perry Wooten


*(If building is a condominium or cooperative, the chairman must sign.)

PRINT Laura Brink Pisinski

PRINT Lynn Perry Wooten

On this 14 day of February, 2022, before me, the undersigned Notary Public, personally** appeared Laura Brink Pisinski (name of document signer), proved to me through satisfactory evidence of identification, which were Driver's License, to be the person whose name is signed on the preceding or attached document in my presence.


LaTanya Maxwell
My Commission Expires:

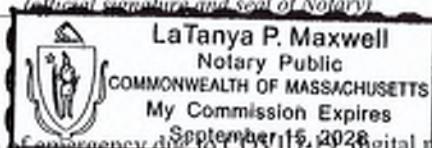

**During the declared state of emergency due to COVID-19 digital notarization is allowed.

On this 14 day of February, 2022, before me, the undersigned Notary Public, personally** appeared Lynn Perry Wooten (name of document signer), proved to me through satisfactory evidence of identification, which were Driver's License, to be the person whose name is signed on the preceding or attached document in my presence.

LaTanya Maxwell
My Commission Expires:

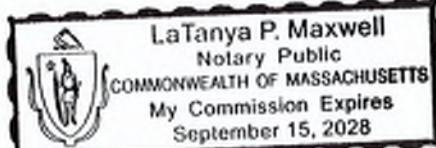

Environment Department personnel cannot be responsible for verifying the authority of the above individuals to sign this application. Misrepresentation of signatory authority may result in the invalidation of the application.

Please review all instructions and documentation requirements carefully before submitting your application. It is your responsibility to ensure the application is complete before submittal. **Incomplete applications will not be accepted.**

Once you have submitted the application, staff will review for completeness and will be in touch about next steps.

EXHIBIT 1 - DESCRIPTION OF PROPOSED DEMOLITION

Architectural Description (per MACRIS survey, 2017)

Designed by Campbell Aldrich and Nulty Architects, the square building rises four stories to a flat roof, with projecting five-story tower elements at the northwest, southwest and southeast corners. Walls are clad with subtly variegated dark brown brick; narrow belt courses above each level at the window lintel height are composed of five courses of an orange-brown brick. There is no wall cornice treatment. Windows are typically horizontal bands of plate glass units, flush with the wall plane. The tower elements typically feature a narrow, offset, deeply recessed bay with continuous vertical glazing and one splayed jam.

The north elevation is oriented toward the main campus quadrangle. The ground floor has deeply recessed entrance in the penultimate bay from the west, containing two pairs of double-leaf doors, infill glazing and a canted top edge. Although there are no windows on this level its is articulated with pairs of deeply recessed narrow vertical channels. Horizontal bands of plate glass windows line the upper three floors.

The west elevation is composed similarly to the north façade with narrow recessed channels at the ground floor and banded horizontal windows on the second through fourth floors. The south driveway elevation steps back to the east of the southwest corner tower which is blank but decorated with discontinuous bands of orange brick that wrap around the corners. East of the tower element the first floor has a deeply recessed band of windows with brick sills and piers and a canted top; banded windows on the upper floors are flush with the wall plane. The east elevation contains a loading bay and pedestrian door in its wide tower section as well as 4 ½ story bay of vertical metal louvers near the northeast corner of the tower.

Discussion

The Park Science Building's limited natural light and older laboratory configuration make it unsuited to provide the modern laboratories expected at universities such as Simmons where over 50% of undergraduates major in laboratory sciences. As described in its IMP submitted to the BPDA (approved 11/12/2020), Simmons University is undertaking a significant renovation and reorganization of other existing campus space to replace and modernize the function of the Park Science Building in support of the mission of Simmons University. To enable the creation of a new science facility, Simmons will decant Lefavour Hall and the west wing of the Main College Building and will then transform these two buildings to accommodate a reconfigured library as well as labs, classrooms and offices needed to support the chemistry, biology, physics, nursing, physical therapy and other programs of the College of Natural, Behavioral, and Health Sciences.

The Park Science Building exterior is dark brown brick, does not include any windows on the first level and includes only one deeply recessed entry along the quad elevation. These materials and ground floor design do not contribute light or ground floor vibrancy to either the campus quad or Avenue Louis Pasteur. The design of the new LLC will reflect its role as a campus center that includes the active uses of dining, living and athletics. It's multiple entries and windows into the building's activities will significantly increase the animation and activity experienced from the campus quad.

In addition, the Park Science Building was constructed during a period of time when there was less street activity along Avenue Louis Pasteur than exists today and it therefore does not engage the street. The BPDA adopted “LMA Interim Guidelines” in 2003 to inform the BPDA’s consideration of development within the LMA. Consistent with the Guidelines, the new LLC will maintain the prevailing urban street wall along Avenue Louis Pasteur while enlivening the streetscape with active ground floor uses and transparent materials, a significant improvement over the Park Science Building’s presence today.

EXHIBIT 2 – REQUIRED DOCUMENTATION



1. PARK SCIENCE NW CORNER. TAKEN FROM AVENUE LOUIS PASTEUR FAR SIDEWALK



2. PARK SCIENCE SW CORNER. TAKEN FROM AVENUE LOUIS PASTEUR FAR SIDEWALK



3. PARK SCIENCE SW CORNER. TAKEN FROM AVENUE LOUIS PASTEUR.
ADJACENT BUILDINGS SHOWN FOR CONTEXT; SIMMONS UNIVERSITY LEFAVOUR & BOSTON LATIN SCHOOL





4. PARK SCIENCE SOUTH ELEVATION. TAKEN FROM SERVICE DRIVE LOOKING EAST



5. PARK SCIENCE NE CORNER. TAKEN FROM SIMMONS QUADRANGLE OUTSIDE SIMMONS MAIN COLLEGE BUILDING



6. PARK SCIENCE NE CORNER. TAKEN FROM NE CORNER OF SIMMONS CAMPUS



PHOTOGRAPHS

Article 85 - Park Science Demo Permit Document Support


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3 D U F H O V



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ArcGIS Web AppBuilder

See web site for license constraints. | Map data © OpenStreetMap contributors, CC-BY-SA |

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ArcGIS Web AppBuilder
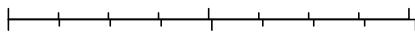
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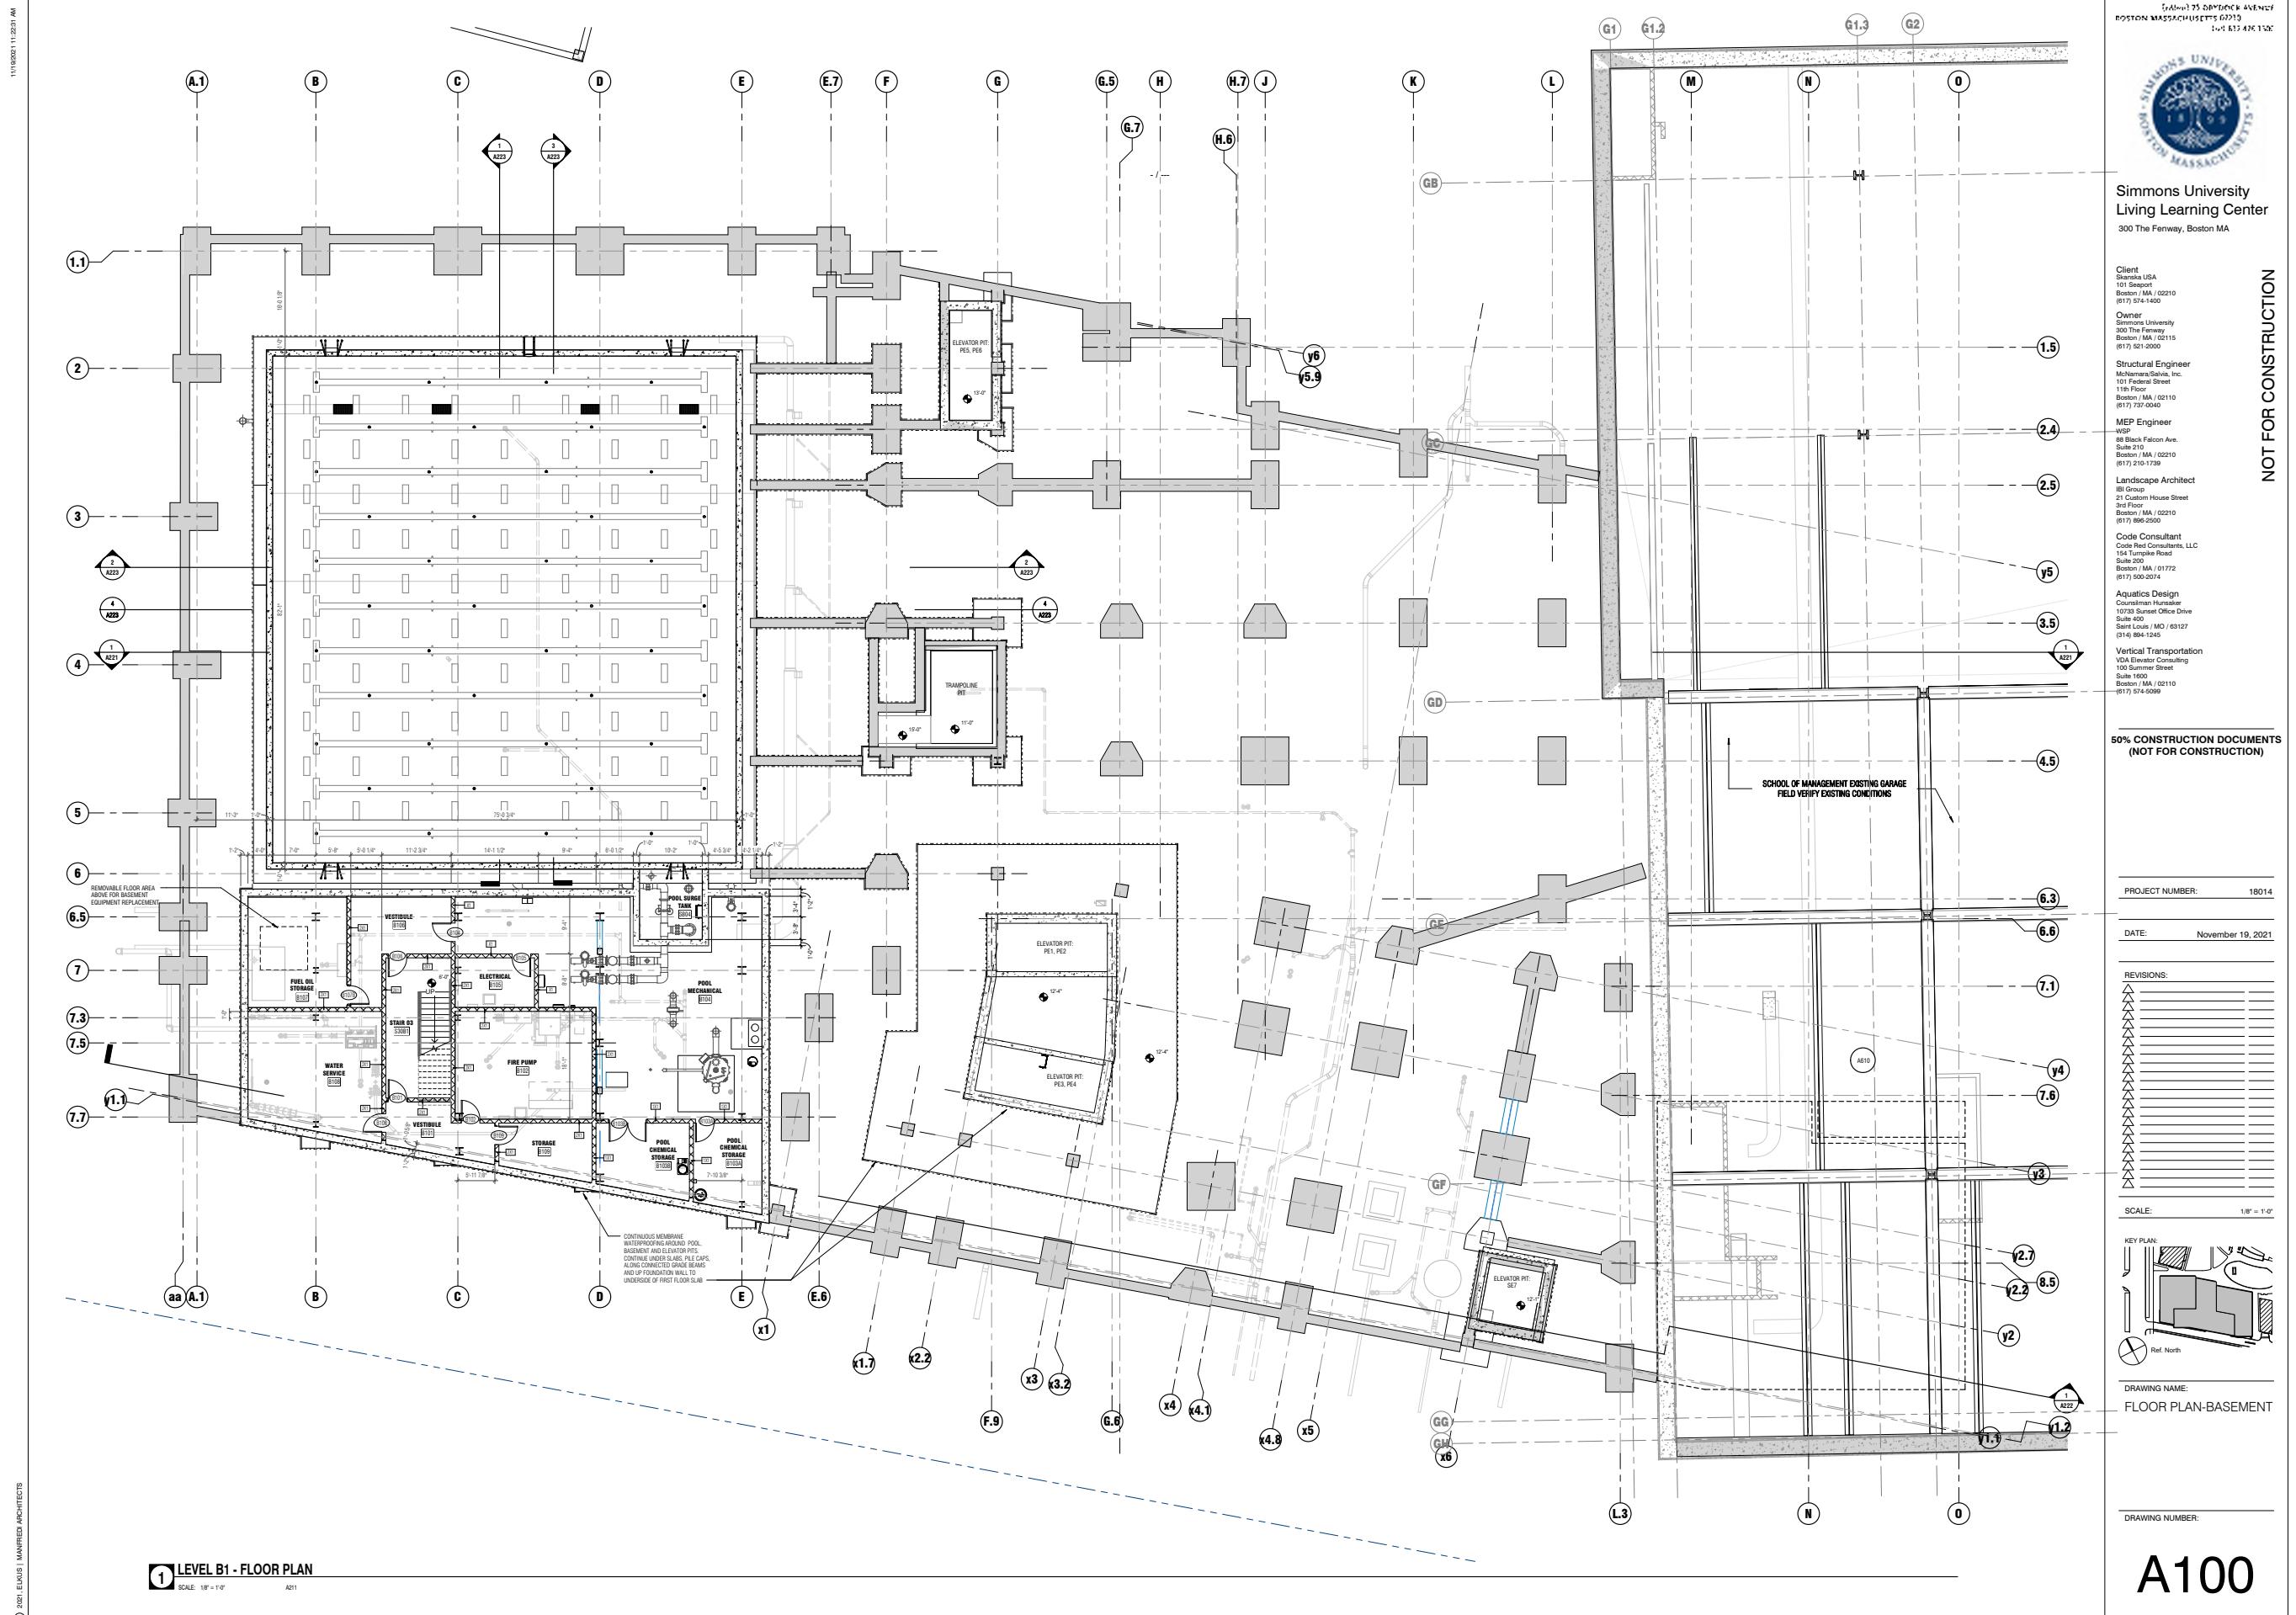
PLOT PLAN
Article 85 - Park Science Demo Permit Document Support
UL & OGHI





Simmons University
Living Learning Center
300 The Fenway, Boston MA

NOT FOR CONSTRUCTION



(c)(6)(B) 73 DRYDOCK AVENUE
BOSTON MASSACHUSETTS 02210
(617) 426-1500



Simmons University
Living Learning Center
300 The Fenway, Boston MA

Client
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01 Seaport
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Owner
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Structural Engineer

INSTRUCTION

FOR CON

DT FC

NC
landscape Architect
BI Group
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rd Floor
oston / MA / 02210
(317) 896-2500

Code Red Consultants, LLC
54 Turnpike Road
uite 200
oston / MA / 01772
415-555-1234

Aquatics Design
Councilman Hunsaker
10723 Sunset Office Drive

Vertical Transportation
DA Elevator Consulting
100 Summer Street
Suite 1600
Boston / MA / 02110

9% CONSTRUCTION DOCUMENTS
(NOT FOR CONSTRUCTION)

PROJECT NUMBER: 18814

DATE: November 19, 2021

REVISIONS:

A set of three horizontal lines for drawing, each accompanied by a small triangle icon at the left end.

SCALE: $10^{\circ} = 1' 0''$

KEY PLAN:

DRAWING NAME:
FLOOR PLAN LEVEL 1

DRAWING NUMBER:

A101

NOT FOR CONSTRUCTION

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This detailed architectural floor plan illustrates the layout of a large building complex, possibly a sports facility or community center. The plan includes various functional areas such as a swimming pool, aquatics corridor, team rooms, visitor lockers, and a trampoline room. It also features several levels of seating, including tiered seating areas and a main arena. The plan shows extensive use of steel columns and beams, with some columns highlighted in red. Numerous labels and callouts provide specific details about certain features, such as 'PAINTED EPOXY CANE RAIL DETECTOR' and 'REFRESHMENT PLASTIC BENCH ON PAINTED STEEL METAL SUPPORT'. The plan is annotated with dimensions, room names, and various symbols representing doors, windows, and structural elements. A legend at the bottom right provides definitions for symbols like 'GREASE TRAP ACCESS MANHOLE COVERS' and 'HINGED LOUVER PANEL PER EVERSOURCE REQUIREMENTS'.


1 LEVEL 1 - FLOOR PLAN

SCALE: 1/8" = 1'-0"



Simmons University
Living Learning Center
300 The Fenway, Boston MA

NOT FOR CONSTRUCTION

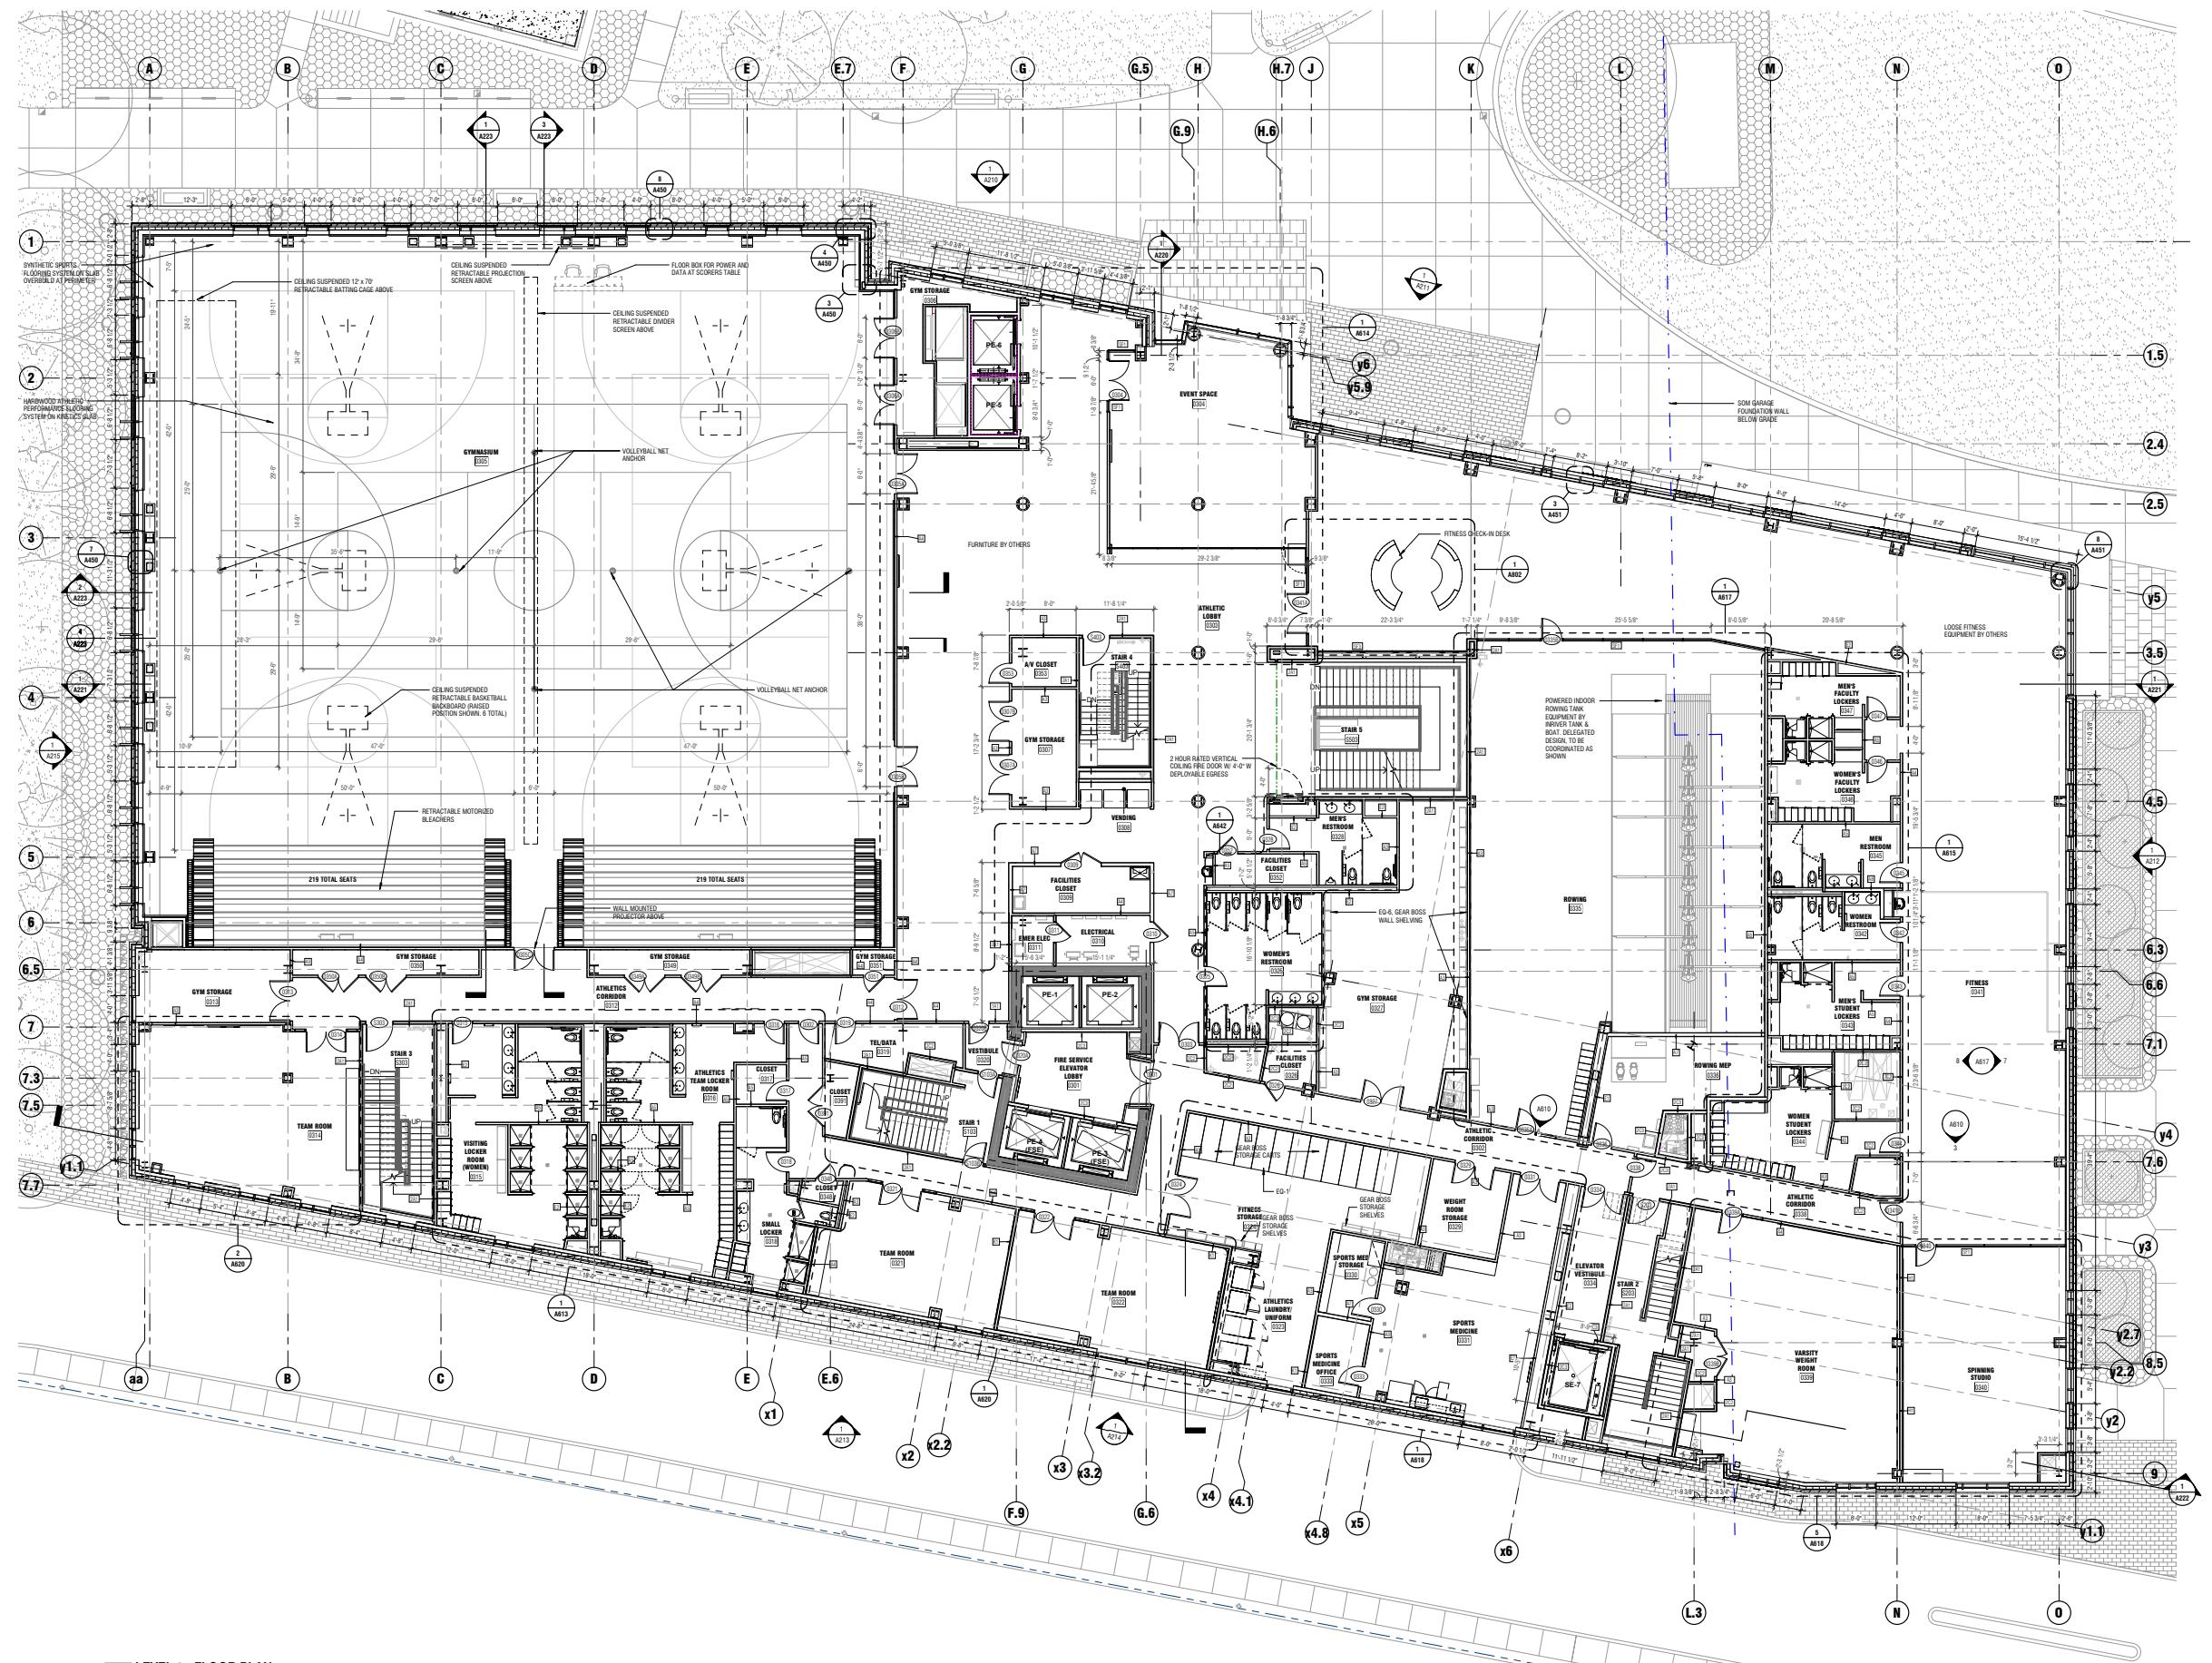


PROJECT NUMBER: 18014

DATE: November 19, 2021

REVISIONS:

SCALE: 1/8" = 1'-0"


KEY PLAN:

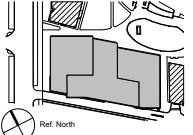


DRAWING NAME: FLOOR PLAN-LEVEL 3

DRAWING NUMBER:

A103

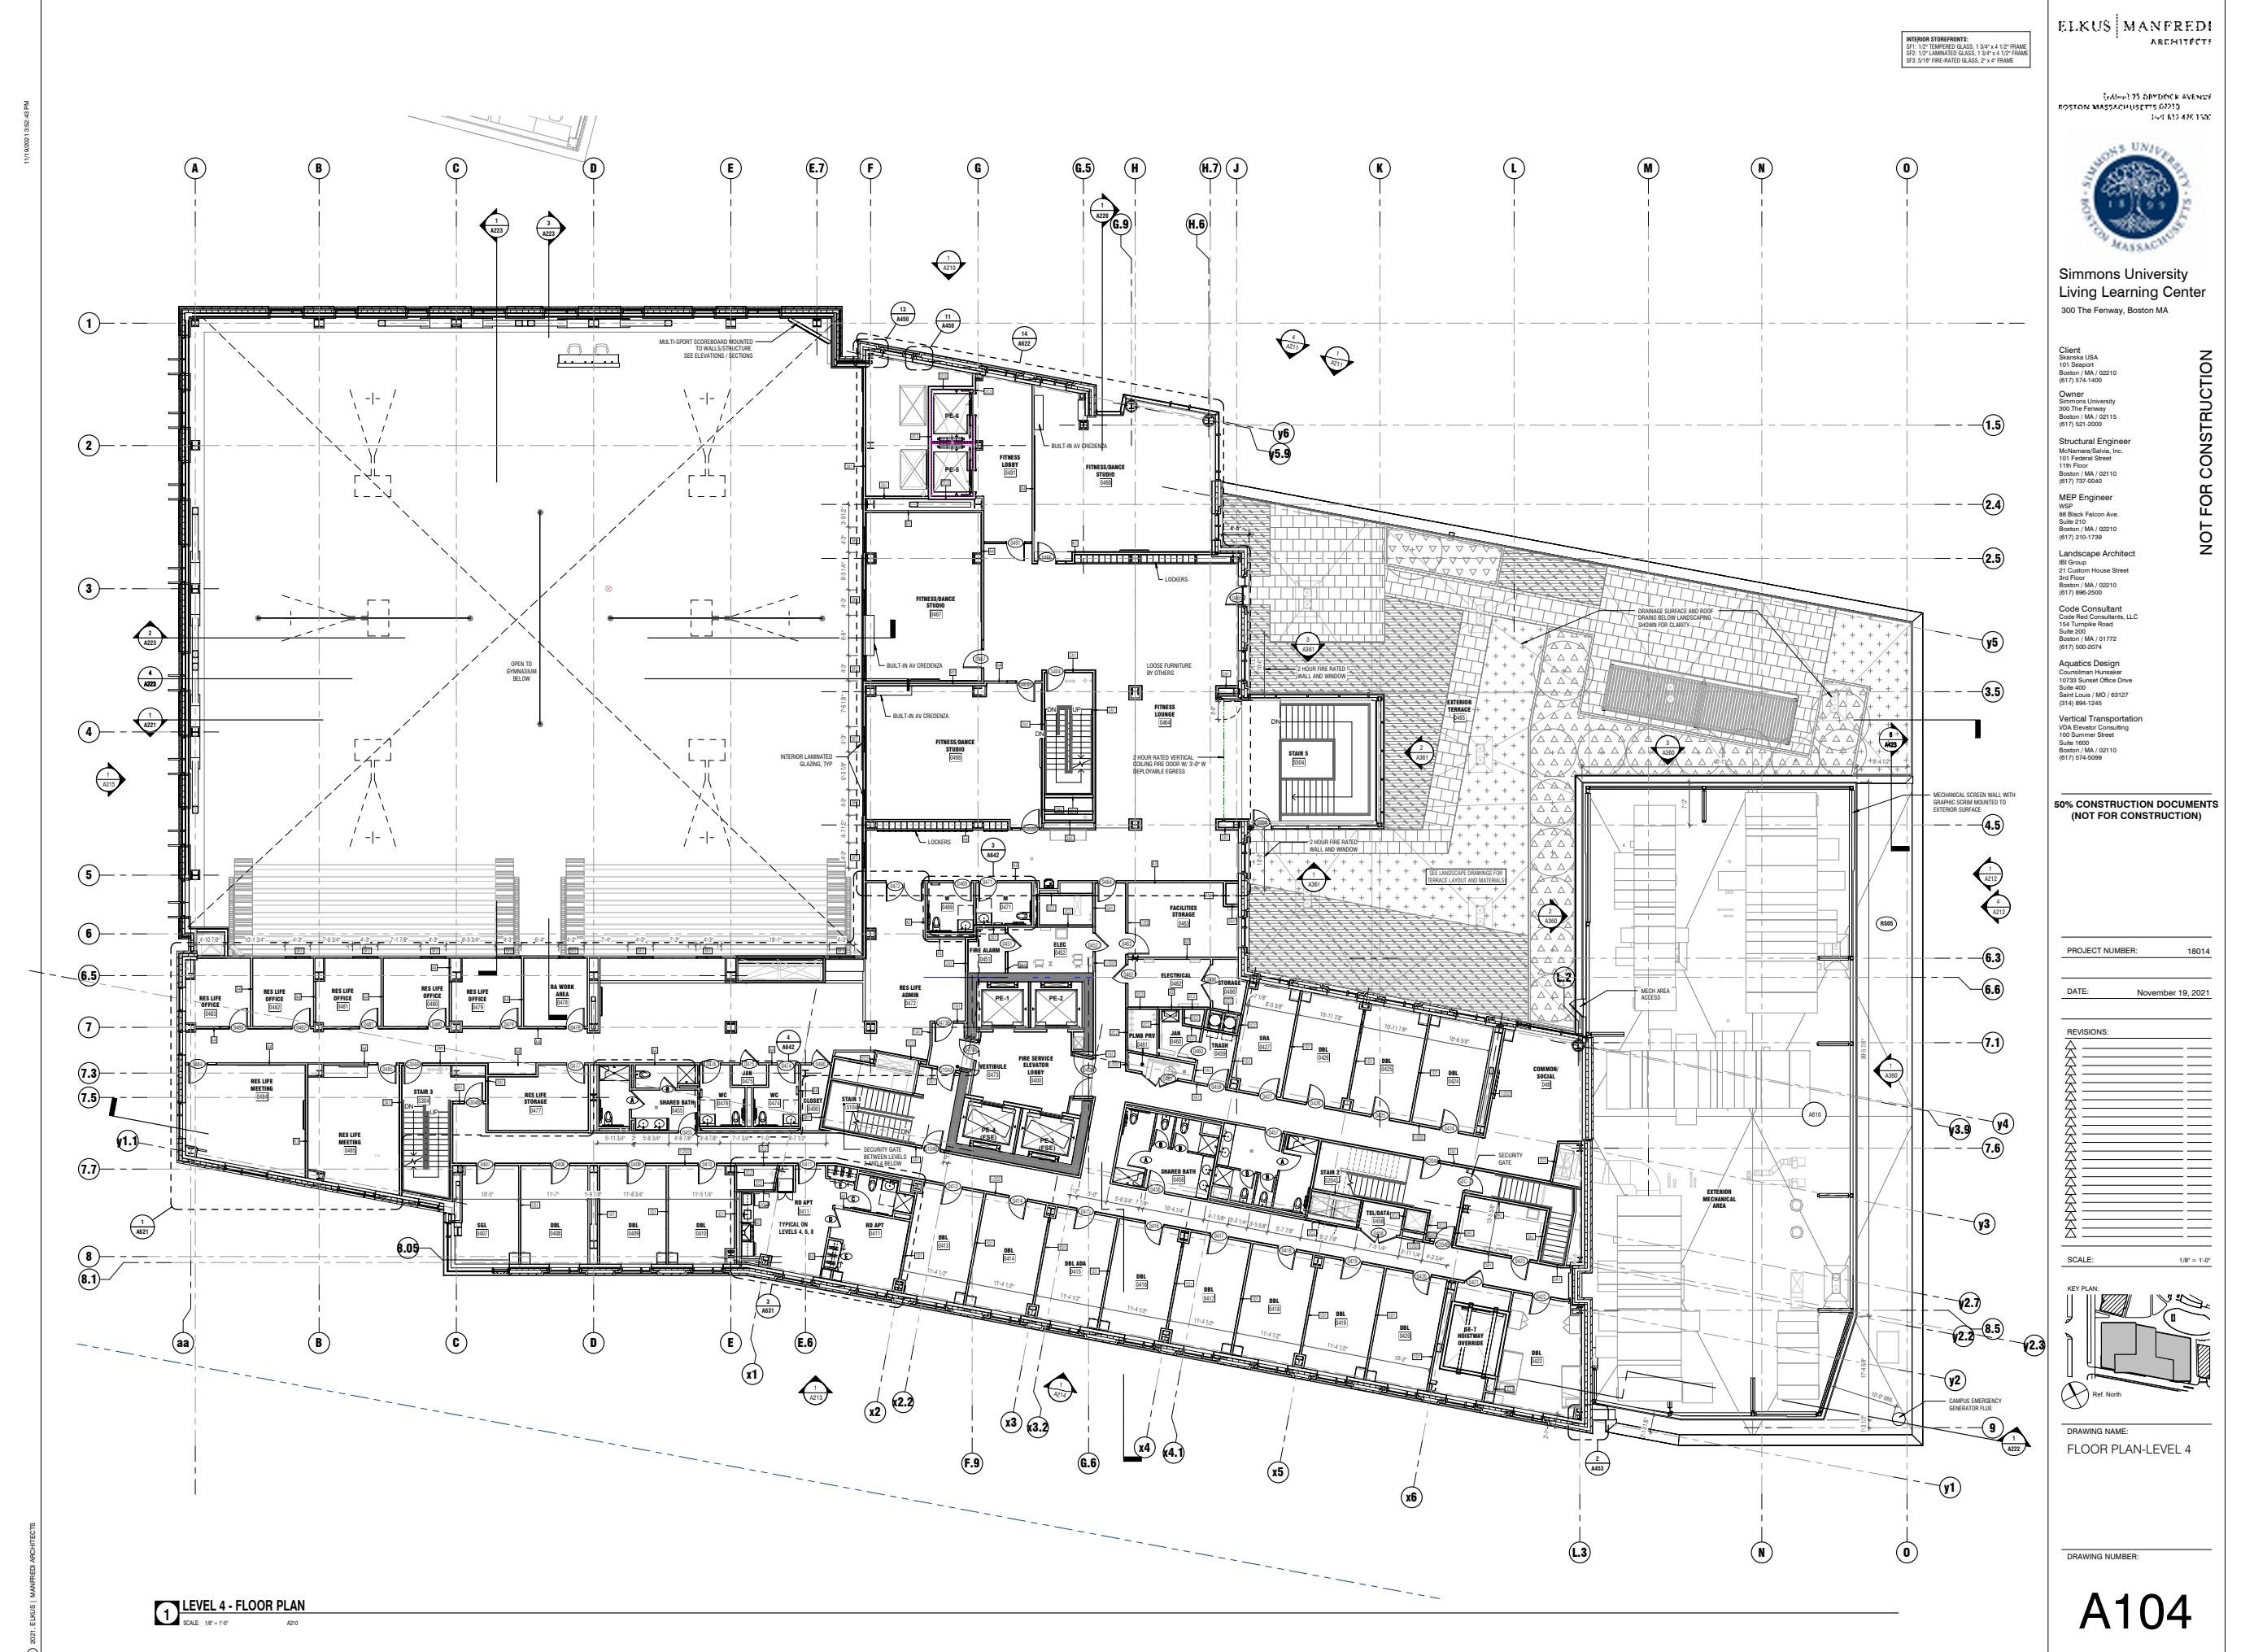

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ELKUS MANFREDI
ARCHITECTS
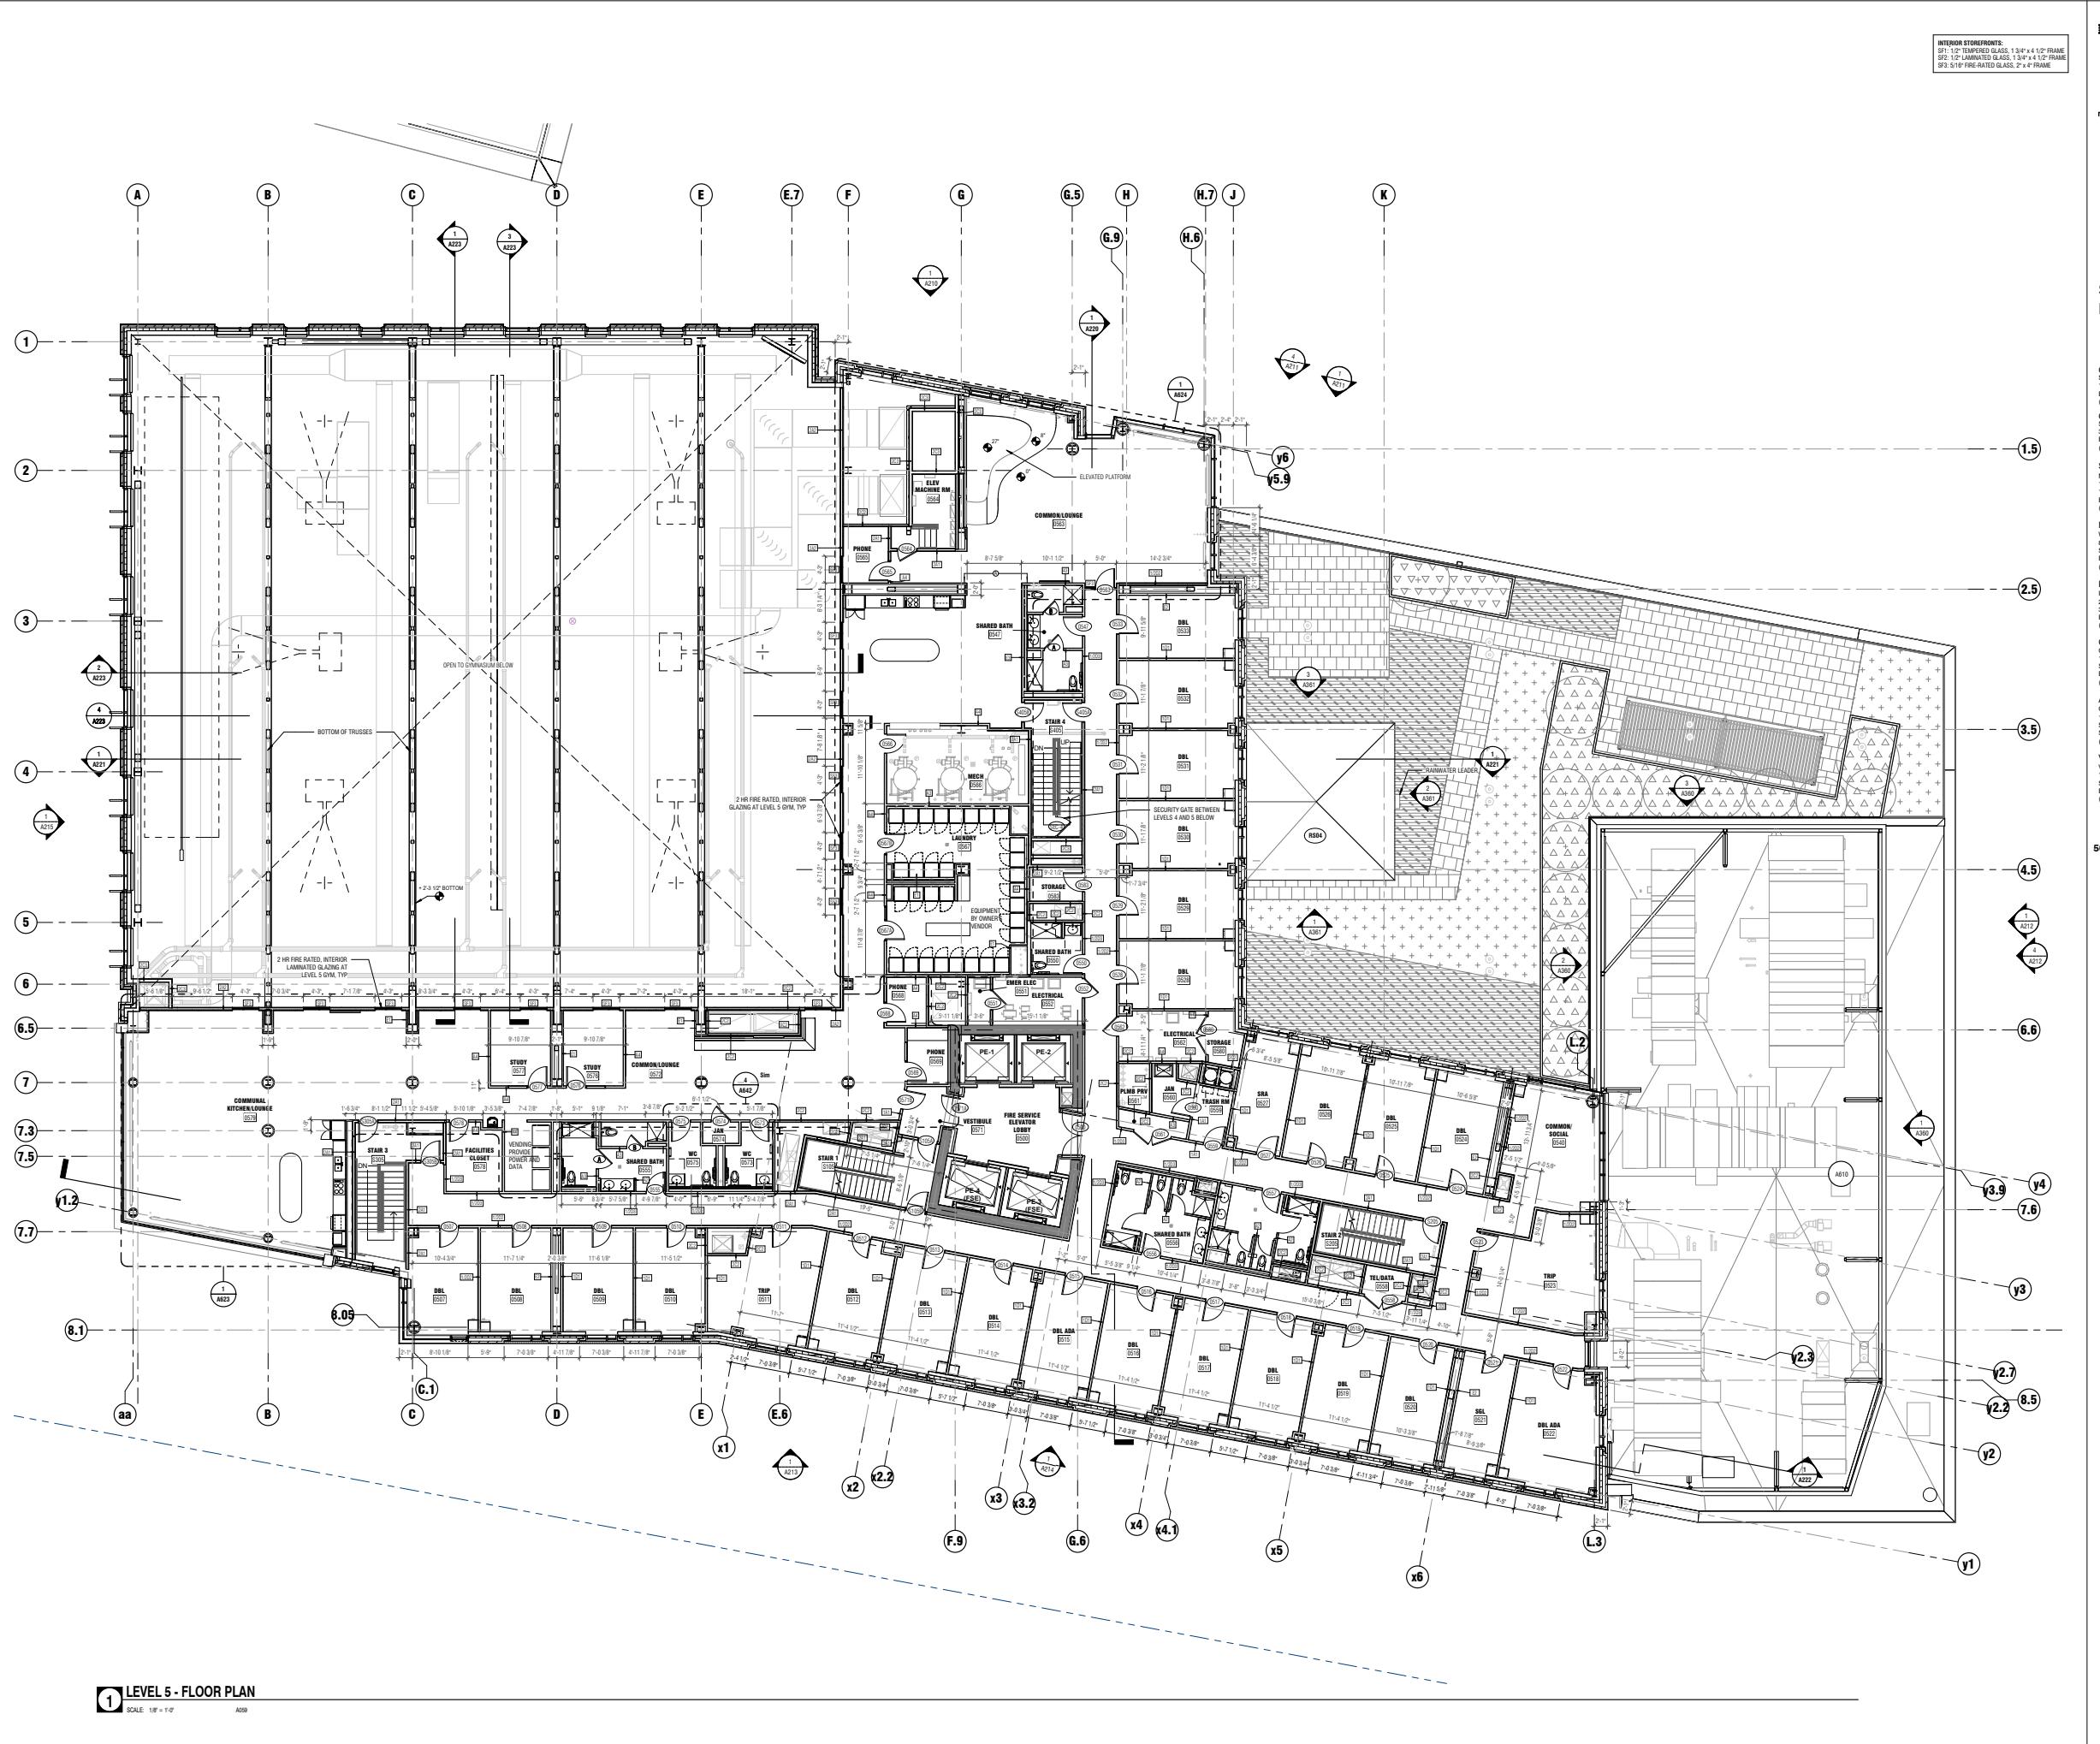
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(617) 426 1500



Simmons University
Living Learning Center
300 The Fenway, Boston MA

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(617) 574-1450

Owner:
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(617) 986-2500

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Salisbury, MD / 20127
(314) 884-1245

Vertical Transportation:
VDA Elevator Consulting
100 Summer Street
Suite 400
Boston / MA / 02110
(617) 574-5099


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(NOT FOR CONSTRUCTION)

PROJECT NUMBER:
18014

DATE:
November 19, 2021

REVISIONS:


SCALE:
1/8" = 1'-0"

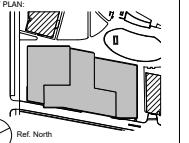

DRAWING NAME:
FLOOR PLAN-LEVEL 6


DRAWING NUMBER:

A106

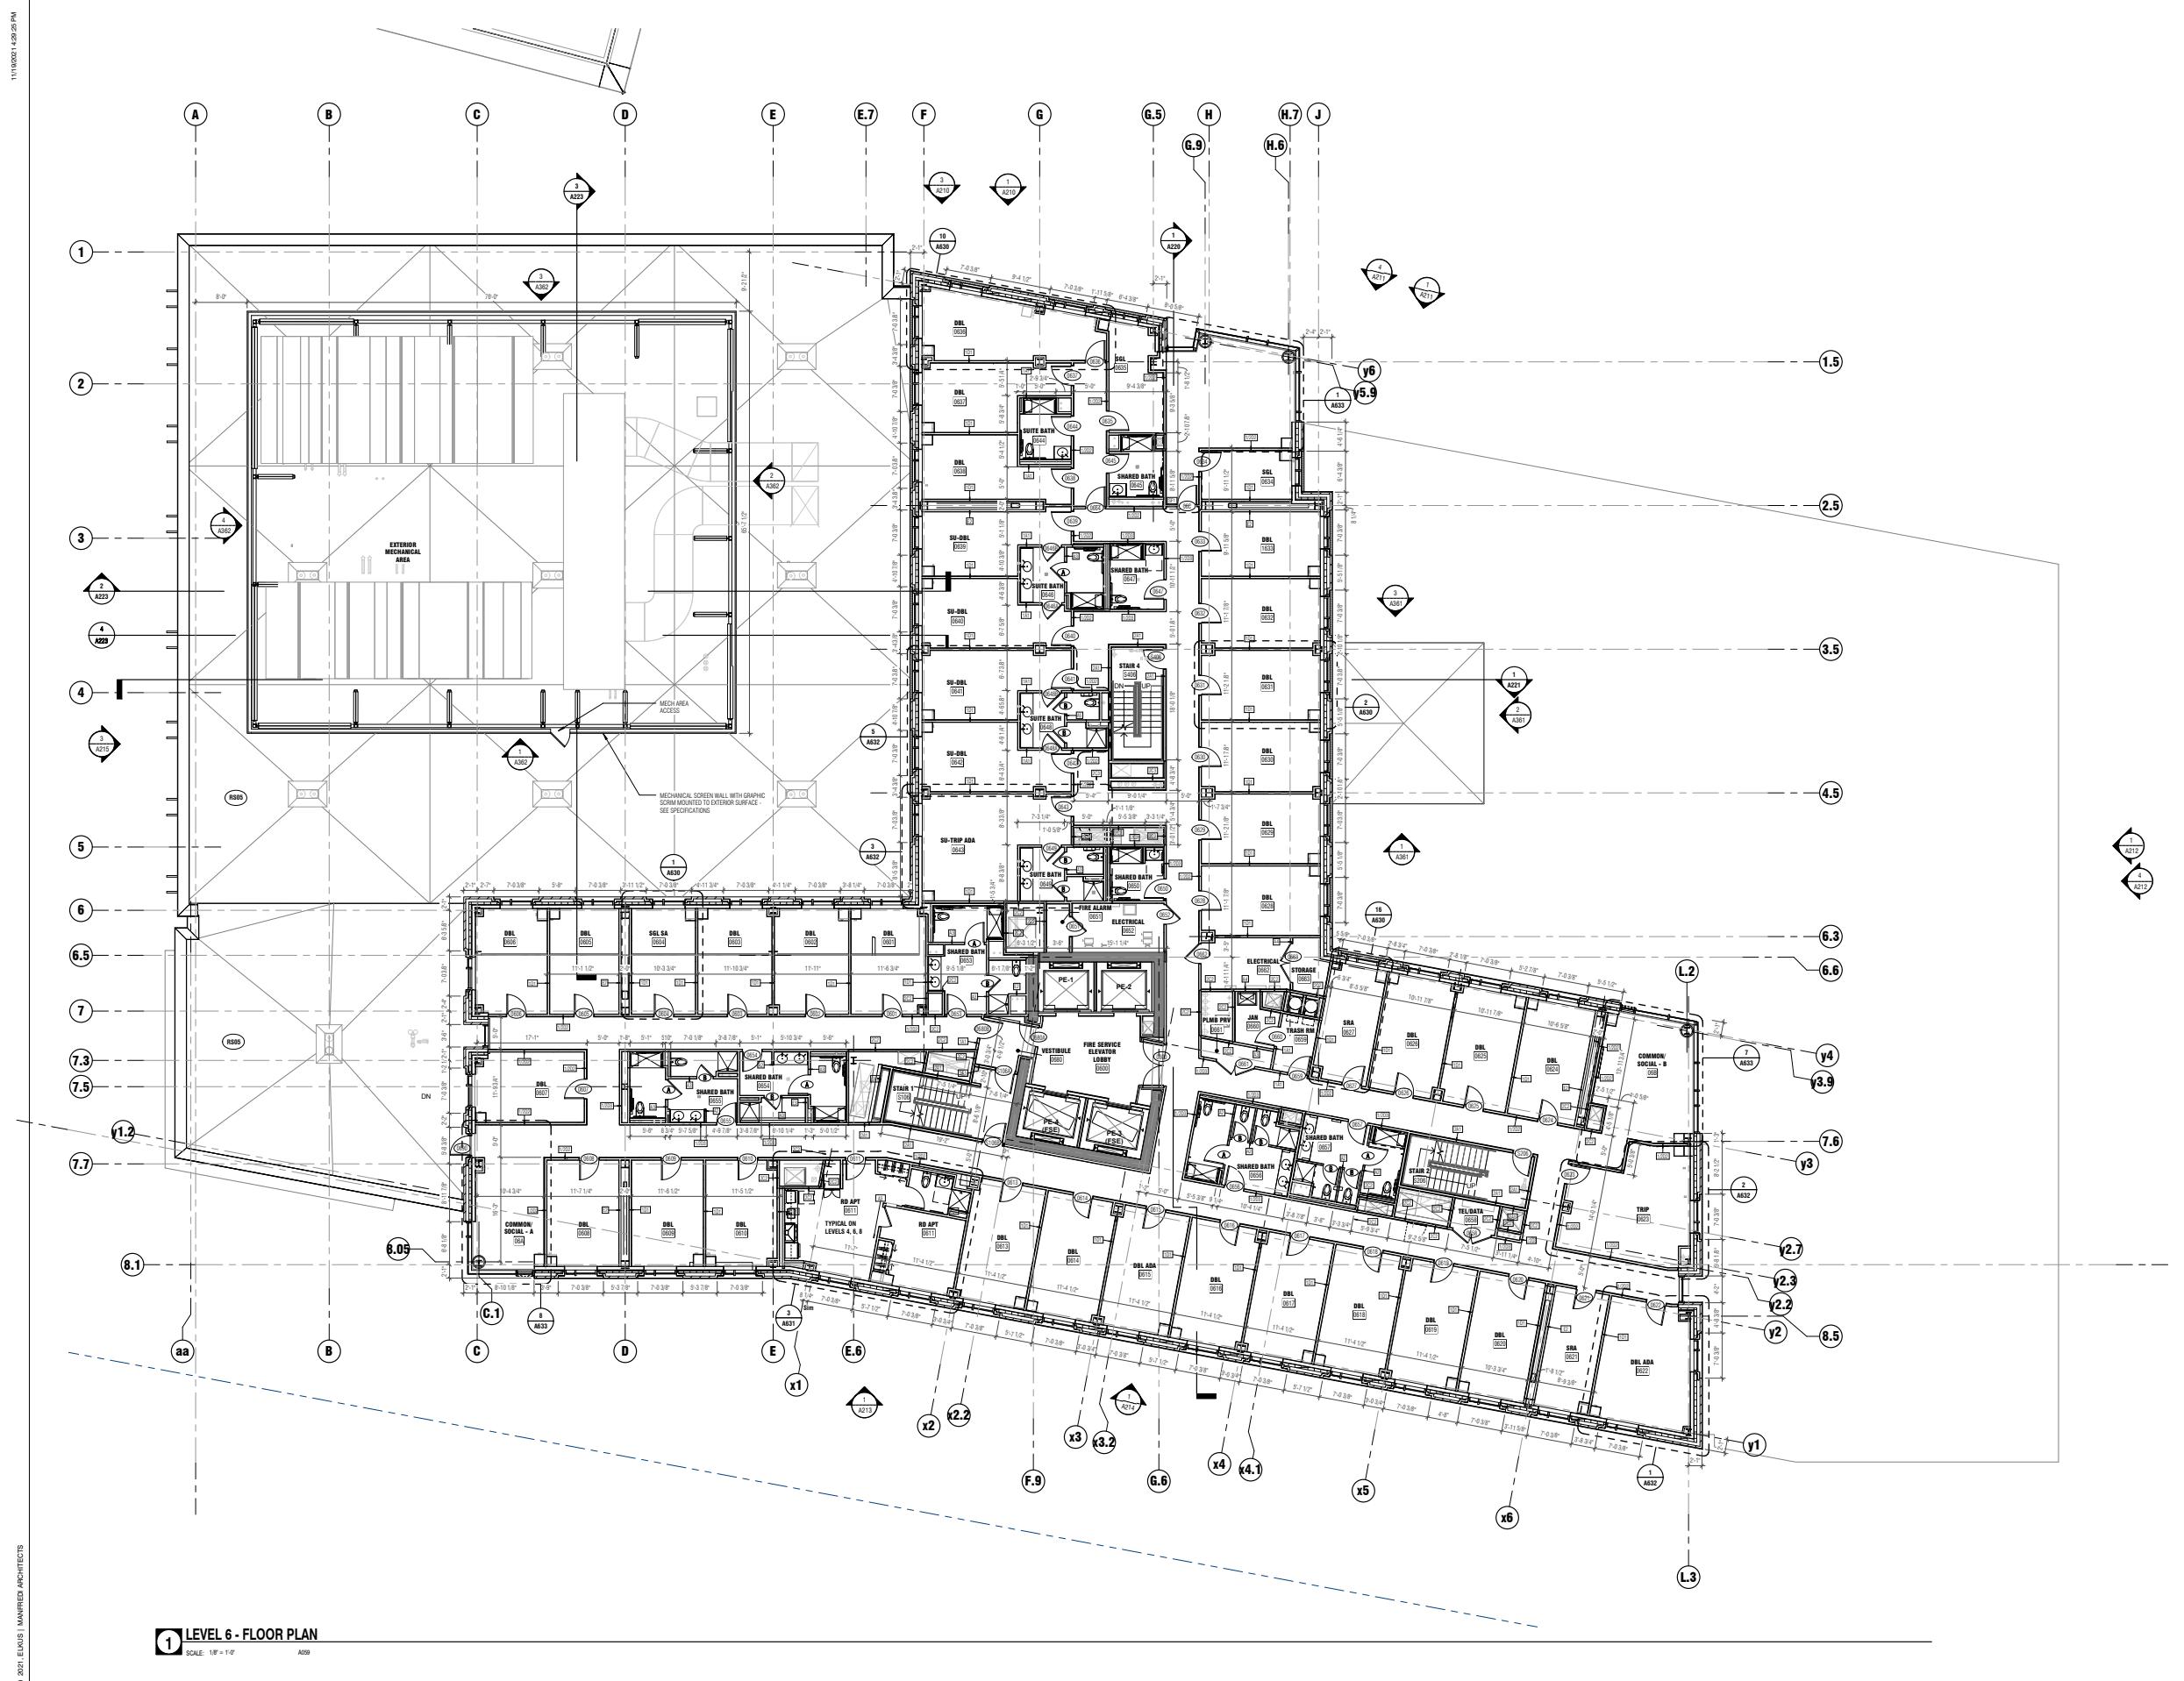

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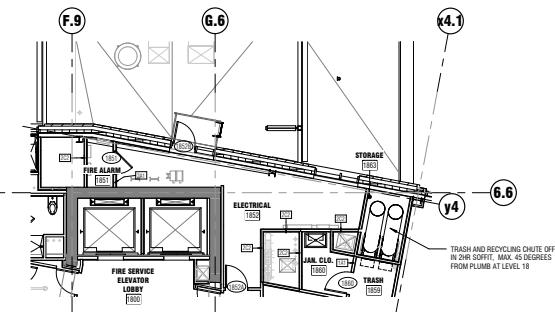
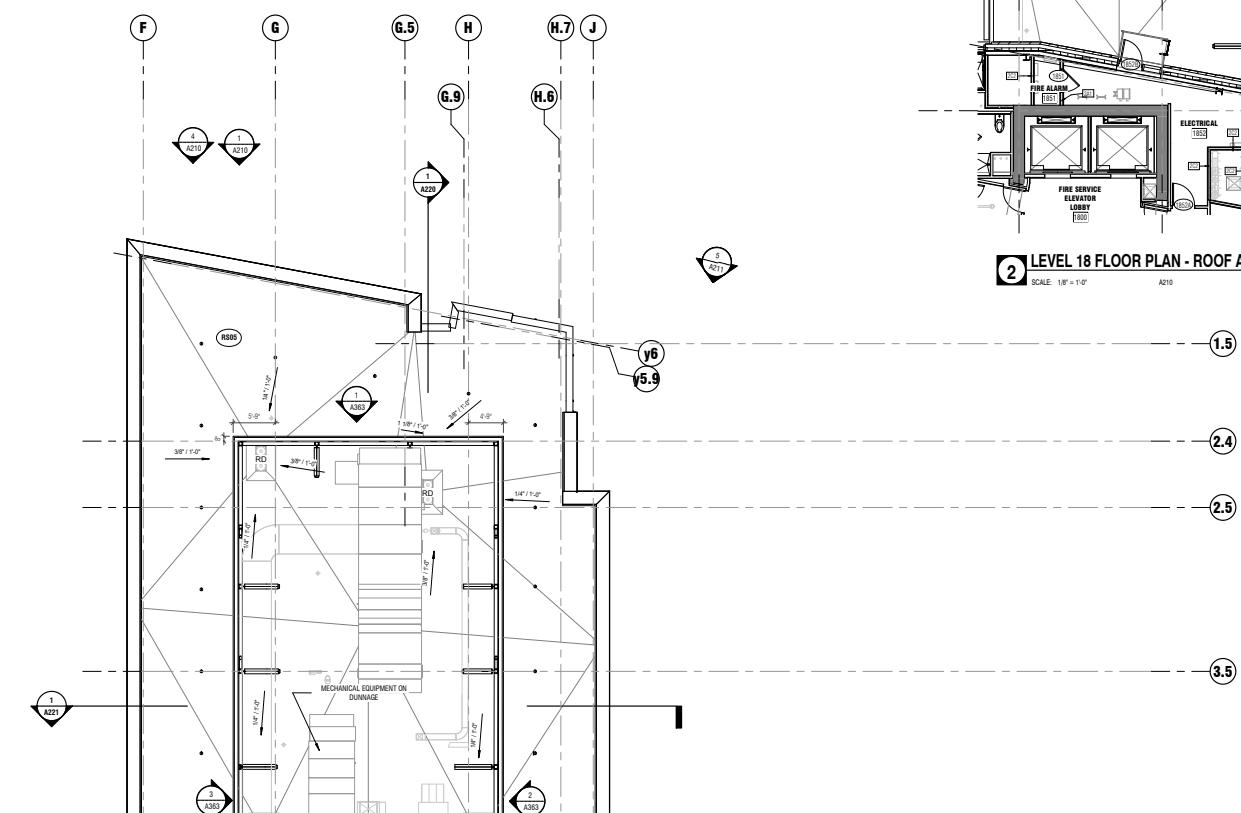
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1 LEVEL 17 FLOOR PLAN

© 2021 ELKUS MANFREDI ARCHITECTS

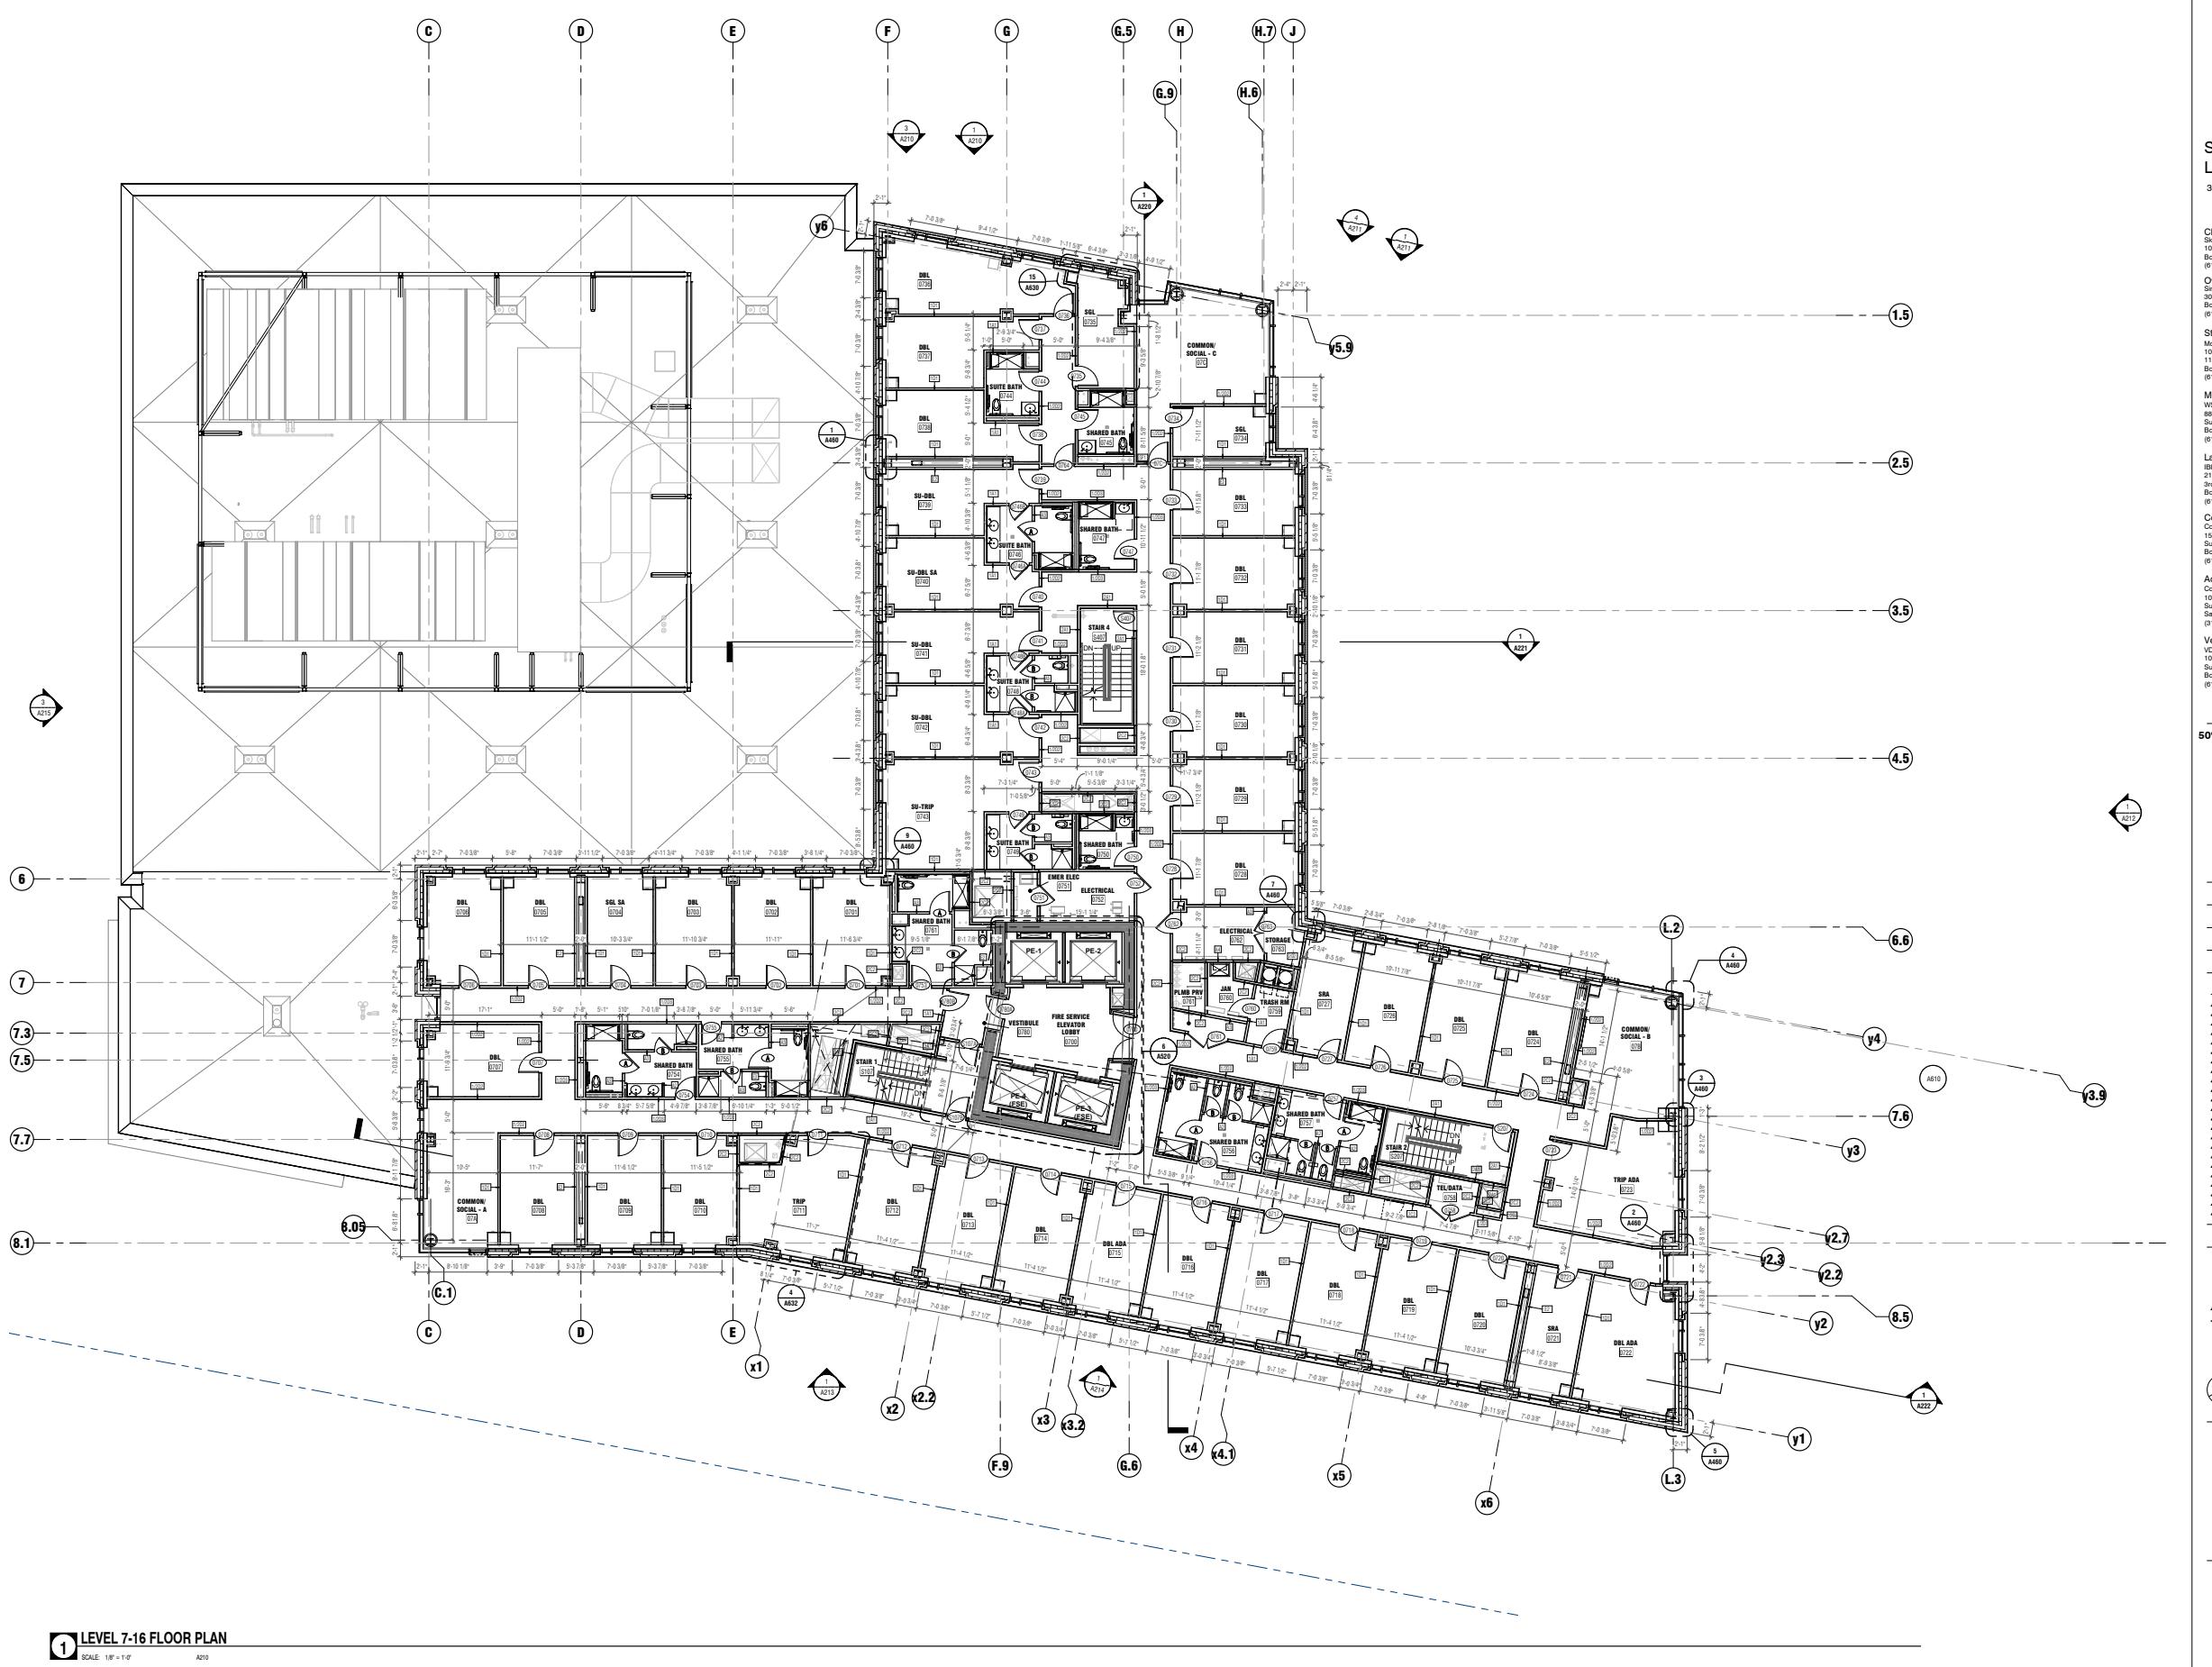

2 LEVEL 18 FLOOR PLAN - ROOF ACCESS

ELKUS | MANFREDI
ARCHITECTS

75 DINWOODIE AVENUE
BOSTON MASSACHUSETTS 02219
(617) 426-1526



Simmons University
Living Learning Center
300 The Fenway, Boston MA

Client:
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101 Seaport
Boston / MA / 02210
(617) 574-1450

Owner:
Simmons University
300 The Fenway
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(617) 521-2000

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MEP Engineer:
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Code Consultant:
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Aquatics Design:
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(314) 884-1245

Vertical Transportation:
VDA Elevator Consulting
100 Summer Street
Suite 400
Boston / MA / 02110
(617) 524-5099


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(NOT FOR CONSTRUCTION)**

PROJECT NUMBER: 18014

DATE: November 19, 2021

REVISIONS:

SCALE: 1'0" = 1'-0"

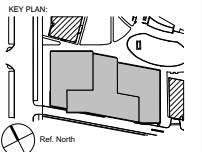

DRAWING NAME:
FLOOR PLAN-LEVEL
17-18 TYP.

DRAWING NUMBER:

A108



Simmons University
Living Learning Center
300 The Fenway, Boston MA

Client:
Skanska USA
101 Seaport Blvd., Boston, MA 02210
(617) 520-1450

Owner:
Simmons University
300 The Fenway
Boston / MA / 02215
(617) 521-2000

Structural Engineer:
McNamara/Salvia, Inc.
101 Federal Street
11th Floor
Boston / MA / 02110
(617) 737-0640

MEP Engineer:
WSP
888 Black Falcon Ave.
Suite 210
Boston, MA 02210
(617) 210-1729


Landscape Architect:
BB Group
21 Custom House Street
3rd Floor
Boston, MA / 02210
(617) 886-2500

Code Consultant:
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Boston / MA / 01772
(617) 500-2074

Aquatics Design:
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Suite 400
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Vertical Transportation:
VDA Elevator Consulting
100 Summer Street

NOT FOR CONSTRUCTION

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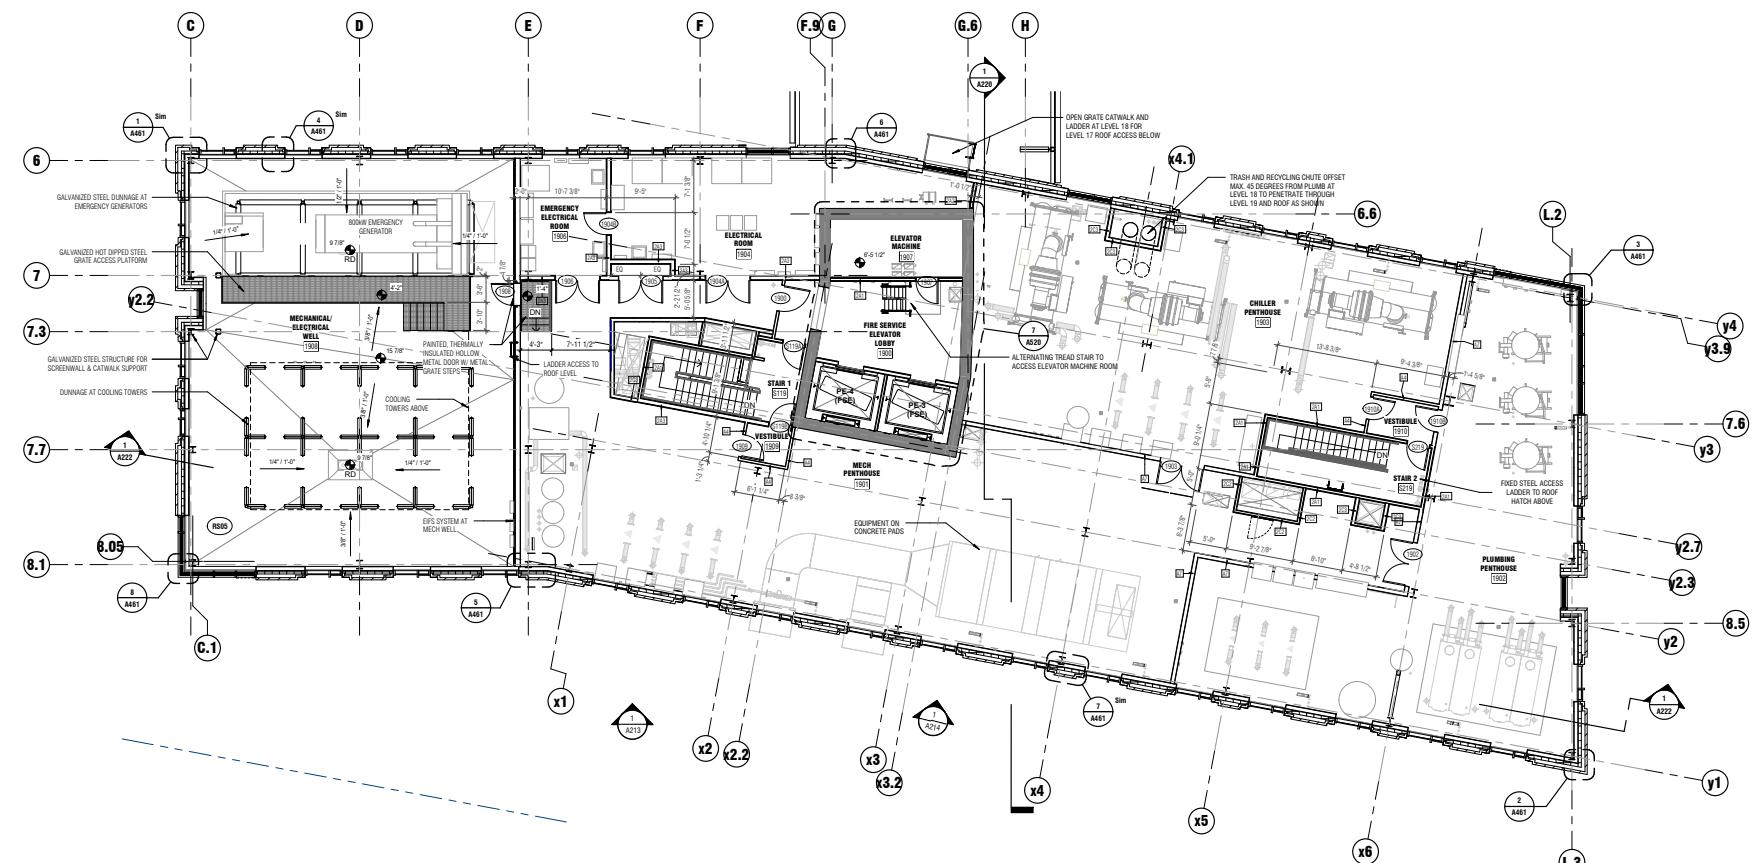


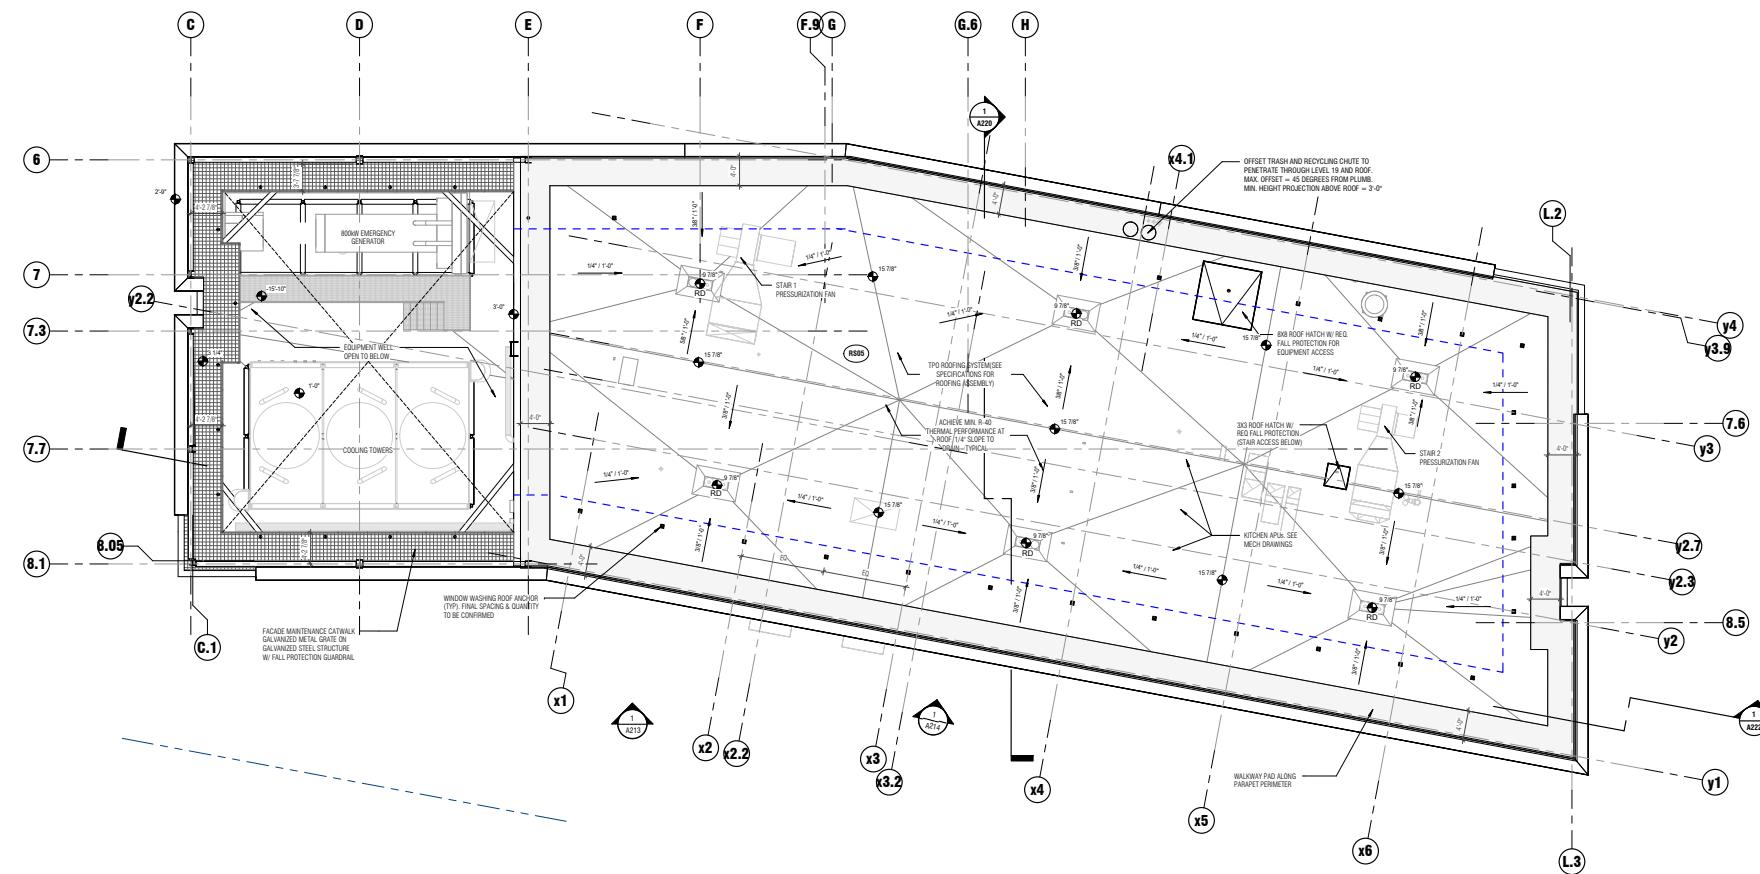2 LEVEL 20 - ROOF

SCALE: 1'0" = 1'-0"

A210

50% CONSTRUCTION DOCUMENTS
(NOT FOR CONSTRUCTION)



1 LEVEL 19 - MECHANICAL PENTHOUSES

SCALE: 1'0" = 1'-0"


A210

PROJECT NUMBER: 18014

DATE: November 19, 2021

REVISIONS:

SCALE: 1'0" = 1'-0"

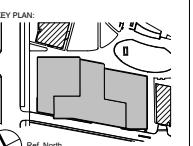

KEY PLAN:
DRAWING NAME:
FLOOR PLAN -
MECHANICAL
PENTHOUSES AND
ROOF

DRAWING NUMBER:

A109



Simmons University
Living Learning Center
300 The Fenway, Boston MA

Client:
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(617) 574-1450

Owner:
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(617) 986-2500

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(314) 894-1245

Vertical Transportation:
VDA Elevator Consulting
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Suite 200
Boston / MA / 02110
(617) 574-5099


50% CONSTRUCTION DOCUMENTS (NOT FOR CONSTRUCTION)

PROJECT NUMBER: 18014

DATE: November 19, 2021

REVISIONS:

SCALE: As indicated

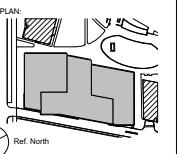

DRAWING NAME:
BUILDING ELEVATION -
NORTH ORTHOGONAL

DRAWING NUMBER:

A210

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NOT FOR CONSTRUCTION

WALL TYPE
KEY NOTE

NOTE:
THE EXTERIOR WALL TYPES
SCHEDULE ON A200 ARE DETAILED
DESCRIPTIONS OF
EACH KEY NOTE TYPE.

TAG TYPE

WT11 BRICK VENEER WALL - NATATORIUM

WT12 BRICK VENEER WALL - GYMNASIUM

WT13 BRICK VENEER WALL - PODIUM

WT14 ALUMINUM AND GLASS
CURTAINWALL SYSTEM -
NATATORIUM

WT15 ALUMINUM AND GLASS
CURTAINWALL SYSTEM -
GYMNASIUM

WT16 ALUMINUM AND GLASS
CURTAINWALL SYSTEM -
PODIUM

WT17 ARCHITECTURAL SCREENWALL

WT18 ARCHITECTURAL LOUVER WALL

WT19 ALUMINUM PANEL
INSULATING WALL

WT20 BRICK VENEER WALL - TOWERS

WT21 ALUMINUM AND GLASS
CURTAINWALL SYSTEM -
TOWER CORE

WT22 ALUMINUM AND GLASS
CURTAINWALL SYSTEM -
TYPICAL WINDOWS

WT23 MECHANICAL BRICK SCREENWALL

WT24 MECHANICAL RENTHOUSE
INSULATING WALL

GR1 ALUMINUM AND GLASS GUARDRAIL

GR2 STAINLESS STEEL GUARDRAIL

CY1 ALUMINUM PLATE ENTRY CANOPY

1 BUILDING ELEVATION - NORTH ORTHOGONAL

SCALE: 3/32" = 1'-0"

A101

2 BLDG ELEV - ATH RECESS LOOKING WEST

SCALE: 3/32" = 1'-0"

A210

1 BUILDING ELEVATION - NORTH HIDDEN @ LEVEL 17 ROOF

SCALE: 3/32" = 1'-0"

A108

3 BUILDING ELEVATION - NORTH HIDDEN @ LEVEL 6 ROOF


SCALE: 3/32" = 1'-0"


A106

2 BLDG ELEV - ATH RECESS LOOKING WEST

SCALE: 3/32" = 1'-0"


A210

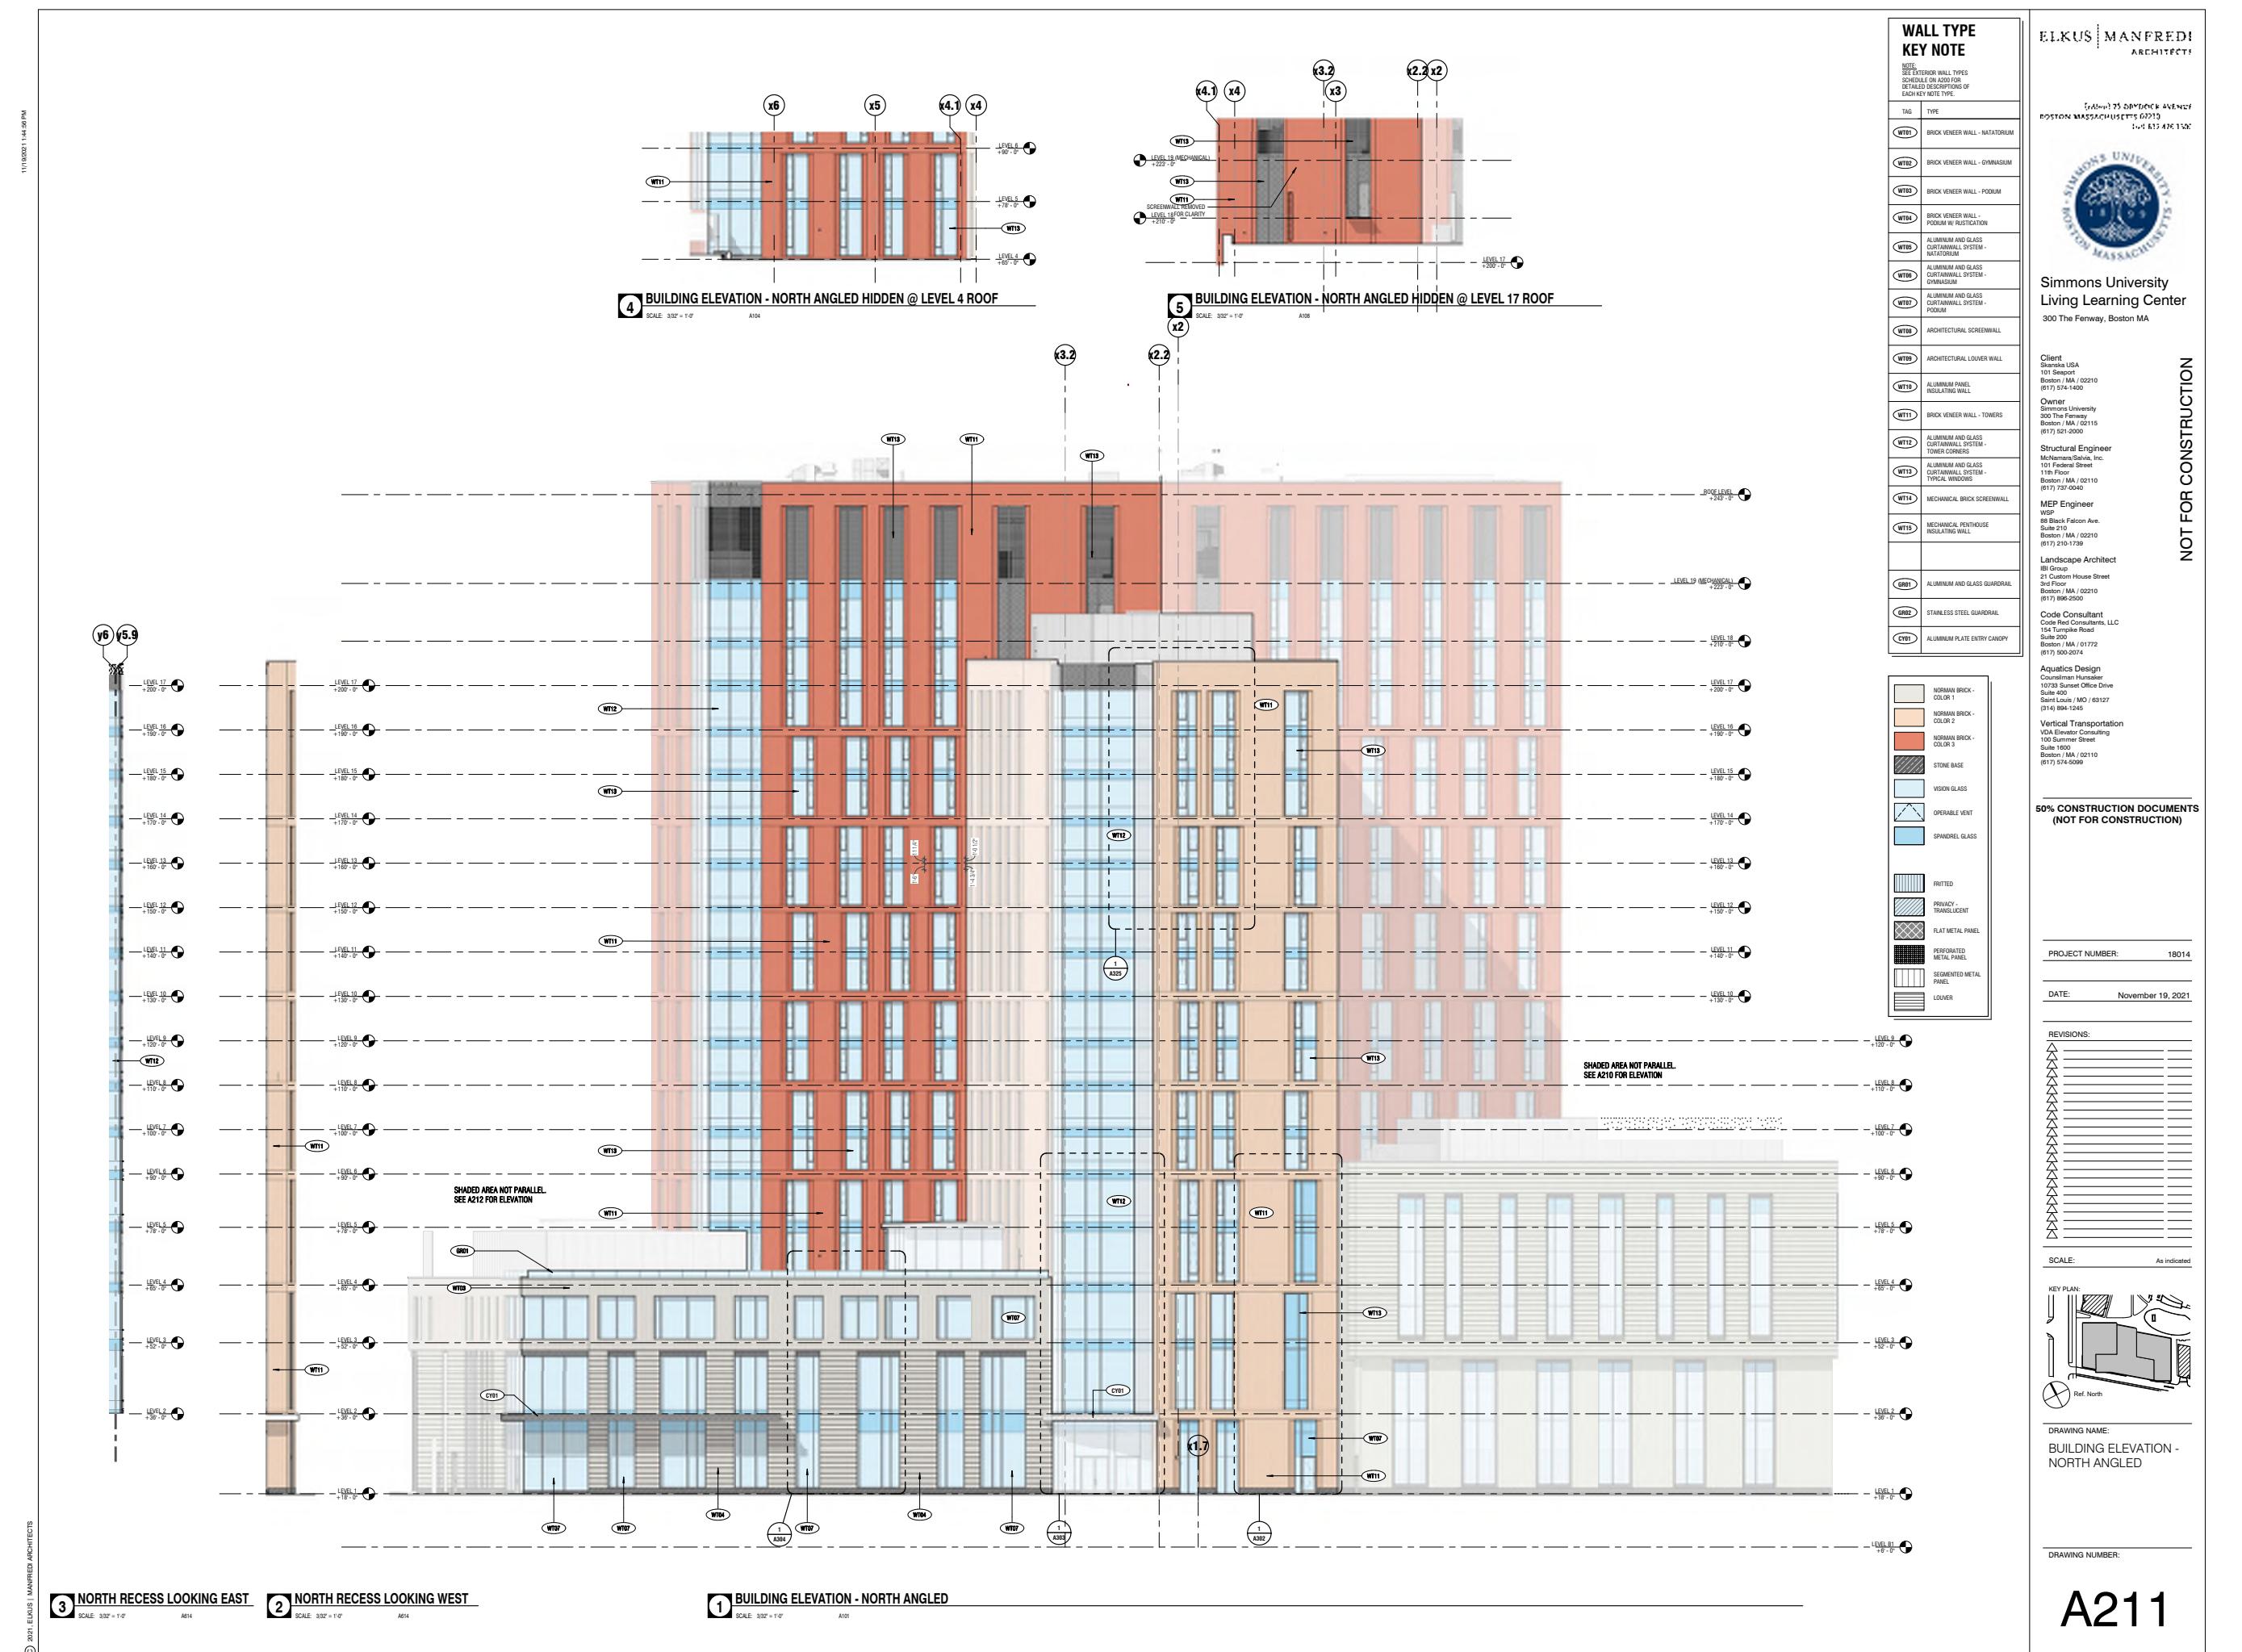

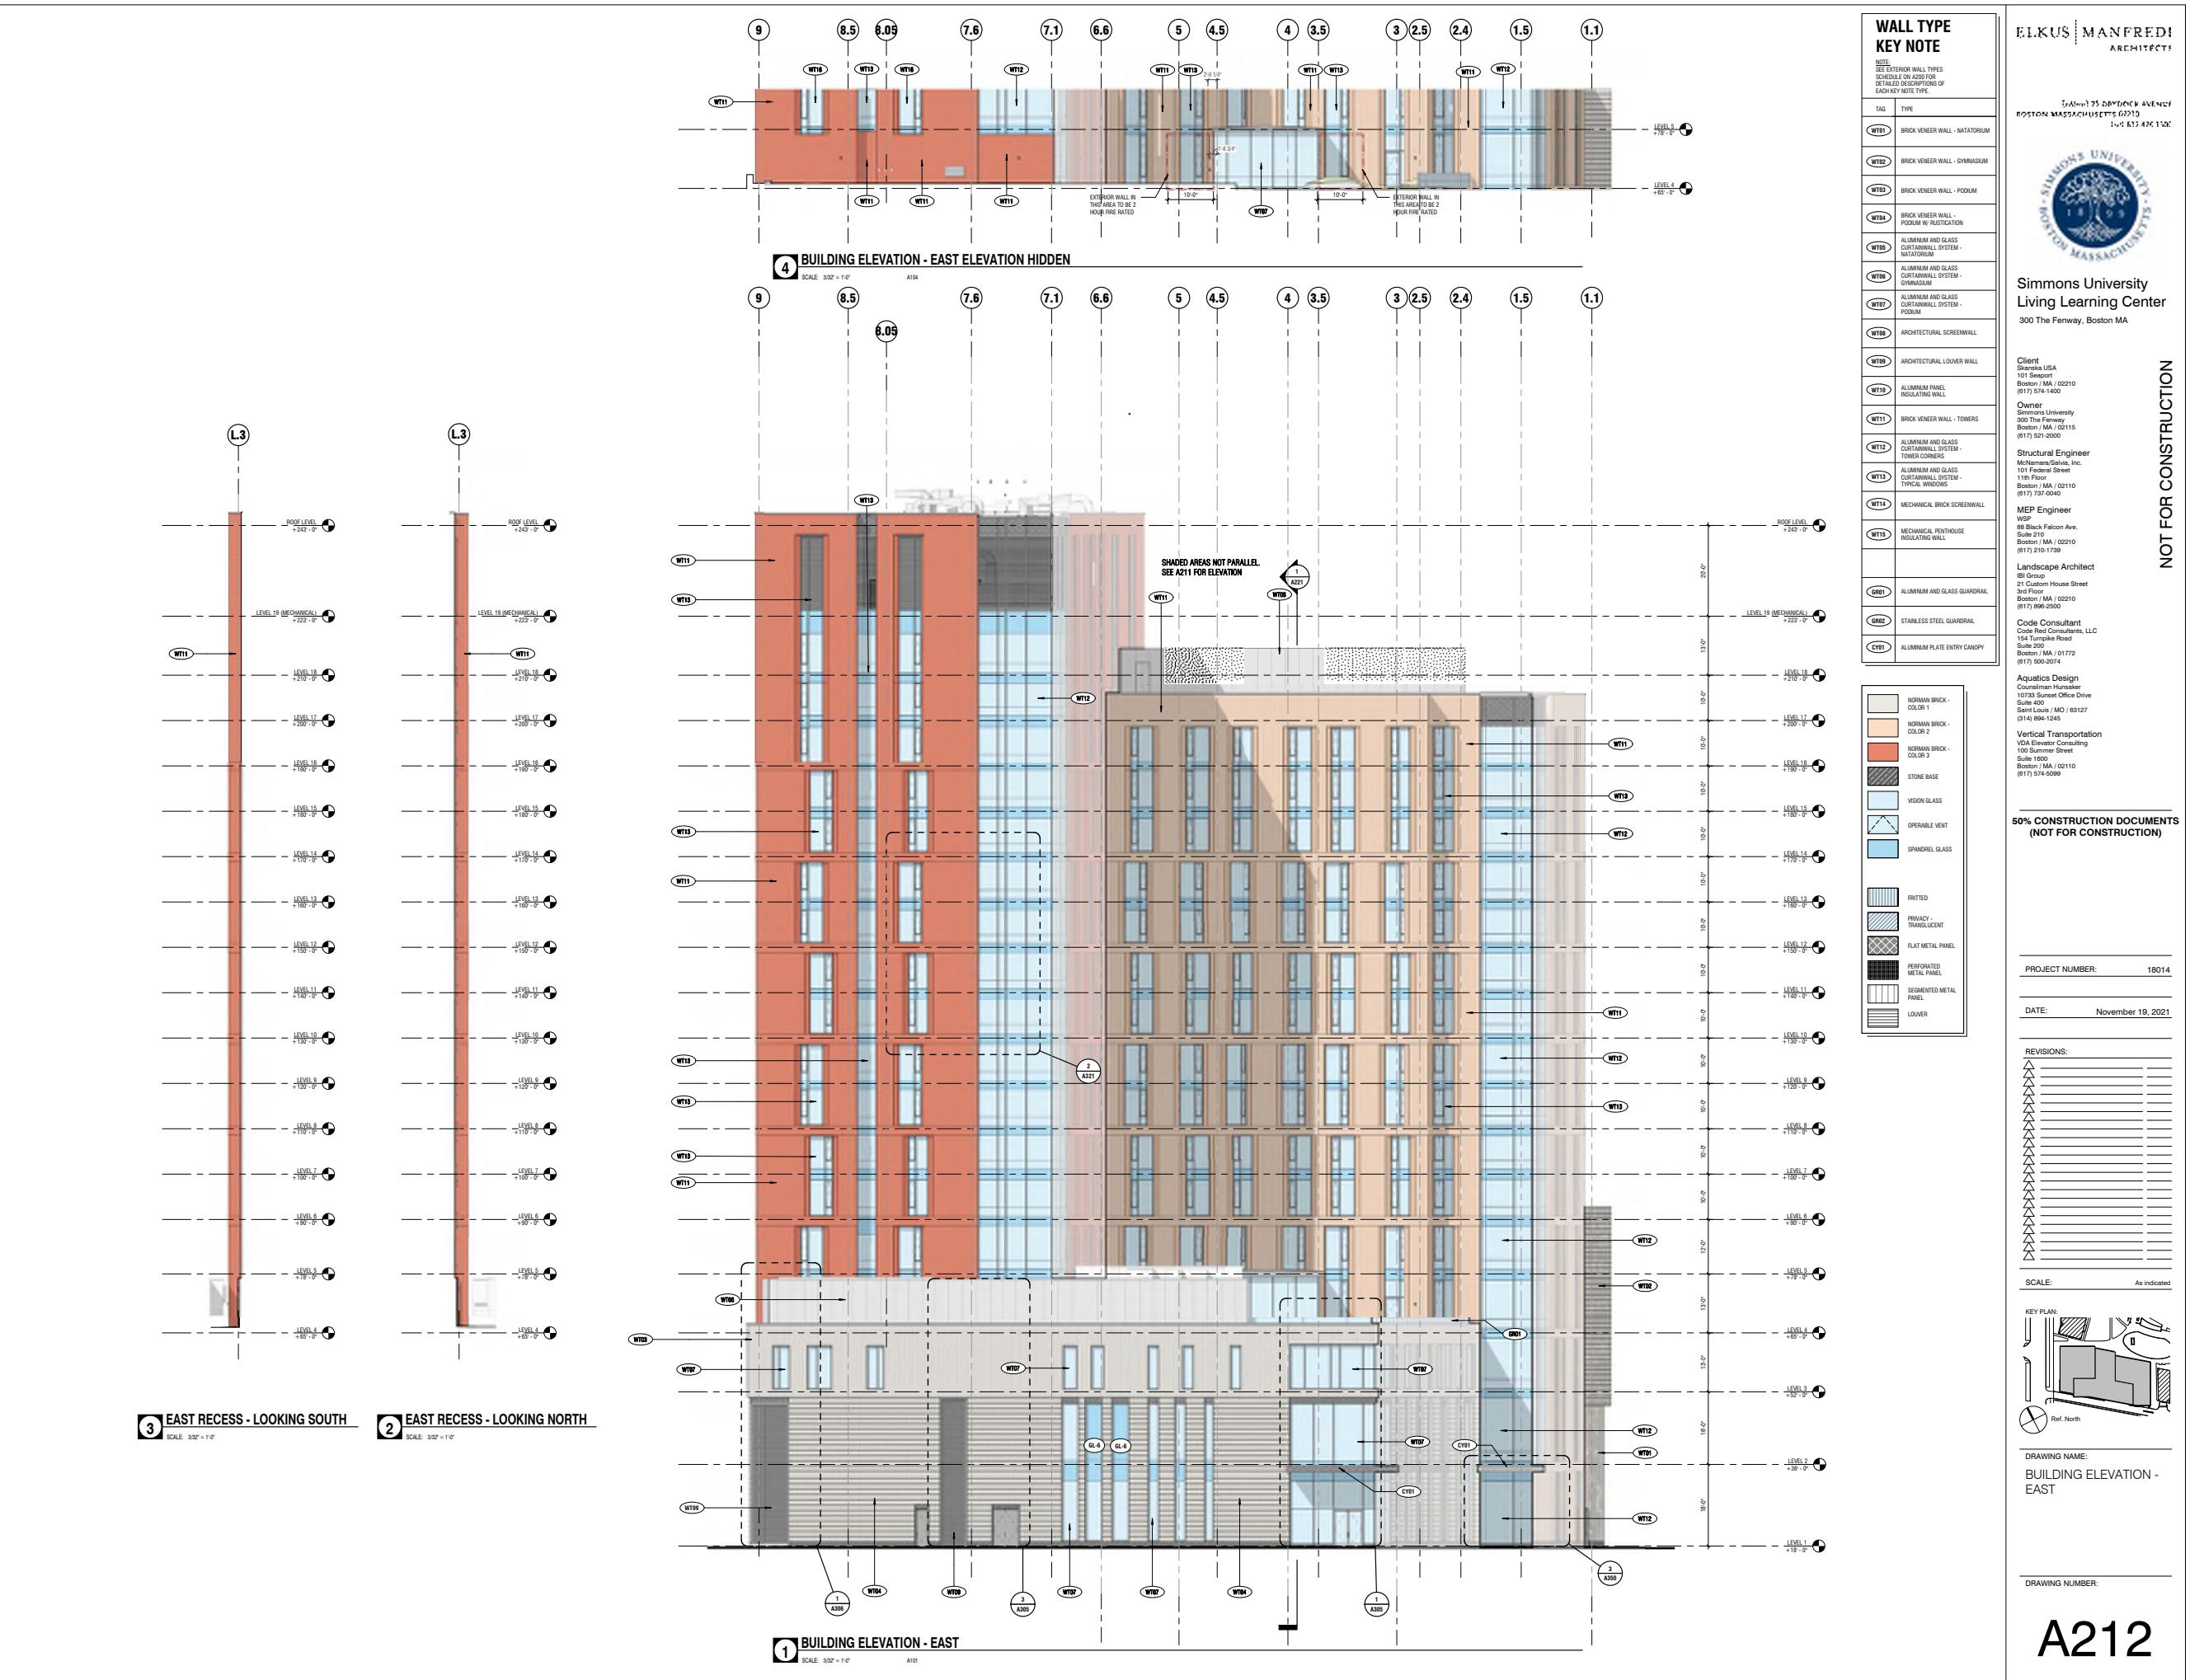

1 BUILDING ELEVATION - SOUTH ORTHOGONAL

A101

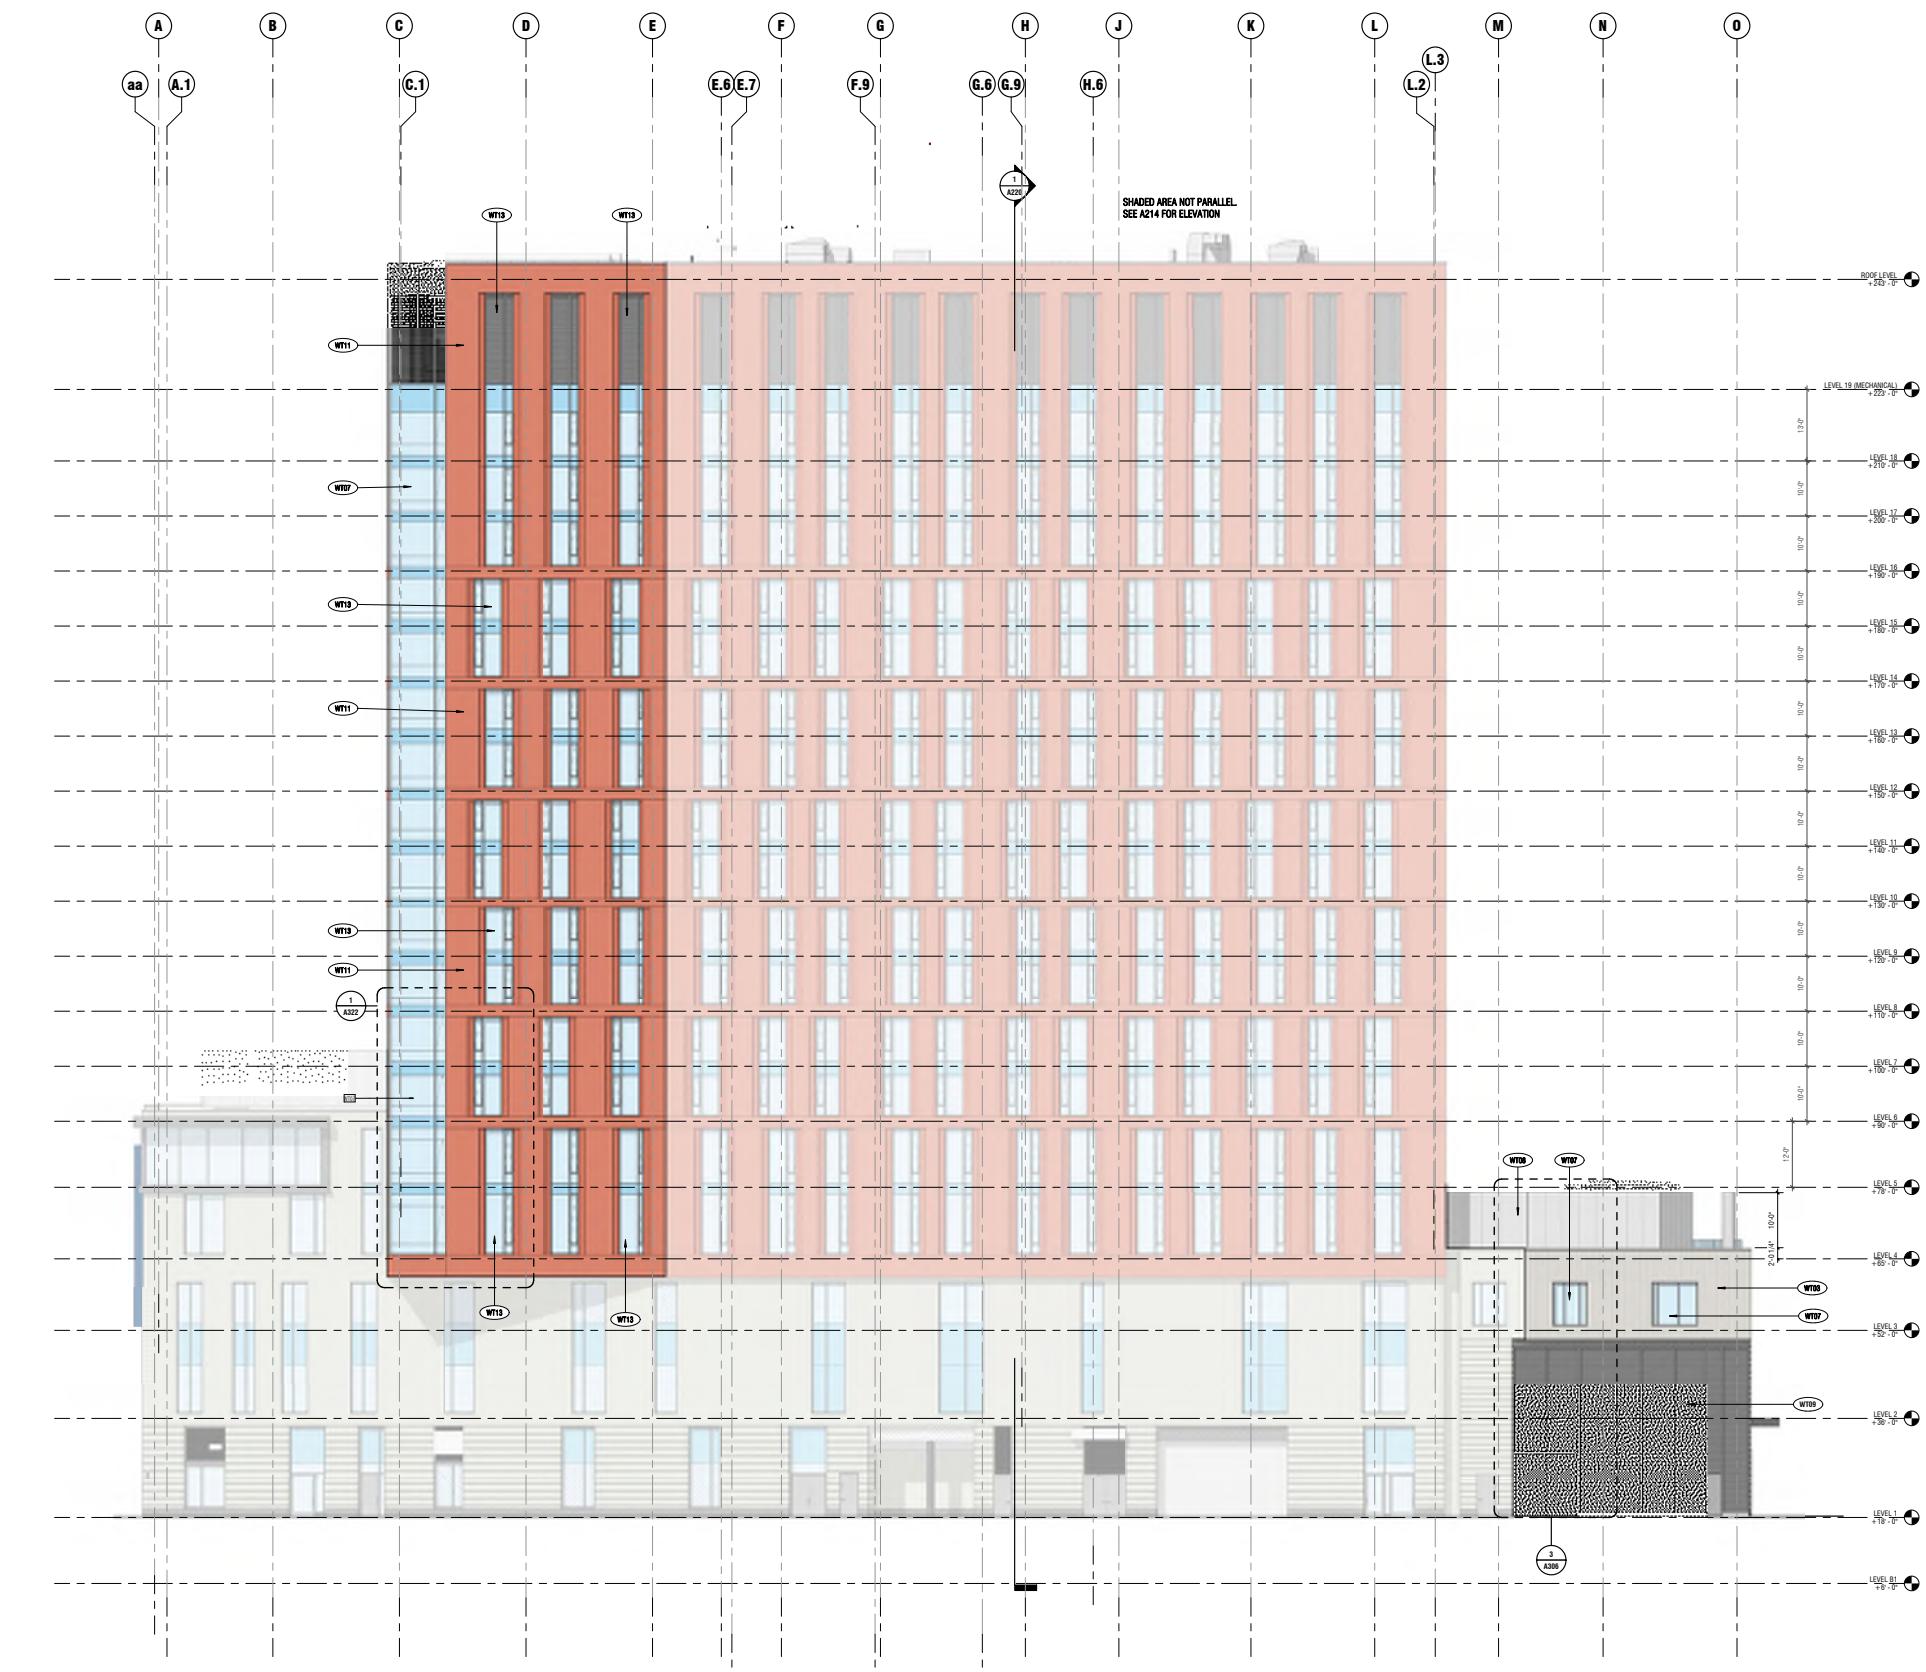

WALL TYPE KEY NOTE	
NOTE: EXTERIOR WALL TYPES SCHEDULED ON A200 PAGE 29	
TAG	TYPE
W101	BRICK VENEER WALL - NATATORIUM
W102	BRICK VENEER WALL - GYMNASIUM
W103	BRICK VENEER WALL - PODIUM
W104	BRICK VENEER WALL PODIUM W/ RUSTICATION
W105	ALUMINUM AND GLASS CURTAINWALL SYSTEM - NATATORIUM
W106	ALUMINUM AND GLASS CURTAINWALL SYSTEM - GYMNASIUM
W107	ALUMINUM AND GLASS CURTAINWALL SYSTEM - PODIUM
W108	ARCHITECTURAL SCREENWALL
W109	ARCHITECTURAL LOUVER WALL
W110	ALUMINUM PANEL INSULATING WALL
W111	BRICK VENEER WALL - TOWERS
W112	ALUMINUM AND GLASS CURTAINWALL SYSTEM - TOWER CONCERN
W113	ALUMINUM AND GLASS CURTAINWALL SYSTEM - TYPICAL WINDOWS
W114	MECHANICAL BRICK SCREENWALL
W115	MECHANICAL PENTHOUSE INSULATING WALL
GRT1	ALUMINUM AND GLASS GUARDRAIL
GRT2	STAINLESS STEEL GUARDRAIL
CVR1	ALUMINUM PLATE ENTRY CANOPY

Simmons University
Living Learning Center
300 The Fenway, Boston MA

Client:
Stiles USA
101 Seaport
Boston, MA / 02210
(617) 574-1450

Owner:
Simmons University
300 The Fenway
Boston / MA / 02215
(617) 521-2000

Structural Engineer:
McNamaraSalvia, Inc.
101 Federal Street
11th Floor
Boston / MA / 02110
(617) 737-0540

MEP Engineer:
WSA
88 Black Falcon Ave.
Suite 210
Boston, MA / 02210
(617) 571-1729

Landscape Architect:
BB Group
21 Custom House Street
3rd Floor
Boston, MA / 02210
(617) 986-2500

Code Consultant:
Code Red Consultants, LLC
140 Brattle Street
Suite 200
Boston / MA / 01772
(617) 500-2074

Aquatics Design:
Compton Associates
10003 Sunset Office Drive
Suite 400
Santa Clarita, CA / 91312
(314) 894-1245

Vertical Transportation:
VDA Elevator Consulting
100 Summer Street
Suite 200
Boston / MA / 02110
(617) 574-5099


50% CONSTRUCTION DOCUMENTS
(NOT FOR CONSTRUCTION)

PROJECT NUMBER: 18014

DATE: November 19, 2021

REVISIONS:

SCALE: As indicated

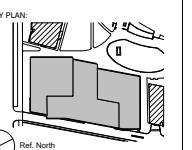

DRAWING NAME:
BUILDING ELEVATION -
SOUTH ORTHOGONAL

DRAWING NUMBER:

A213



Simmons University
Living Learning Center
300 The Fenway, Boston MA

Client:
Skanska USA
Boston, MA / 02210
(617) 574-1450

Owner:
Simmons University
300 The Fenway
Boston, MA / 02115
(617) 521-2000

Structural Engineer:
McNamara Salvia, Inc.
11 New Street
Boston, MA / 02110
(617) 737-0540

MEP Engineer:
WSA
88 Black Falcon Ave.
Suite 210
Boston, MA / 02210
(617) 570-1729

Landscape Architect:
BB Group
21 Custom House Street
3rd Floor
Boston, MA / 02210
(617) 986-2500

Code Consultant:
Code Red Consultants, LLC
140 Brattle Street
Suite 200
Boston, MA / 01772
(617) 500-2074

Aquatics Design:
Comerford Associates
10003 Sunstar Office Drive
Suite 400
Salisbury, MD / 21372
(314) 894-1245

Vertical Transportation:
VDA Elevator Consulting
100 Summer Street
Suite 200
Boston, MA / 02110
(617) 574-5099


**50% CONSTRUCTION DOCUMENTS
(NOT FOR CONSTRUCTION)**

PROJECT NUMBER: 18014

DATE: November 19, 2021

REVISIONS:

SCALE: As indicated

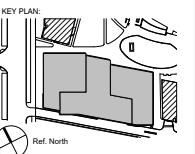


DRAWING NAME:
BUILDING ELEVATION -
SOUTH ANGLED

DRAWING NUMBER:

A214

WALL TYPE KEY NOTE	
NOTE: THIS DRAWING SHOWS THE WALL TYPES SCHEDULED ON A200. SEE DETAILED DESCRIPTIONS OF EACH KEY NOTE TYPE.	
TAG	TYPE
WT1	BRICK VENEER WALL - NATATORIUM
WT2	BRICK VENEER WALL - GYMNASIUM
WT3	BRICK VENEER WALL - PODIUM
WT4	BRICK VENEER WALL - PODIUM W/ RUSTICATION
WT5	ALUMINUM AND GLASS CURTAINWALL SYSTEM - NATATORIUM
WT6	ALUMINUM AND GLASS CURTAINWALL SYSTEM - GYMNASIUM
WT7	ALUMINUM AND GLASS CURTAINWALL SYSTEM - PODIUM
WT8	ARCHITECTURAL SCREENWALL
WT9	ARCHITECTURAL LOUVER WALL
WT10	ALUMINUM PANEL INSULATING WALL
WT11	BRICK VENEER WALL - TOWERS
WT12	ALUMINUM AND GLASS CURTAINWALL SYSTEM - TOWER CONC.
WT13	ALUMINUM AND GLASS CURTAINWALL SYSTEM - TYPICAL WINDOWS
WT14	MECHANICAL BRICK SCREENWALL
WT15	MECHANICAL RENTHOUSE INSULATING WALL
GR1	ALUMINUM AND GLASS GUARDRAIL
GR2	STAINLESS STEEL GUARDRAIL
CVR	ALUMINUM PLATE ENTRY CANOPY



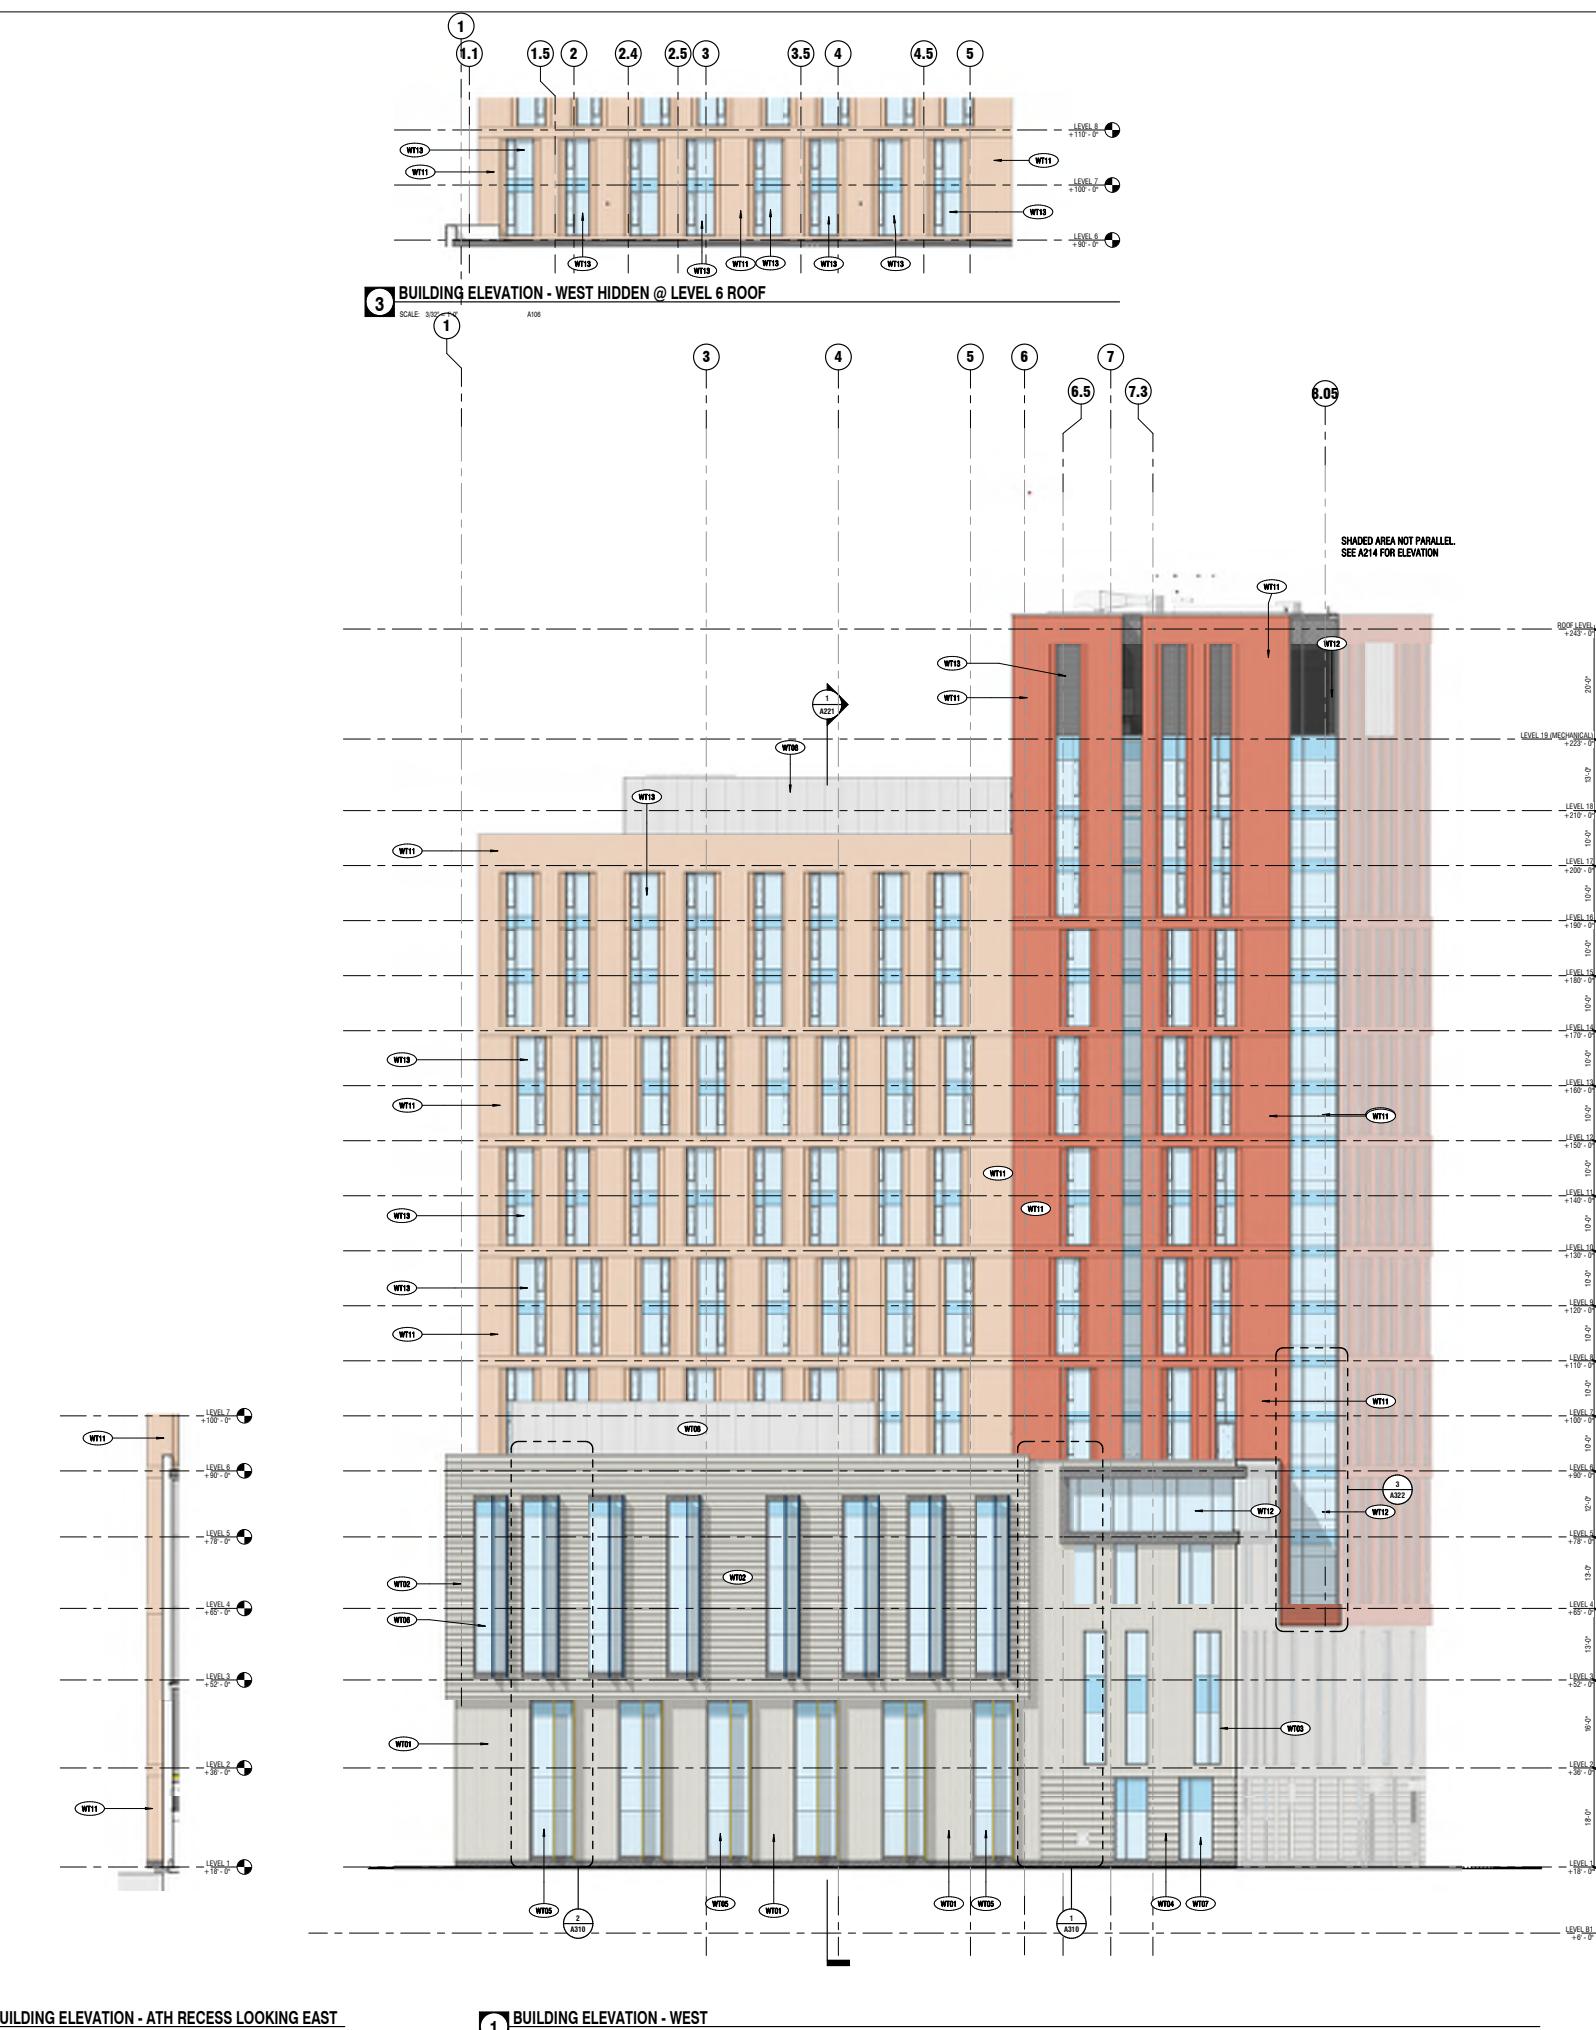

WALL TYPE KEY NOTE	
NOTE: REFER TO WALL TYPES SCHEDULE ON AC000 FOR DETAILED DESCRIPTIONS OF EACH KEY NOTE TYPE.	
TAG	TYPE
WT1	BRICK VENEER WALL - NATATORIUM
WT2	BRICK VENEER WALL - GYMNASIUM
WT3	BRICK VENEER WALL - PODIUM
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WT7	ALUMINUM AND GLASS CURTAINWALL SYSTEM - PODIUM
WT8	ARCHITECTURAL SCREENWALL
WT9	ARCHITECTURAL LOUVER WALL
WT10	ALUMINUM PANEL INSULATING WALL
WT11	BRICK VENEER WALL - TOWERS
WT12	ALUMINUM AND GLASS CURTAINWALL SYSTEM - TOWERS
WT13	ALUMINUM AND GLASS CURTAINWALL SYSTEM - TYPICAL WINDOWS
WT14	MECHANICAL BRICK SCREENWALL
WT15	MECHANICAL PENTHOUSE INSULATING WALL
GR1	ALUMINUM AND GLASS GUARDRAIL
GR2	STAINLESS STEEL GUARDRAIL
CPY1	ALUMINUM PLATE ENTRY CANOPY

ELKUS | MANFREDI
ARCHITECTS
111 Newbury Street, Suite 1000
Boston, Massachusetts 02116
(617) 521-1500

Simmons University
Living Learning Center
300 The Fenway, Boston MA

Client:
Stevens USA
101 Seaport
Boston, MA / 02210
(617) 524-1450

Owner:
Simmons University
300 The Fenway
Boston, MA / 02115
(617) 521-2000

Structural Engineer:
McNamaraSalvia, Inc.
118 Federal Street
Boston, MA / 02110
(617) 737-0540

MEP Engineer:
WSA
88 Black Falcon Ave.
Suite 210
Boston, MA / 02210
(617) 510-1239

Landscape Architect:
GB Group
21 Custom House Street
3rd Floor
Boston, MA / 02210
(617) 886-2500

Code Consultant:
Code Red Consultants, LLC
140 Brattle Street
Suite 200
Boston, MA / 01772
(617) 500-2074

Aquatics Design:
Cornerstone Aquatics
1000 Summer Office Drive
Suite 400
Salisbury, MD / 21372
(314) 884-1245

Vertical Transportation:
VDA Elevator Consulting
100 Summer Street
Suite 200
Boston, MA / 02110
(617) 574-5099


50% CONSTRUCTION DOCUMENTS (NOT FOR CONSTRUCTION)

PROJECT NUMBER: 18014

DATE: November 19, 2021

REVISIONS:

SCALE: As indicated

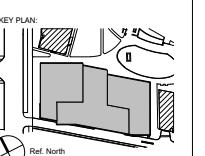

DRAWING NAME:
BUILDING ELEVATION - WEST

DRAWING NUMBER:

A215

NOT FOR CONSTRUCTION

COMMONWEALTH OF MASSACHUSETTS
CITY OF BOSTON
OFFICE OF THE COLLECTOR-TREASURER
ONE CITY HALL SQUARE, BOSTON, MA 02201

COLLECTOR OF TAXES
Justin Sterritt



This form approved by Commissioner of Revenue

SIMMONS UNIVERSITY
300 FENWAY STREET
BOSTON MA 02115

FY 2022
CITY OF BOSTON
PRELIMINARY REAL ESTATE TAX

Office of the Assessor 617-635-4287

Office of the Collector 617-635-4131

Office Hours: Monday - Friday 9:00 AM - 5:00 PM

PAYMENTS CAN BE MADE ONLINE AT:

www.boston.gov/taxpayments

PAYMENTS CAN BE MADE BY PHONE AT

(855) 731-9898

credit/debit card payments are subject to fees

If you are using a payment service to pay this bill, you
MUST indicate the TAXYEAR and BILL NUMBER on the check

MAKE CHECKS PAYABLE TO:
THE CITY OF BOSTON

SEE REVERSE SIDE FOR IMPORTANT INFORMATION

TAXPAYER'S COPY

MAIL CHECKS TO:
BOX 55808
BOSTON, MA 02205

Do not send cash

WARD	PARCEL NO.	BILL NUMBER	BANK NO.
04	01842-001	148283	
LOCATION			
300 FENWAY ST			
ASSESSED OWNER			
SIMMONS UNIVERSITY			

PRELIMINARY REAL ESTATE TAX	22,470.62
COMMUNITY PRESERVATION ACT	212.43
TOTAL PRELIMINARY TAX	22,683.05
1ST TAX PAYMENT DUE BY 08/02/2021	11,341.53
2ND TAX PAYMENT DUE BY 11/01/2021	11,341.52
PAYMENTS TO DATE/CREDITS	11,341.53
TAX DUE	11,341.52
FEES	.00
INTEREST	.00
TOTAL DUE →	11,341.52
Pay by 11/01/2021	

Please detach this portion and remit this slip with payment.

COMMONWEALTH OF MASSACHUSETTS
CITY OF BOSTON

This form approved by Commissioner of Revenue

WARD	PARCEL NO.	BILL NUMBER	BANK NO.
04	01842-001	148283	
LOCATION			
300 FENWAY ST			

COLLECTOR OF TAXES
Justin Sterritt

ASSESSED OWNER: SIMMONS UNIVERSITY

SIMMONS UNIVERSITY
300 FENWAY STREET
BOSTON MA 02115

COLLECTOR'S COPY

2022 PRELIMINARY
REAL ESTATE TAX
2ND QUARTER

MAKE CHECKS PAYABLE TO:
THE CITY OF BOSTON

MAIL CHECKS TO:
BOX 55808
BOSTON, MA 02205

Do not send cash

TAX DUE	11,341.52
FEES	.00
INTEREST	.00
TOTAL DUE →	11,341.52
Pay by 11/01/2021	

00182082022200148283500011341526

Assessing On-Line

[« New search](#)
[Map](#)

Parcel ID:	0401842001
Address:	300 FENWAY ST BOSTON MA 02115
Property Type:	Commercial
Classification Code:	0320 (Commercial Property / RET/WHSL/SERVICE)
Lot Size:	0 sq ft
Living Area:	1 sq ft
Year Built:	-
Owner on Friday, January 1, 2021:	SIMMONS UNIVERSITY
Owner's Mailing Address:	300 FENWAY STREET BOSTON MA 02115
Residential Exemption:	No
Personal Exemption:	No

Value/Tax

Assessment as of Friday, January 1, 2021,
statutory lien date.

FY2022 Building value:	\$1,885,300.00
FY2022 Land Value:	\$0.00
FY2022 Total Assessed Value:	\$1,885,300.00

FY2022 Tax Rates (per thousand):

- Residential:	\$10.88
- Commercial:	\$24.98

FY2022 Gross Tax: \$47,094.79

Community Preservation:	\$445.97
- Residential Exemption:	\$0.00
- Personal Exemption:	\$0.00
+ 38D Penalty:	\$250.00
FY2022 Net Tax:	\$47,540.76

Abatements/Exemptions

To file an Abatement Application for FY2022
[click here](#). The deadline for submission is
 Tuesday, February 1, 2022.

This type of parcel is not eligible for a
 residential or personal exemption.

Current Owner

1 SIMMONS UNIVERSITY

Owner information may not reflect any changes
 submitted to City of Boston Assessing after
 December 28, 2021.

Value History

Fiscal Year	Property Type	Assessed Value *
2022	Commercial	\$1,885,300.00
2021	Commercial	\$1,830,600.00
2020	Commercial	\$1,618,500.00
2019	Commercial	\$1,583,000.00
2018	Commercial	\$1,532,500.00
2017	Commercial	\$1,445,000.00
2016	Commercial	\$1,262,500.00
2015	Commercial	\$920,000.00
2014	Commercial	\$865,000.00
2013	Commercial	\$812,500.00
2012	Commercial	\$778,500.00
2011	Commercial	\$712,000.00
2010	Commercial	\$724,500.00
2009	Commercial	\$757,000.00
2008	Commercial	\$712,000.00
2007	Commercial	\$693,500.00
2006	Commercial	\$598,000.00
2005	Four to Six Family	\$574,500.00

* Actual Billed Assessments

[View Quarterly Tax Bill and Payment Information](#) for this parcel for FY2021 and FY2022.

[View approved building permits](#) associated with this parcel.

Questions? For CURRENT fiscal year tax bill Questions, contact the [Taxpayer Referral & Assistance Center](#).
 For PRIOR fiscal year tax payments, interest charges, fees, etc. contact the Collector's office at 617-635-4131.

Boston Tax Parcel Viewer

2021 Tax Parcel Information

Built by the Analytics Team

X Q

Show search results for 300 fenway...

Select

+ -

Emmanuel-Cardinal Cushing Library

Legend

Parcels 2021

Show search results for 300 fenway...

Select



(1 of 2)

Boston Parcels 2021

Parcel ID: 0401842001
Address: 300 FENWAY ST, BOSTON,
02115
Owner: SIMMONS UNIVERSITY

Land Use: C
Lot Size: SQ FT
Living Area: 1 SQ FT
Building Value: \$1,830,600
Land Value: \$1,830,600
Total Value: \$44,941
Gross Tax: \$44,941

For additional information from the Assessing Department, [click here](#).

Zoom to

Emmanuel-Alumnae Hall

200ft
-71.100 42.339 Degrees