COMMONWEALTH OF MASSACHUSETTS DEPARTMENT OF CONSERVATION AND RECREATION DIVISION OF PLANNING


CHARLESGATE PARK WALL REMOVAL IN THE CITY OF BOSTON MASSACHUSETTS SUFFOLK COUNTY

DCR CONTRACT NO. P21-3434-C1A

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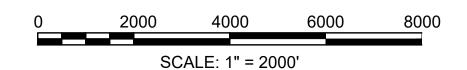
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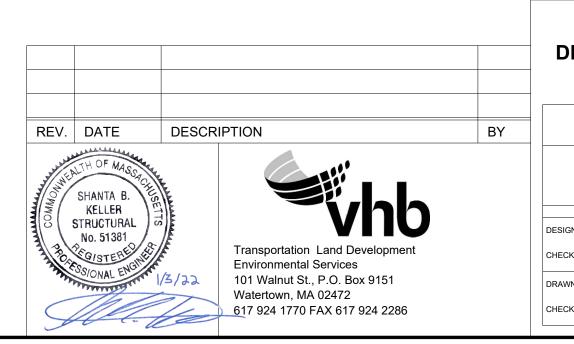


CHARLES D. BAKER, GOVERNOR KARYN E. POLITO, LT. GOVERNOR

KATHLEEN A. THEOHARIDES, SECRETARY, EXECUTIVE OFFICE OF ENERGY & ENVIRONMENTAL AFFAIRS

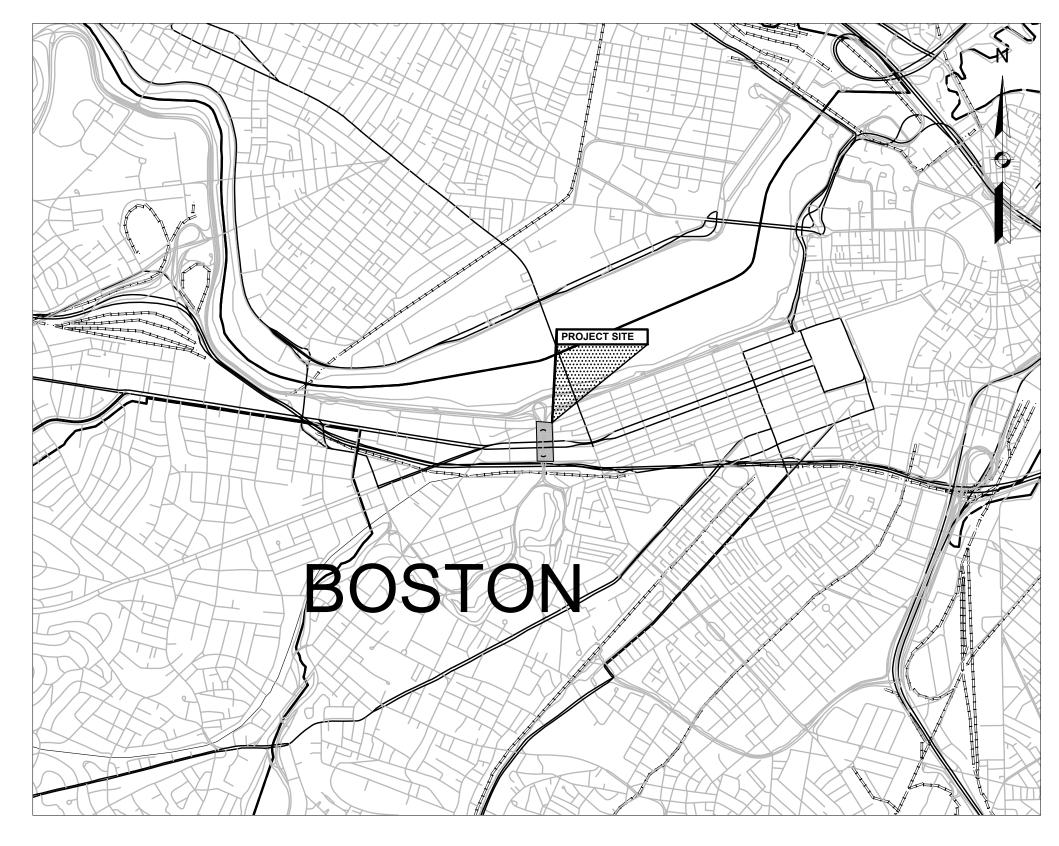JIM MONTGOMERY, ACTING AND INTERIM COMMISSIONER DEPARTMENT OF CONSERVATION & RECREATION





COMMONWEALTH OF MASSACHUSETTS
DEPARTMENT OF CONSERVATION AND RECREATION
DIVISION OF PLANNING AND ENGINEERING

	CHARLESGATE PARK WALL REMOVAL			
	CHARLESGATE PARK BOSTON, MA DESIGNER:BDF CHECKED: SBK			
				SHEET NO.
	DRAWN: BDF	S-01		

DATE: 1/3/2022 | 01 OF 16

15356.00 - TITLE.DWG Plotte

ABBREVIATIONS (cont.)

ANNUAL AVERAGE DAILY TRAFFIC

ASPHALT COATED CORRUGATED METAL PIPE

ABANDON

APPROXIMATE

BITUMINOUS

BOTTOM OF CURB

BOTTOM OF SLOPE

CEMENT CONCRETE

CATCH BASIN WITH CURB INLET

CEMENT CONCRETE MASONRY

ASPHALT CONCRETE

ADJUST

BOUND

BASELINE

BUILDING

BENCHMARK

CATCH BASIN

BY OTHERS

BRIDGE

CEMENT

COUNTY

CONCRETE

CONTINUOUS

CONSTRUCTION

CROWN GRADE

DUCTILE IRON PIPE

EDGE OF PAVEMENT

FRAME AND COVER

FRAME AND GRATE

DROP INLET

DIAMETER

DRIVEWAY

EMBANKMENT

EXCAVATION

FOUNDATION

FIELDSTONE

GARAGE

GROUND

GRANITE

GRAVEL

GUARD

HEADWALL

HORIZONTAL

HYDRANT

JUNCTION

LEACH BASIN LIGHT POLE

INVERT

LEFT

MAXIMUM

MAILBOX

MANHOLE

MINIMUM

NUMBER

PROJECT

PVI

PVT

PVMT

PROPOSED

PAVEMENT

HOT MIX ASPHALT

LENGTH OF CURVE

LANDSCAPE TIMBER

NOT IN CONTRACT

POINT OF CURVATURE

PROFILE GRADE LINE

POINT ON CURVE

POINT ON TANGENT

POINT OF INTERSECTION

PLANTABLE SOIL BORROW

POINT OF TANGENCY

MASSACHUSETTS HIGHWAY BOUND

POINT OF COMPOUND CURVATURE

POINT OF REVERSE CURVATURE

POINT OF VERTICAL CURVATURE

POINT OF VERTICAL TANGENCY

POINT OF VERTICAL INTERSECTION

GAS GATE

GUTTER INLET

GALVANIZED IRON PIPE

CURB INLET

CENTERLINE

CAST IRON PIPE

CHAIN LINK FENCE

CORRUGATED METAL PIPE

CORRUGATED STEEL PIPE

DESIGN HOURLY VOLUME

STEADY DON'T WALK - PORTLAND ORANGE

GENERAL	
PWW	PAVED WATER WAY
R	RADIUS OF CURVATURE
R&D	REMOVE AND DISPOSE
RCP	REINFORCED CONCRETE PIP
RD	ROAD

RDWY ROADWAY REM **REMOVE** RET RETAIN **RET WALL**

RETAINING WALL ROW **RIGHT OF WAY** RR RAILROAD R&R REMOVE AND RESET R&S REMOVE AND STACK

RIGHT SB STONE BOUND SHLD SHOULDER **SMH** SEWER MANHOLE ST STREET

STA STATION SSD STOPPING SIGHT DISTANCE SHLO STATE HIGHWAY LAYOUT LINE SW SIDEWALK

TANGENT DISTANCE OF CURVE/TRUCK % TAN **TANGENT** TEMP **TEMPORARY** TC TOP OF CURB TMA TELEPHONE MAST ARM TOS TOP OF SLOPE

TYP **TYPICAL** UP **UTILITY POLE** VAR **VARIES VERT VERTICAL** VC VERTICAL CURVE WCR WHEEL CHAIR RAMP WG WATER GATE WIP WROUGHT IRON PIPE

X-SECT **CROSS SECTION**

TRAFFIC SIGNAL

WM

DW STEADY DON'T WALK **FDW** FLASHING DON'T WALK FLASHING CIRCULAR RED FLASHING CIRCULAR YELLOW STEADY CIRCULAR GREEN STEADY GREEN LEFT ARROW STEADY GREEN RIGHT ARROW OVERLAP

WATER METER/WATER MAIN

PEDESTRIAN STEADY CIRCULAR RED STEADY WALK STEADY CIRCULAR YELLOW

PAVEMENT MARKINGS SYMBOLS

EXISTING	PROPOSED	DESCRIPTIO
	SL	STOP LINE
	cw	CROSSWALK
	SWL	SOLID WHITE LINE
	SYL	SOLID YELLOW LINE
	BWL	BROKEN WHITE LINE
	BYL	BROKEN YELLOW LINE
	DBYL	DOUBLE YELLOW LINE

GENERAL NOTES:

- 1. THE CONTRACTOR SHALL VERIFY ALL EXISTING DIMENSIONS AND GRADES IN THE FIELD BEFORE COMMENCING WORK AND PROMPTLY NOTIFY THE ENGINEER OF ANY DISCREPANCIES.
- 2. THE LOCATIONS OF EXISTING UNDERGROUND UTILITIES ARE SHOWN IN AN APPROXIMATE WAY ONLY AND HAVE NOT BEEN INDEPENDENTLY VERIFIED BY THE OWNER OR ITS REPRESENTATIVE. THE CONTRACTOR SHALL DETERMINE THE EXACT LOCATION OF ALL EXISTING UTILITIES BEFORE COMMENCING WORK, AND SHALL BE FULLY RESPONSIBLE FOR ANY AND ALL DAMAGES WHICH MIGHT BE OCCASIONED BY THE CONTRACTOR'S FAILURE TO EXACTLY LOCATE AND PRESERVE ANY AND ALL UNDERGROUND UTILITIES.
- WHERE AN EXISTING UTILITY IS FOUND TO CONFLICT WITH THE PROPOSED WORK, THE LOCATION, ELEVATION AND SIZE OF THE UTILITY SHALL BE ACCURATELY DETERMINED WITHOUT DELAY BY THE CONTRACTOR, AND THE INFORMATION FURNISHED TO THE ENGINEER FOR RESOLUTION OF THE CONFLICT.
- 4. TREES AND SHRUBS WITHIN THE LIMITS OF GRADING SHALL BE REMOVED ONLY UPON APPROVAL OF THE ENGINEER UNLESS NOTED ON THE CONSTRUCTION DOCUMENTS.
- 5. AREAS OUTSIDE THE LIMITS OF PROPOSED WORK DISTURBED BY THE CONTRACTOR'S OPERATIONS SHALL BE RESTORED BY THE CONTRACTOR TO THEIR ORIGINAL CONDITION AT NO EXPENSE TO THE OWNER.
- 6. THE TERM "PROPOSED" (PROP) MEANS WORK TO BE CONSTRUCTED USING NEW MATERIALS OR, WHERE APPLICABLE, RE-USING EXISTING MATERIALS IDENTIFIED AS "REMOVE AND RESET" (R&R)
- 7. ALL EXISTING SIGNS WITHIN THE PROJECT LIMITS SHALL BE RETAINED UNLESS INDICATED OTHERWISE ON THE DRAWINGS.
- 8. ALL EXISTING STATE, COUNTY, CITY, AND TOWN LOCATION LINES AND PRIVATE PROPERTY LINES HAVE BEEN ESTABLISHED FROM AVAILABLE INFORMATION AND THEIR EXACT LOCATIONS ARE NOT GUARANTEED.
- 9. DISPOSAL OF ALL SURPLUS MATERIAL SHALL BE AS APPROVED BY THE ENGINEER AND OWNER.

TRAFFIC SYMBOLS


EXISTING	PROPOSED	DESCRIPTION
Ø1	Ø1	CONTROLLER PHASE
		QUADRUPOLE WIRE LOOP DETECTOR
		BICYCLE WIRE LOOP DETECTOR, TYPE B-2
\oplus	•	PEDESTRIAN PUSH BUTTON, SIGN AND SADDLE
墩	*	EMERGENCY PREEMPTION CONFIRMATION STROBE
$+\triangleright$	+>	VEHICULAR SIGNAL HEAD, WITH BACKPLATE
-		PEDESTRIAN SIGNAL HEAD
0	•	SIGNAL POST AND BASE
0	•	MAST ARM, SHAFT AND BASE
$\overline{\bigcirc}$	•	SIGN AND POST
00	••	SIGN AND POST (2 POSTS)
丁	T	OVERHEAD SIGN
	-	OPTICAL PRE-EMPTION DETECTOR
		CONTROL CABINET, GROUND MOUNTED
	•	PULL BOX 12"x12" (OR AS NOTED)
	_	ELECTRIC HANDHOLE - SD2.022 (OR AS NOTED)
	= = = = = =	TRAFFIC SIGNAL CONDUIT



Watertown, MA 02472 617 924 1770 FAX 617 924 2286

COMMONWEALTH OF MASSACHUSETTS DEPARTMENT OF CONSERVATION AND RECREATION **DIVISION OF PLANNING AND ENGINEERING**

	CHARLESGATE PARK W	/ALL REMOVAL	
	CHARLESGATE BOSTON, N		
DESIGNER:BDF CHECKED: SBK	LEGEND		SHEET NO
DRAWN: BDF	CONT. P21-3434-C1A	SCALE: AS SHOWN	S-02
CHECKED: SBK	ACC.	DATE: 1/3/2022	02 OF 16

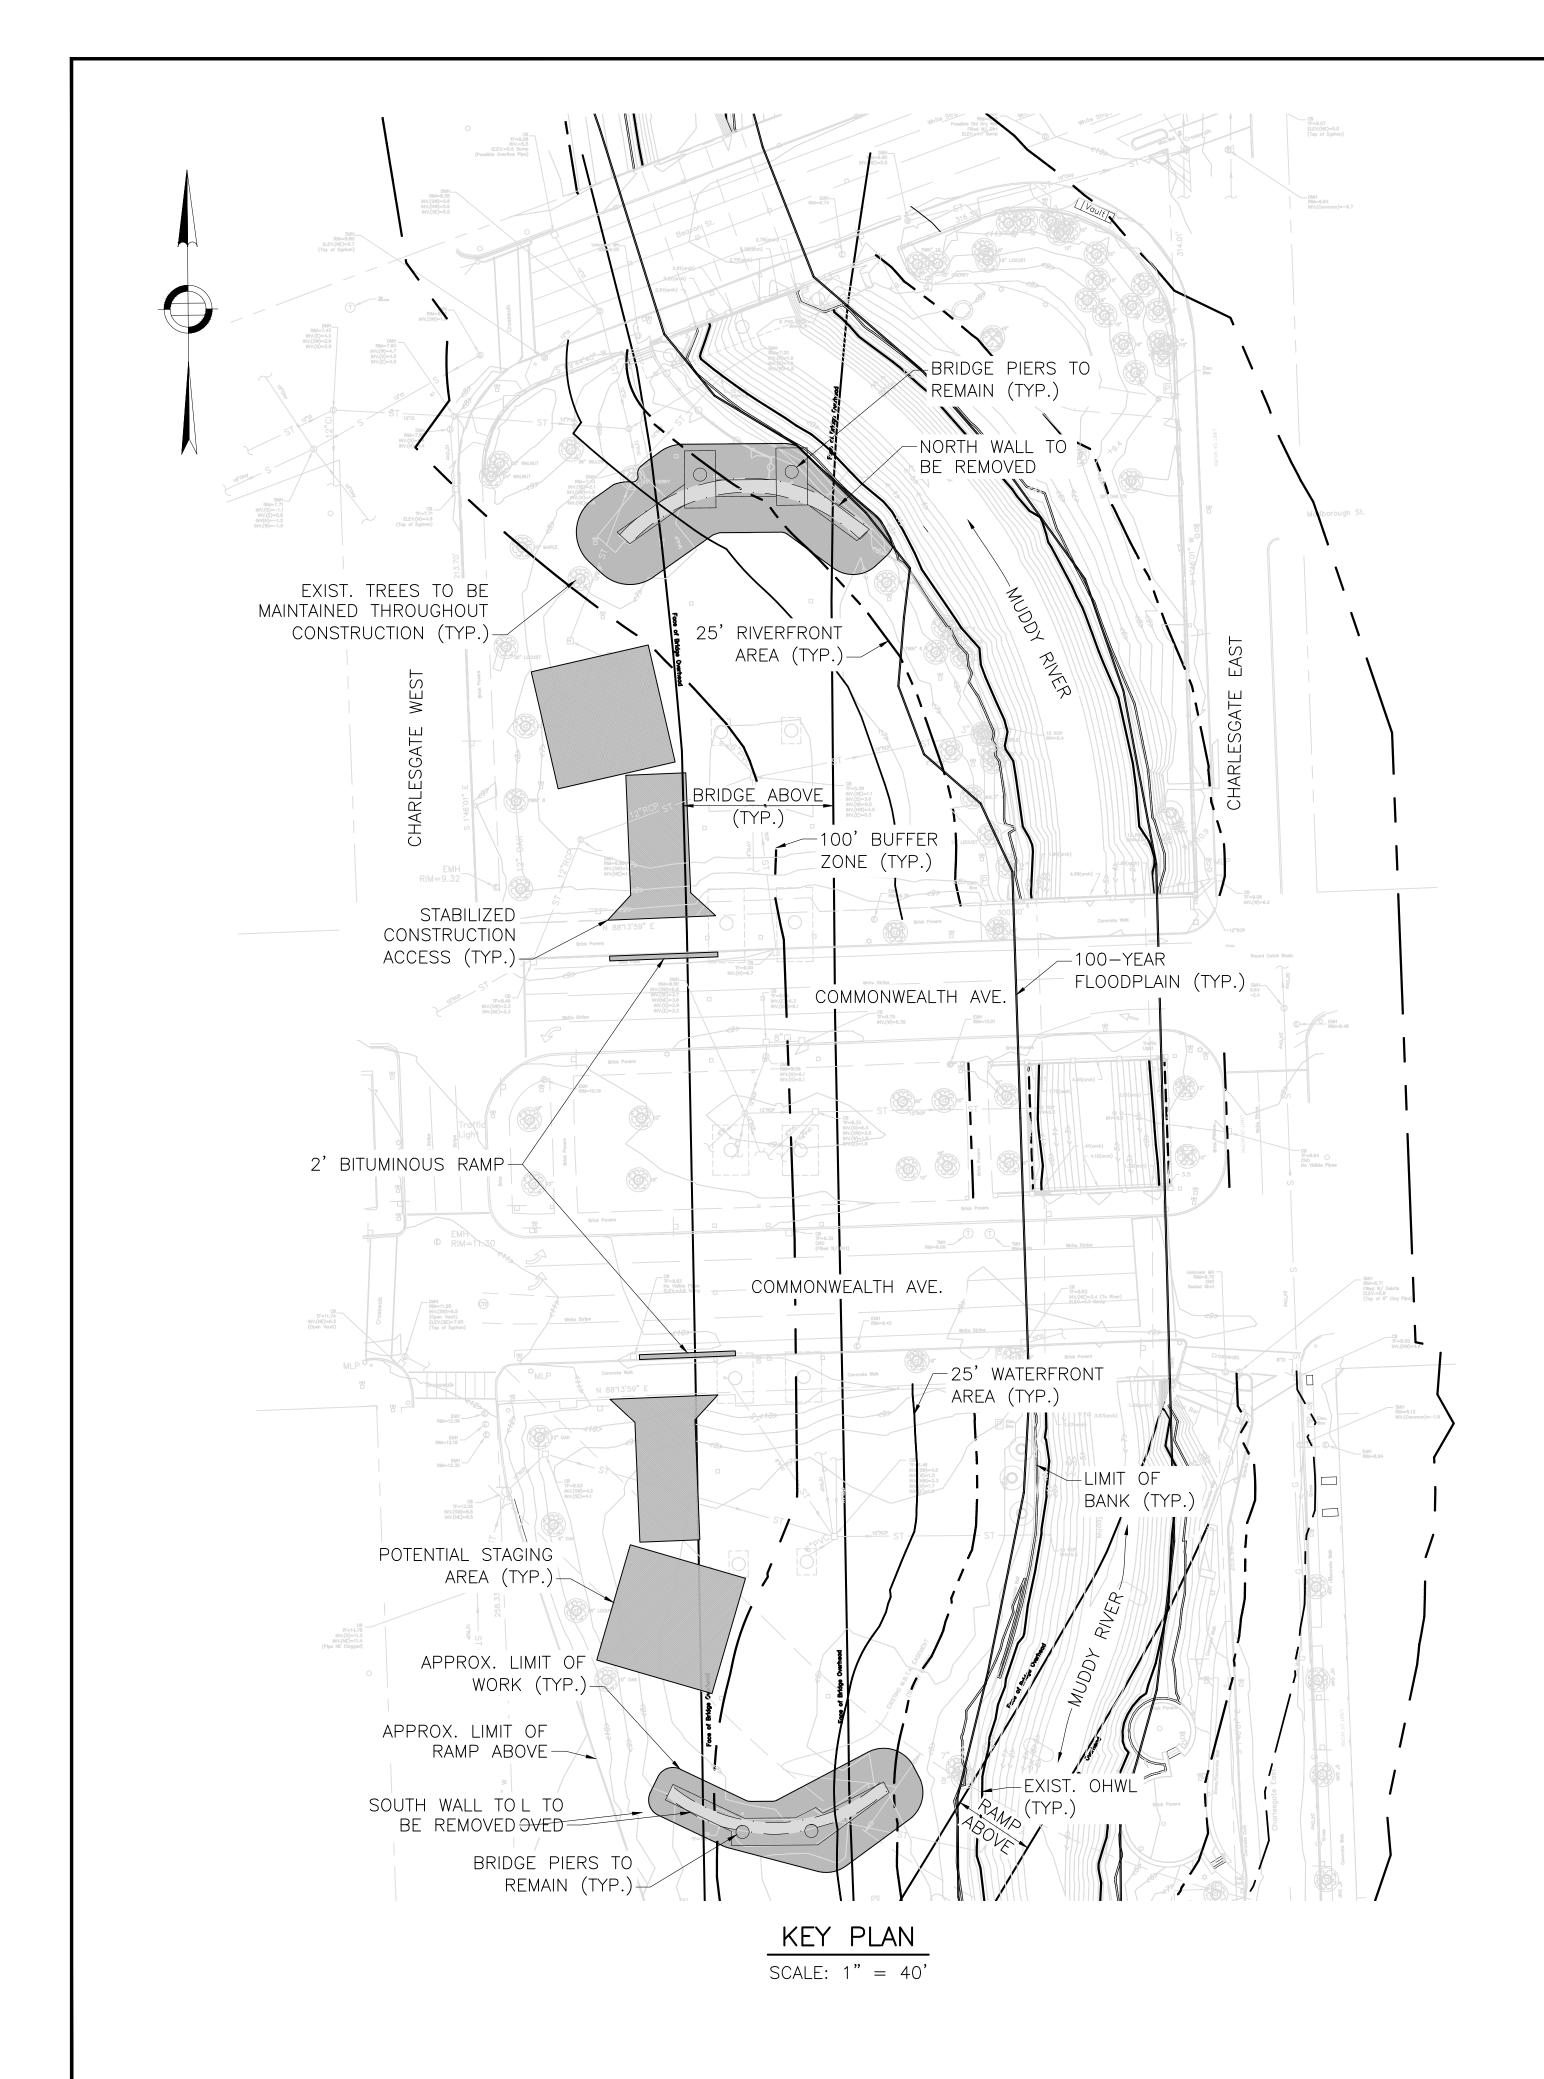

NOTES:

- 1. AREAS OUTSIDE THE LIMITS OF PROPOSED WORK DISTURBED BY THE CONTRACTOR'S OPERATIONS SHALL BE RESTORED BY THE CONTRACTOR TO THEIR ORIGINAL CONDITION AT NO EXPENSE TO THE OWNER.
- 2. PRIOR TO STARTING ANY OTHER WORK ON SITE, THE CONTRACTOR SHALL NOTIFY APPROPRIATE AGENCIES AND SHALL INSTALL EROSION CONTROL MEASURES AS SHOWN ON THE PLANS AND AS IDENTIFIED IN FEDERAL, STATE, AND LOCAL APPROVAL DOCUMENTS PERTAINING TO THIS PROJECT.
- 3. CONTRACTOR SHALL INSPECT AND MAINTAIN EROSION CONTROL MEASURES ON A WEEKLY BASIS (MINIMUM). THE CONTRACTOR SHALL ADDRESS DEFICIENCIES AND MAINTENANCE ITEMS WITHIN TWENTY—FOUR HOURS OF INSPECTION. CONTRACTOR SHALL PROPERLY DISPOSE OF SEDIMENT SUCH THAT IT DOES NOT ENCUMBER OTHER DRAINAGE STRUCTURES AND PROTECTED AREAS.
- 4. CONTRACTOR SHALL BE FULLY RESPONSIBLE TO CONTROL CONSTRUCTION SUCH THAT SEDIMENTATION SHALL NOT AFFECT REGULATORY PROTECTED AREAS, WHETHER SUCH SEDIMENTATION IS CAUSED BY WATER, WIND, OR, DIRECT DEPOSIT.
- 5. CONTRACTOR SHALL PERFORM CONSTRUCTION SEQUENCING SUCH THAT EARTH MATERIALS ARE EXPOSED FOR A MINIMUM OF TIME BEFORE THEY ARE COVERED, SEEDED, OR OTHERWISE STABILIZED TO PREVENT EROSION.
- 6. UPON COMPLETION OF CONSTRUCTION AND ESTABLISHMENT OF PERMANENT GROUND COVER, CONTRACTOR SHALL REMOVE AND DISPOSE OF EROSION CONTROL MEASURES AND CLEAN SEDIMENT AND DEBRIS FROM ENTIRE DRAINAGE AND SEWER SYSTEMS.





COMMONWEALTH OF MASSACHUSETTS DEPARTMENT OF CONSERVATION AND RECREATION DIVISION OF ENGINEERING AND DIVISION OF PLANNING AND RESOURCE PROTECTION


CHARLESGATE PARK WALL REMOVAL

CHARLESGATE PARK BOSTON, MA

BDF BBK	KEY PLAN		SHEET NO.
BDF	CONT. P21-3434-C1A	scale: AS SHOWN	S-03
SBK	ACC.	DATE: 1/3/2022	3 OF 16

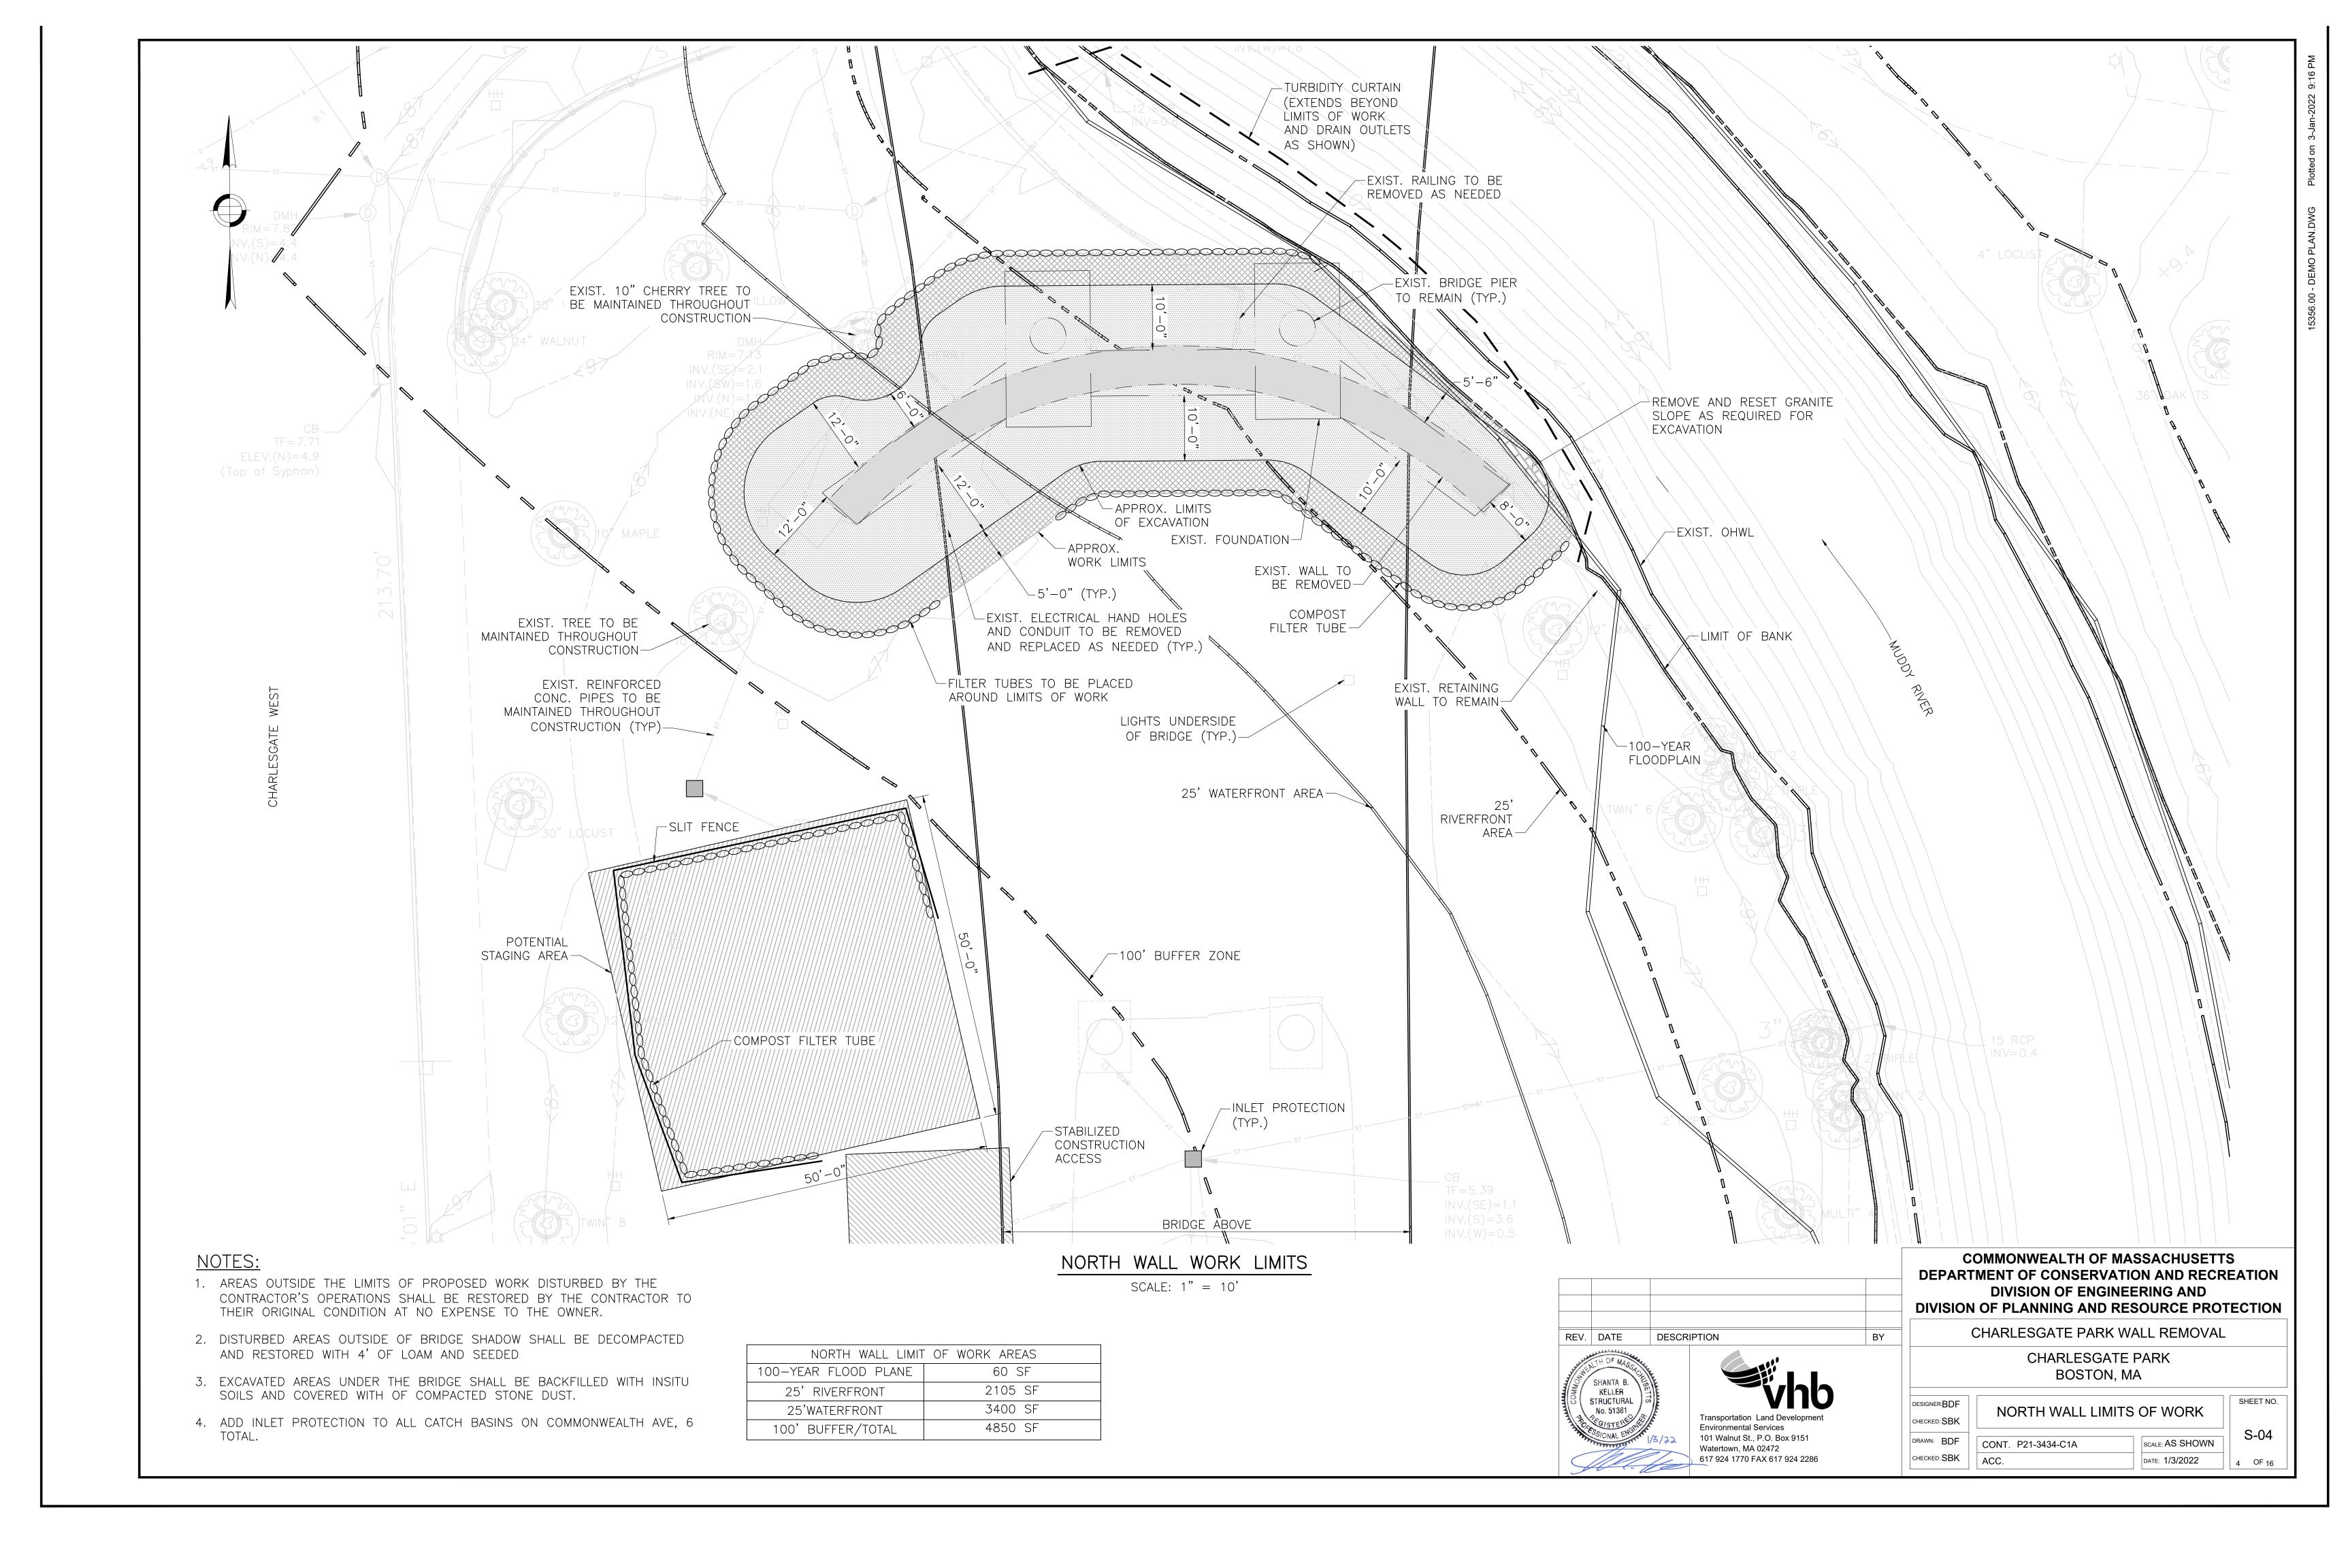

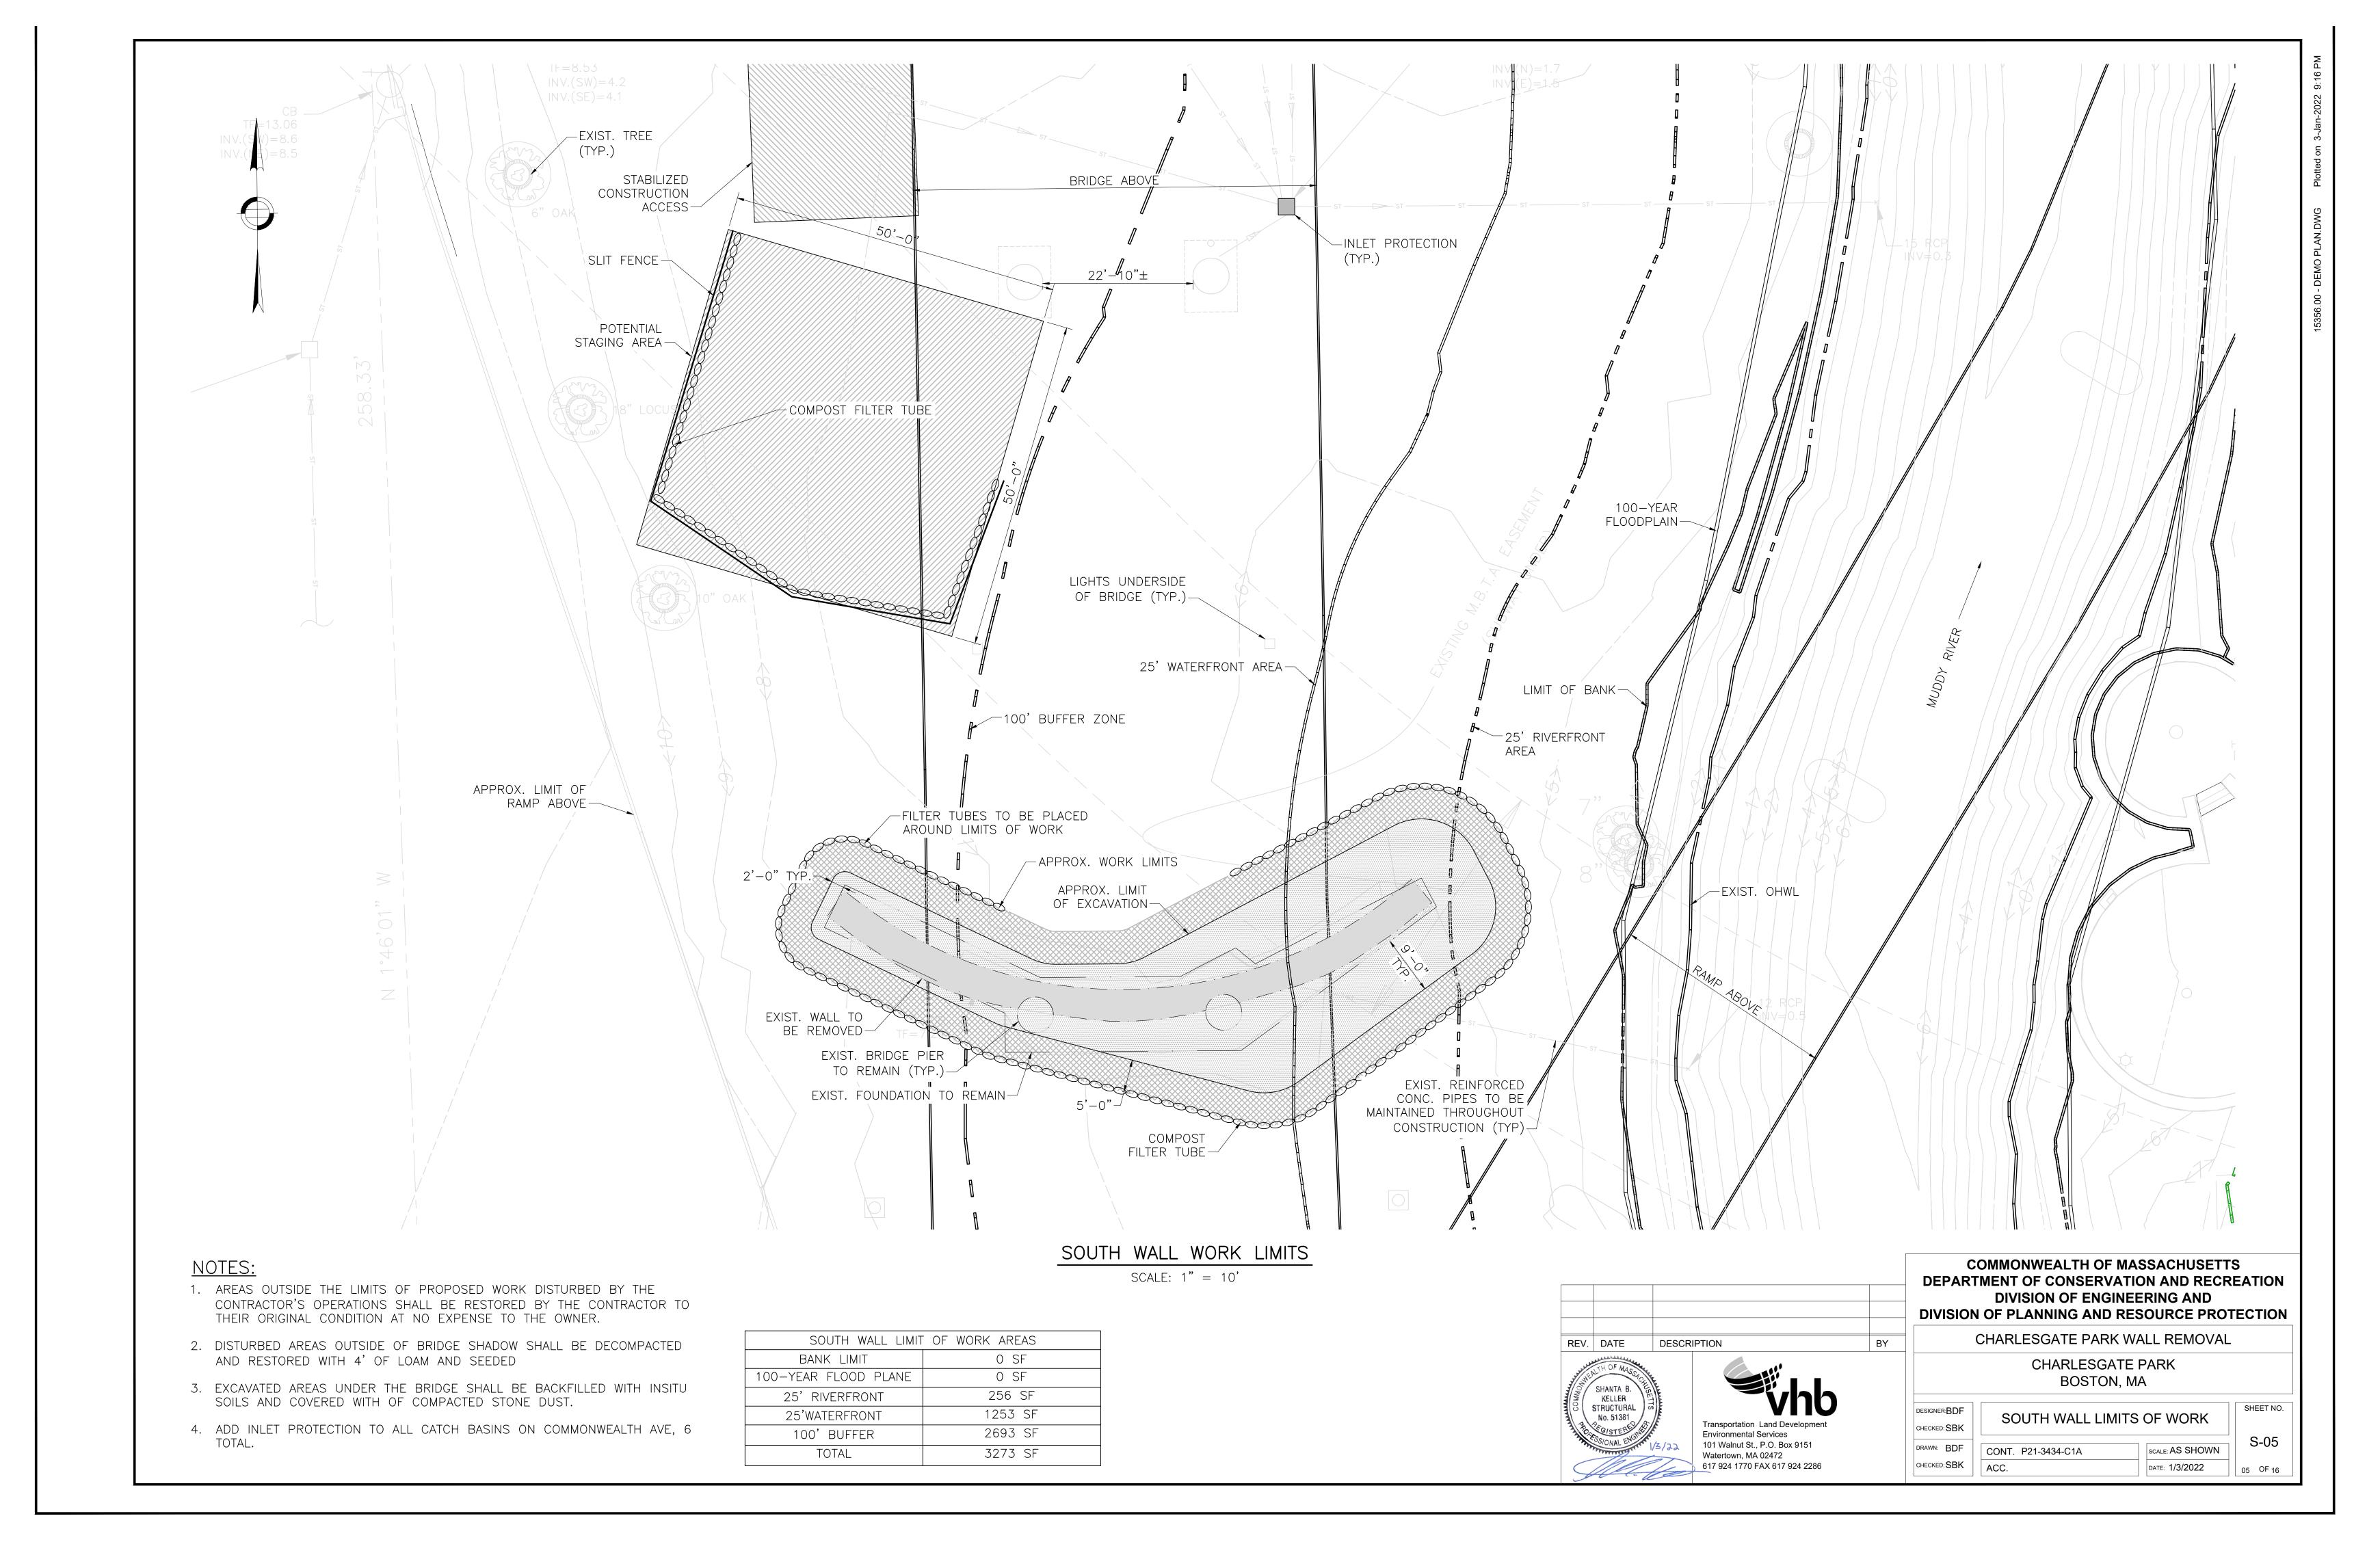

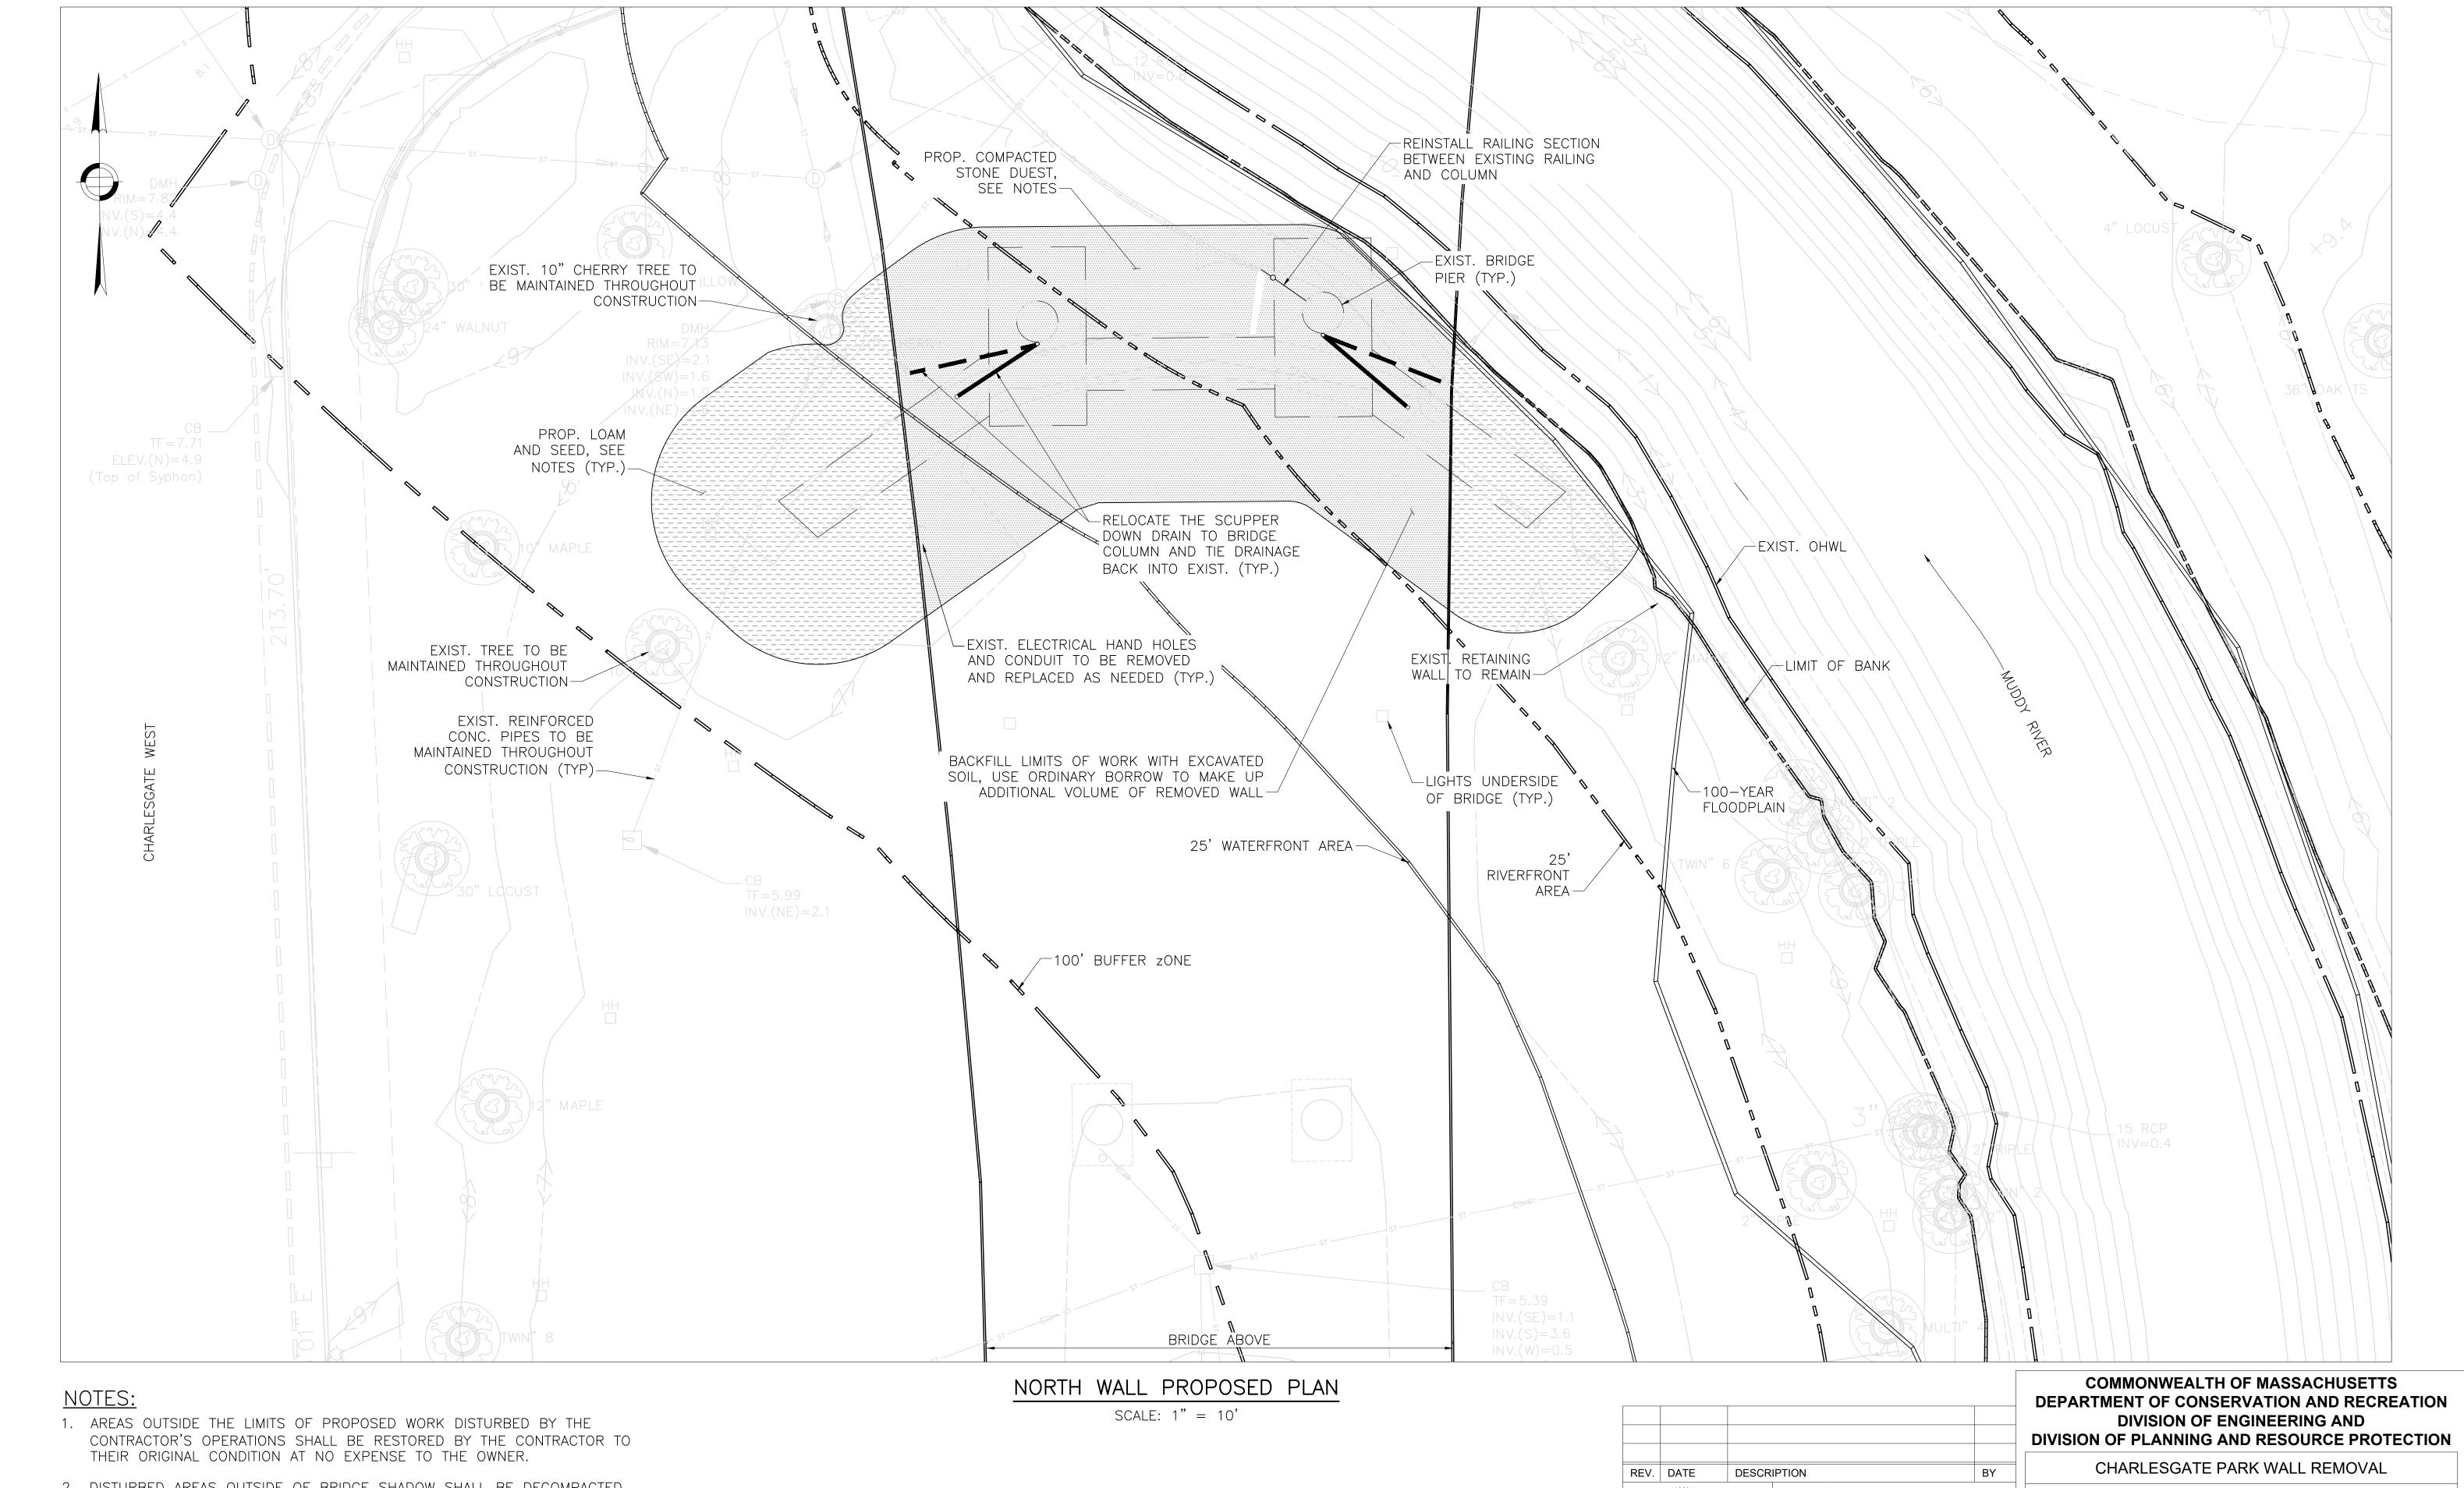

- 2. DISTURBED AREAS OUTSIDE OF BRIDGE SHADOW SHALL BE DECOMPACTED AND RESTORED WITH 4' OF LOAM AND SEEDED
- 3. EXCAVATED AREAS UNDER THE BRIDGE SHALL BE BACKFILLED WITH INSITU SOILS AND COVERED WITH OF COMPACTED STONE DUST.



CHARLESGATE PARK WALL REMOVAL

CHARLESGATE PARK
BOSTON, MA

DESIGNER:BDF
CHECKED: SBK

DRAWN: BDF
CHECKED: SBK

CONT. P21-3434-C1A
ACC.

ACC.

CHARLESGATE PARK
BOSTON, MA

SHEET NO.

S-06
6 OF 16



NOTES:

- 1. AREAS OUTSIDE THE LIMITS OF PROPOSED WORK DISTURBED BY THE CONTRACTOR'S OPERATIONS SHALL BE RESTORED BY THE CONTRACTOR TO THEIR ORIGINAL CONDITION AT NO EXPENSE TO THE OWNER.
- 2. DISTURBED AREAS OUTSIDE OF BRIDGE SHADOW SHALL BE DECOMPACTED AND RESTORED WITH 4' OF LOAM AND SEEDED
- 3. EXCAVATED AREAS UNDER THE BRIDGE SHALL BE BACKFILLED WITH INSITU SOILS AND COVERED WITH OF COMPACTED STONE DUST.
- 4. EXISTING DRAIN PIPE LOCATIONS TO BE VERIFIED PRIOR TO BEGINNING ANY EXCAVATION,

SCALE: 1" = 10'



COMMONWEALTH OF MASSACHUSETTS DEPARTMENT OF CONSERVATION AND RECREATION **DIVISION OF ENGINEERING AND** DIVISION OF PLANNING AND RESOURCE PROTECTION

CHARLESGATE PARK WALL REMOVAL CHARLESGATE PARK

	BOSTON, MA
NER:BDF	SOUTH WALL PROPOSED P
KED: SBK	300 III WALL FROFOSLD F


BDF BBK	SOUTH WALL PROPOSED PLAN		SHEET NO.
BDF	CONT. P21-3434-C1A SCALE: AS SHOWN		S-07
SBK	ACC.	DATE: 1/3/2022	07 OF 16

OTES:

- 1. FILTER CLOTH SHALL BE FASTENED SECURELY TO POSTS WITH WIRE TIES OR STAPLES, AND POSTS SHALL BE SPACED EVERY 10 FEET.
- 2. WHEN TWO SECTIONS OF FILTER CLOTH ADJOIN EACH OTHER, THEY SHALL BE OVERLAPPED BY 6 INCHES AND FOLDED.
- ENTRENCH SILT FENCE BUT NOT COMPOST FILTER TUBE.
 INSPECTIONS SHALL BE FREQUENT, AND REPAIR OR
- 5. TUBES FOR COMPOST FILTERS SHALL BE JUTE MESH OR APPROVED BIODEGRADABLE MATERIAL. ADDITIONAL TUBES SHALL BE USED AT THE DIRECTION OF THE ENGINEER. TAMP TUBES IN PLACE TO ENSURE GOOD CONTACT WITH SOIL SURFACE. IT IS NOT NECESSARY TO TRENCH TUBES INTO EXISTING GRADE.
- 6. TUBES CAN BE PLACED DIRECTLY ON EXISTING PAVEMENT WHEN NECESSARY.

REPLACEMENT SHALL BE MADE PROMPTLY.

7. PROVIDE A 3 FT. MINIMUM OVERLAP AT ENDS OF TUBES TO JOIN IN A CONTINUOUS BARRIER AND MINIMIZE UNIMPEDED FLOW. STAKE JOINING TUBES SNUGLY AGAINST EACH OTHER TO PREVENT UNFILTERED FLOW BETWEEN THEM.

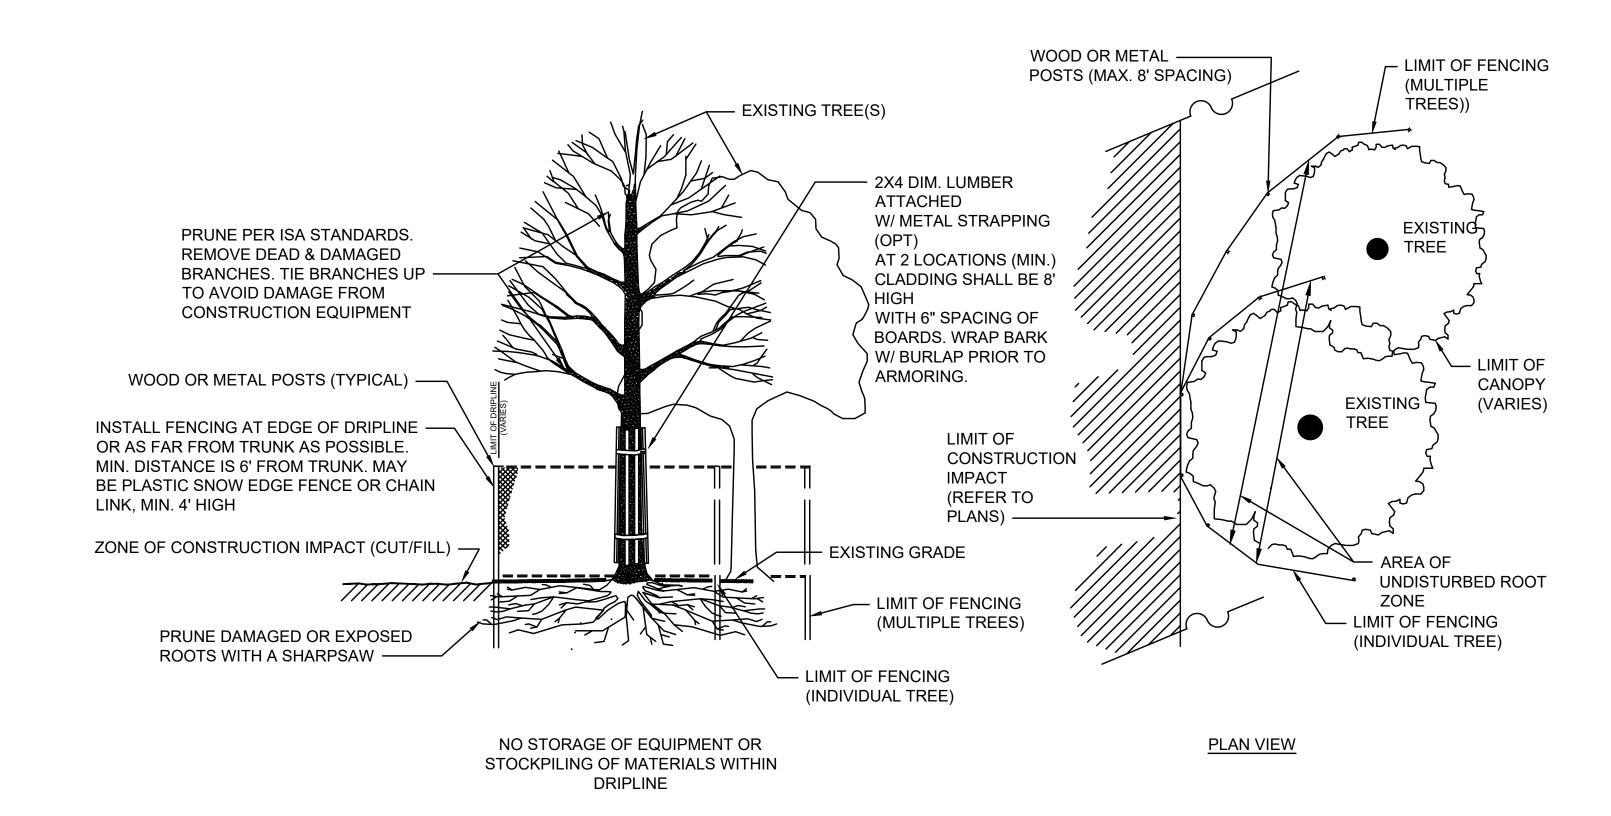


TREE PROTECTION OF EXISTING TREE(S)

SCALE: N.T.S.

COMPOST FILTER TUBE AND SILT FENCE DETAIL - TYPE A EROSION CONTROL BARRIER


SCALE: NTS

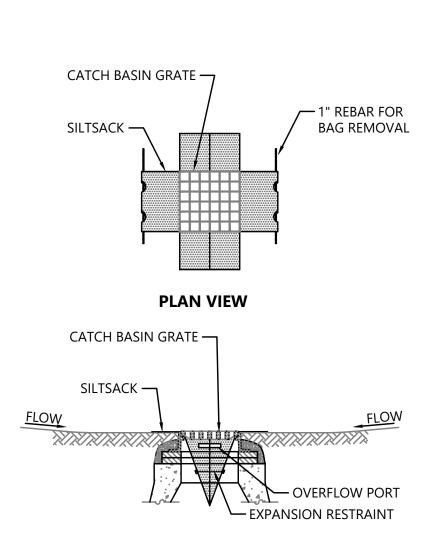

SECTION VIEW

NOTES

- 1. INSTALL SILTSACK IN ALL CATCH BASINS WHERE INDICATED ON THE PLAN BEFORE COMMENCING WORK OR IN PAVED AREAS AFTER BINDER COURSE IS PLACED AND HAY BALES HAVE BEEN REMOVED.
- 2. GRATE TO BE PLACED OVER SILTSACK.
- 3. SILTSACK SHALL BE INSPECTED PERIODICALLY AND AFTER ALL STORM EVENTS AND CLEANING OR REPLACEMENT SHALL BE PERFORMED PROMPTLY AS NEEDED. MAINTAIN UNTIL UPSTREAM AREAS HAVE BEEN PERMANENTLY STABILIZED

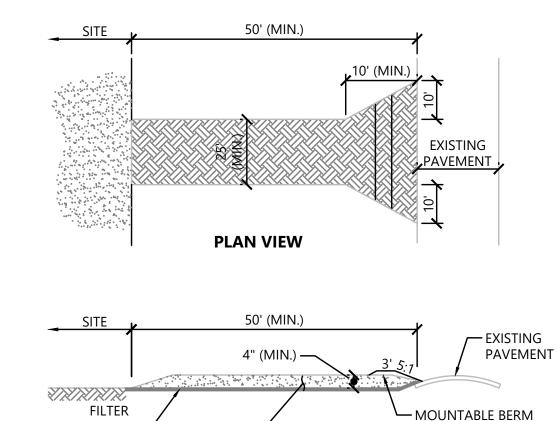


CROSS-SECTION

NOTES

FABRIC -

1½" CRUSHED STONE -

- EXIT WIDTH SHALL BE A TWENTY-FIVE (25) FOOT MINIMUM, BUT NOT LESS THAN THE FULL WIDTH AT POINTS WHERE INGRESS OR EGRESS OCCURS.
- 2. THE EXIT SHALL BE MAINTAINED IN A CONDITION WHICH SHALL PREVENT TRACKING OR FLOWING OF SEDIMENT ONTO PUBLIC RIGHTS-OF-WAY. THIS MAY REQUIRE PERIODIC TOP DRESSING WITH ADDITIONAL STONE AS CONDITIONS DEMAND AND REPAIR OR CLEANOUT OF ANY MEASURES USED TO TRAP SEDIMENT. ALL SEDIMENT SPILLED, DROPPED, WASHED OR TRACKED ONTO PUBLIC RIGHTS-OF-WAY MUST BE REMOVED IMMEDIATELY. BERM SHALL BE PERMITTED. PERIODIC INSPECTION AND MAINTENANCE SHALL BE PROVIDED AS NEEDED.
- 3. STABILIZED CONSTRUCTION EXIT SHALL BE REMOVED PRIOR TO FINAL FINISH MATERIALS BEING INSTALLED.

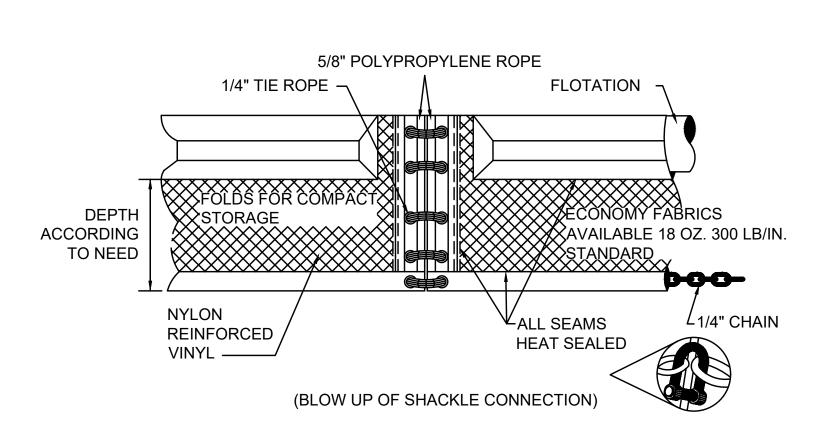

TURBIDITY CURTAIN DETAIL - EROSION CONTROL BARRIER TYPE C

SCALE: N.T.S.



COMMONWEALTH OF MASSACHUSETTS DEPARTMENT OF CONSERVATION AND RECREATION DIVISION OF ENGINEERING AND DIVISION OF PLANNING AND RESOURCE PROTECTION

	CHARLESGATE PARK WALL REMOVAL			
DESIGNER:BDF CHECKED: SBK	EROSION CONTROL DE	ETAILS 1 OF 2	SHEET NO.	
DRAWN: BDF CHECKED: SBK	CONT. P21-3434-C1A ACC.	SCALE: AS SHOWN DATE: 1/3/2022	S-08 08 OF 16	


INLET PROTECTION - SILT SACK IN CATCH BASIN

SCALE: N.T.S.

STABILIZED CONSTRUCTION EXIT

SCALE: N.T.S.


SHEET NO.

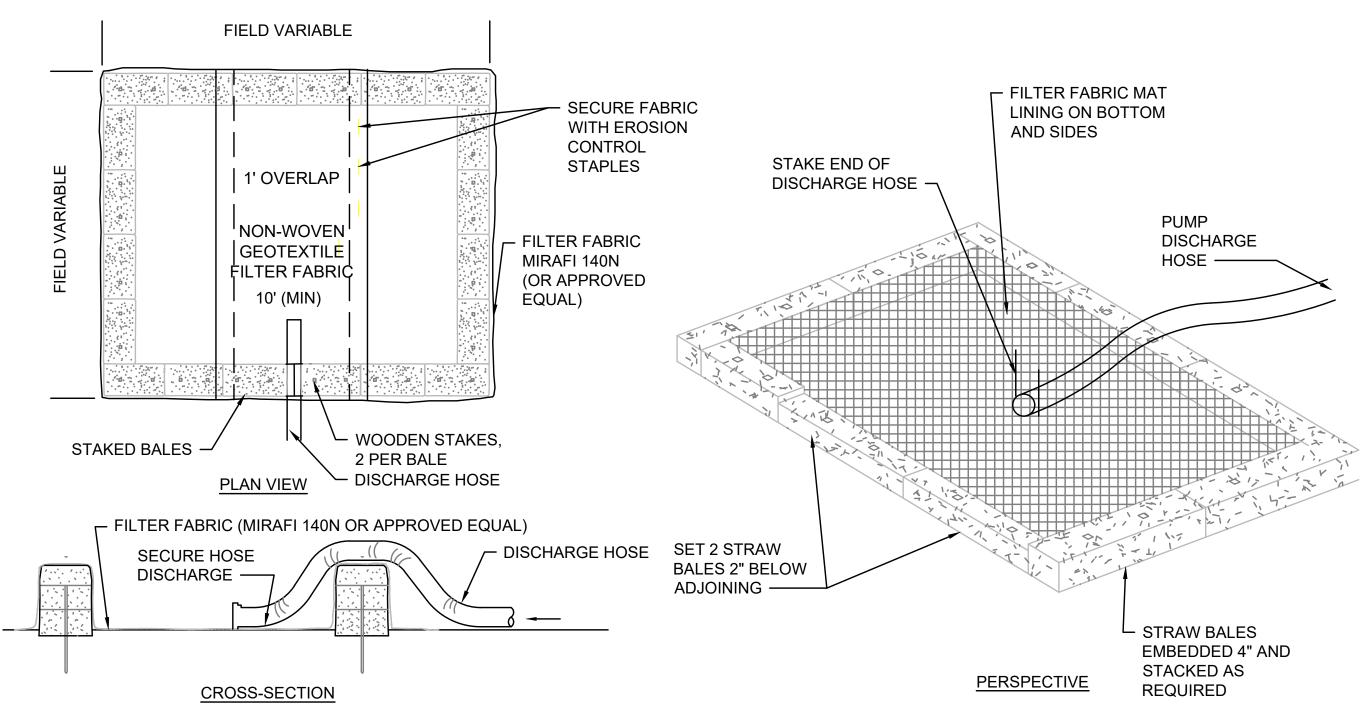

- 1. NUMBER OF BALES MAY VARY DEPENDING ON SITE CONDITIONS.
- 2. THE BASIN TO BE SIZED TO PREVENT DISCHARGE WATER FROM OVERTOPPING BASIN.
- 3. WITHIN THE TOWN OF STOW, THE CONTRACTOR SHALL NOTIFY THE STOW CONSERVATION COMMISSION PRIOR TO ANY PLANNED DEWATERING AND THE CONSERVATION COMMISSION MUST APPROVE THIS WORK IN THE FIELD PRIOR TO COMMENCEMENT

DEWATERING STRAW BALE BASIN


SCALE: N.T.S.

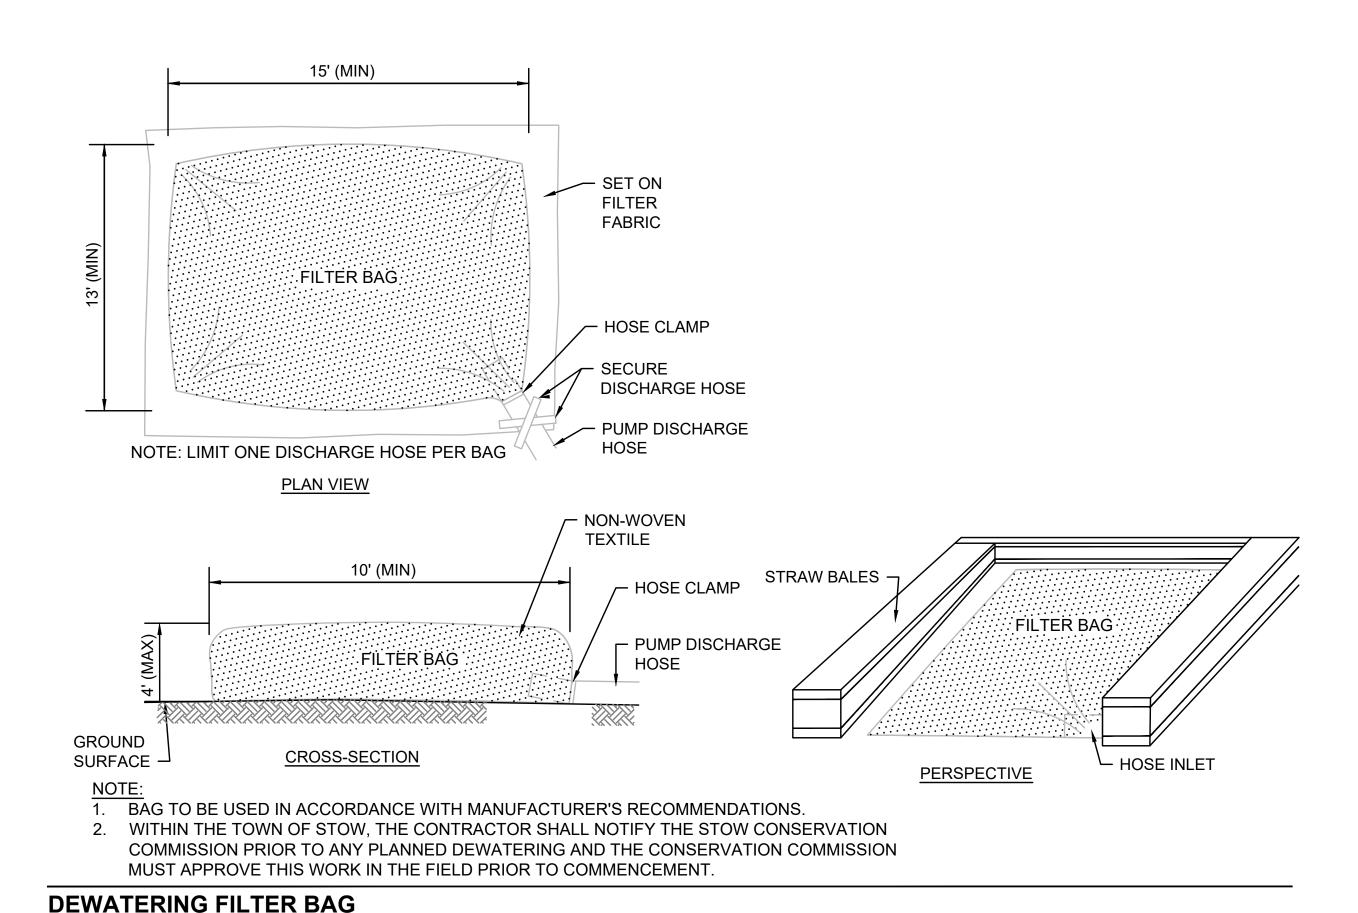

BOTTOM OF SLOPE-<u>SECTION - DOUBLE COURSE COIR LOG:</u> FIELD VERIFY THE EXISTING SLOPE AND INSTALL THE COIR LOG AS REQUIRED BASED ON THE EXISTING SLOPE. CONTRACTOR TO VERIFY

SLOPE STABILITY WITH COIR LOG MANUFACTURER PRIOR TO INSTALLATION.

SPECS

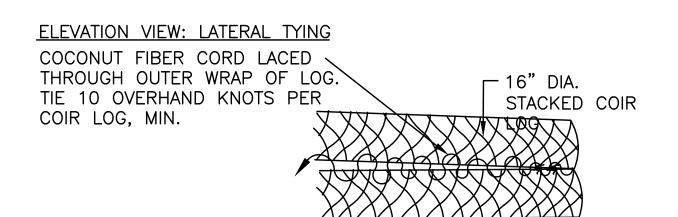


COMPACTED OR UNDISTURBED SUBGRAGE


2"x2"x4.5' WOOD STAKE

BOTH SIDES, 3'-0" O.C.

DOUBLE-STACKED 16"-

DIAMETER COIR LOGS, SEE

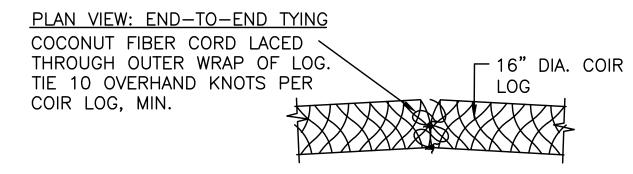

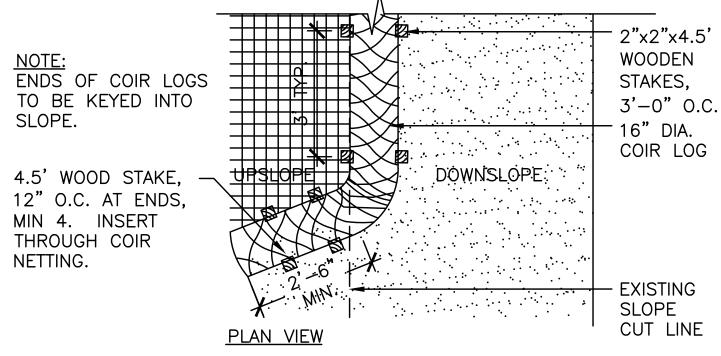

COIR LOG NOTES:


SLOPE.


NETTING.


DETAIL IS REPRESENTATIVE ONLY. PURPOSE IS TO SHOW DESIGN INTENT. PRIOR TO PLANT INSTALLATION PLANT LAYOUT SHALL BE STAKED OUT BY CONTRACTOR AND APPROVED BY OWNER'S REPRESENTATIVE.


COIR LOG

SCALE: N.T.S.

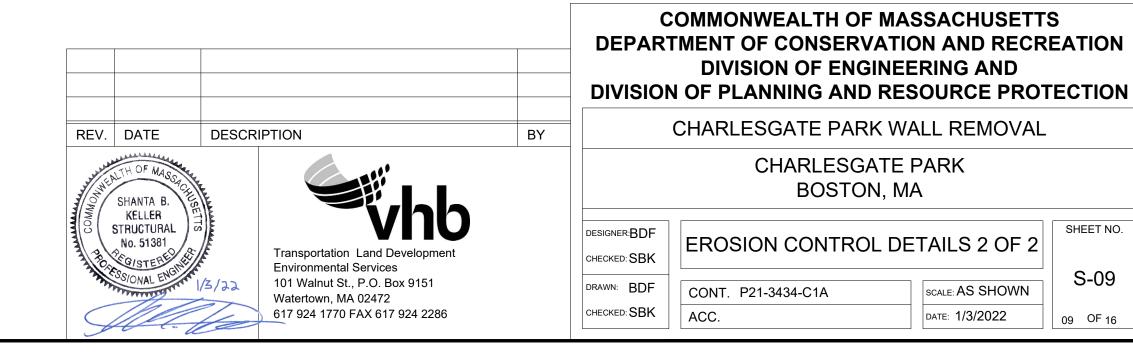


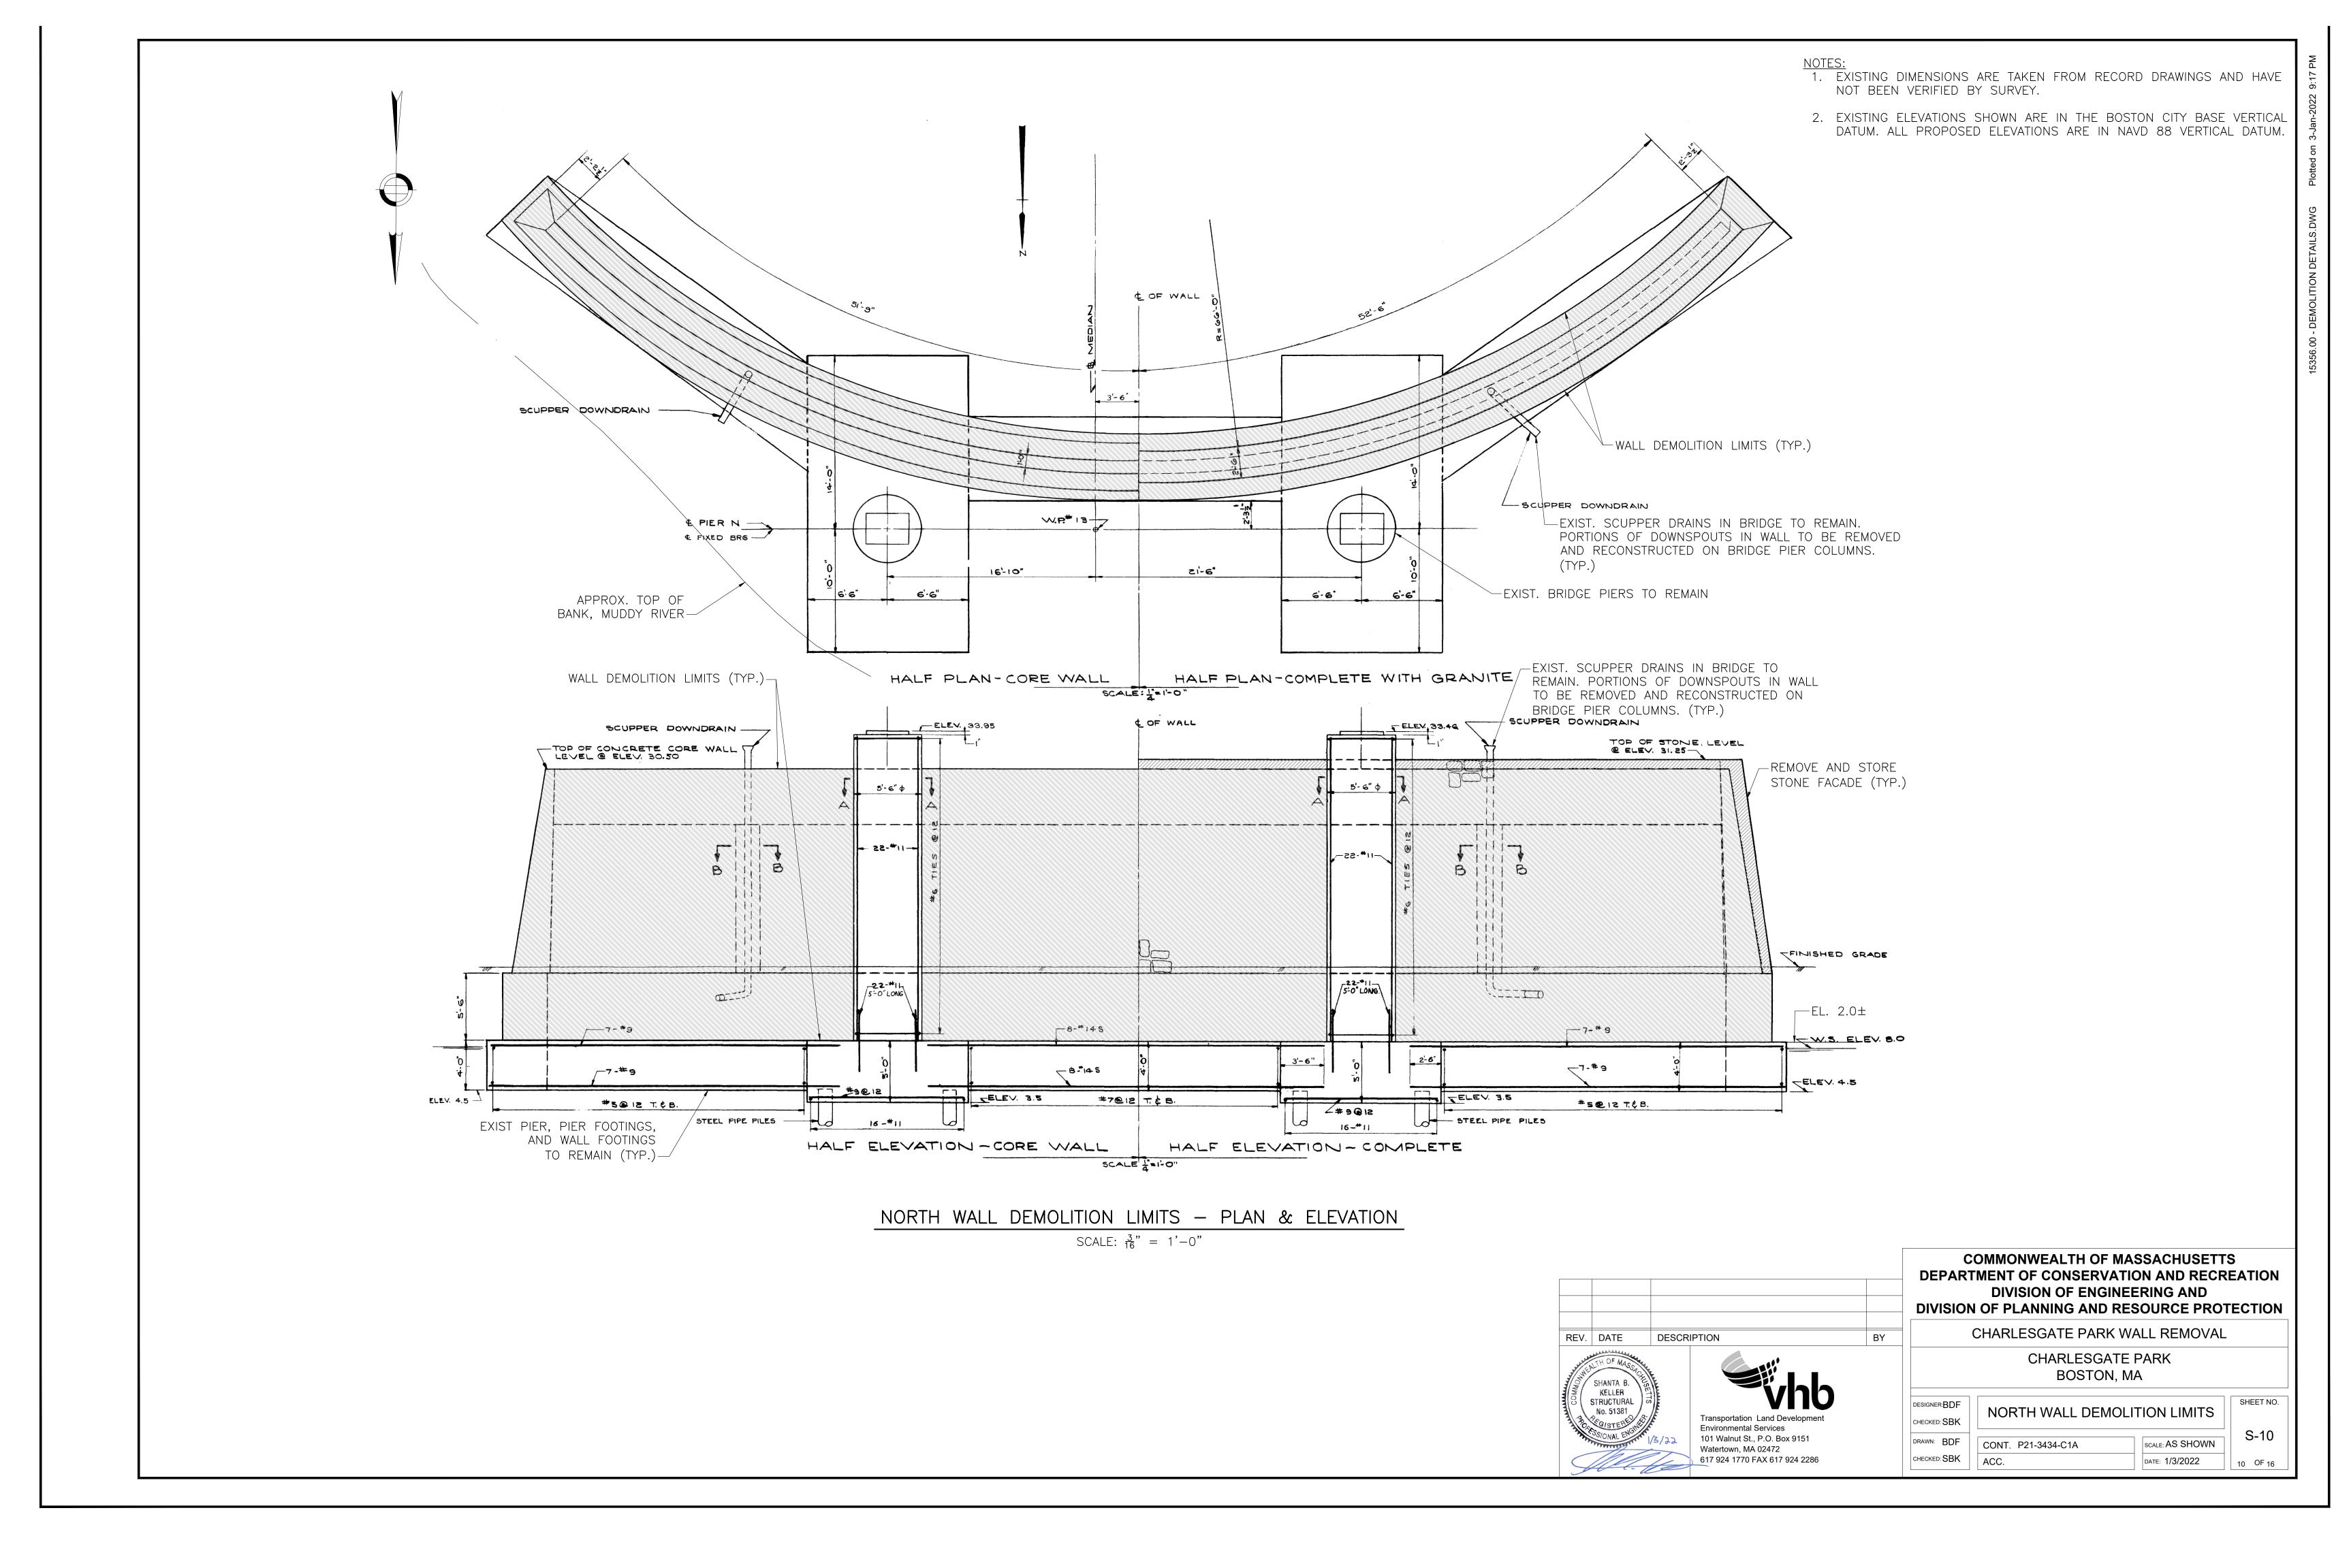

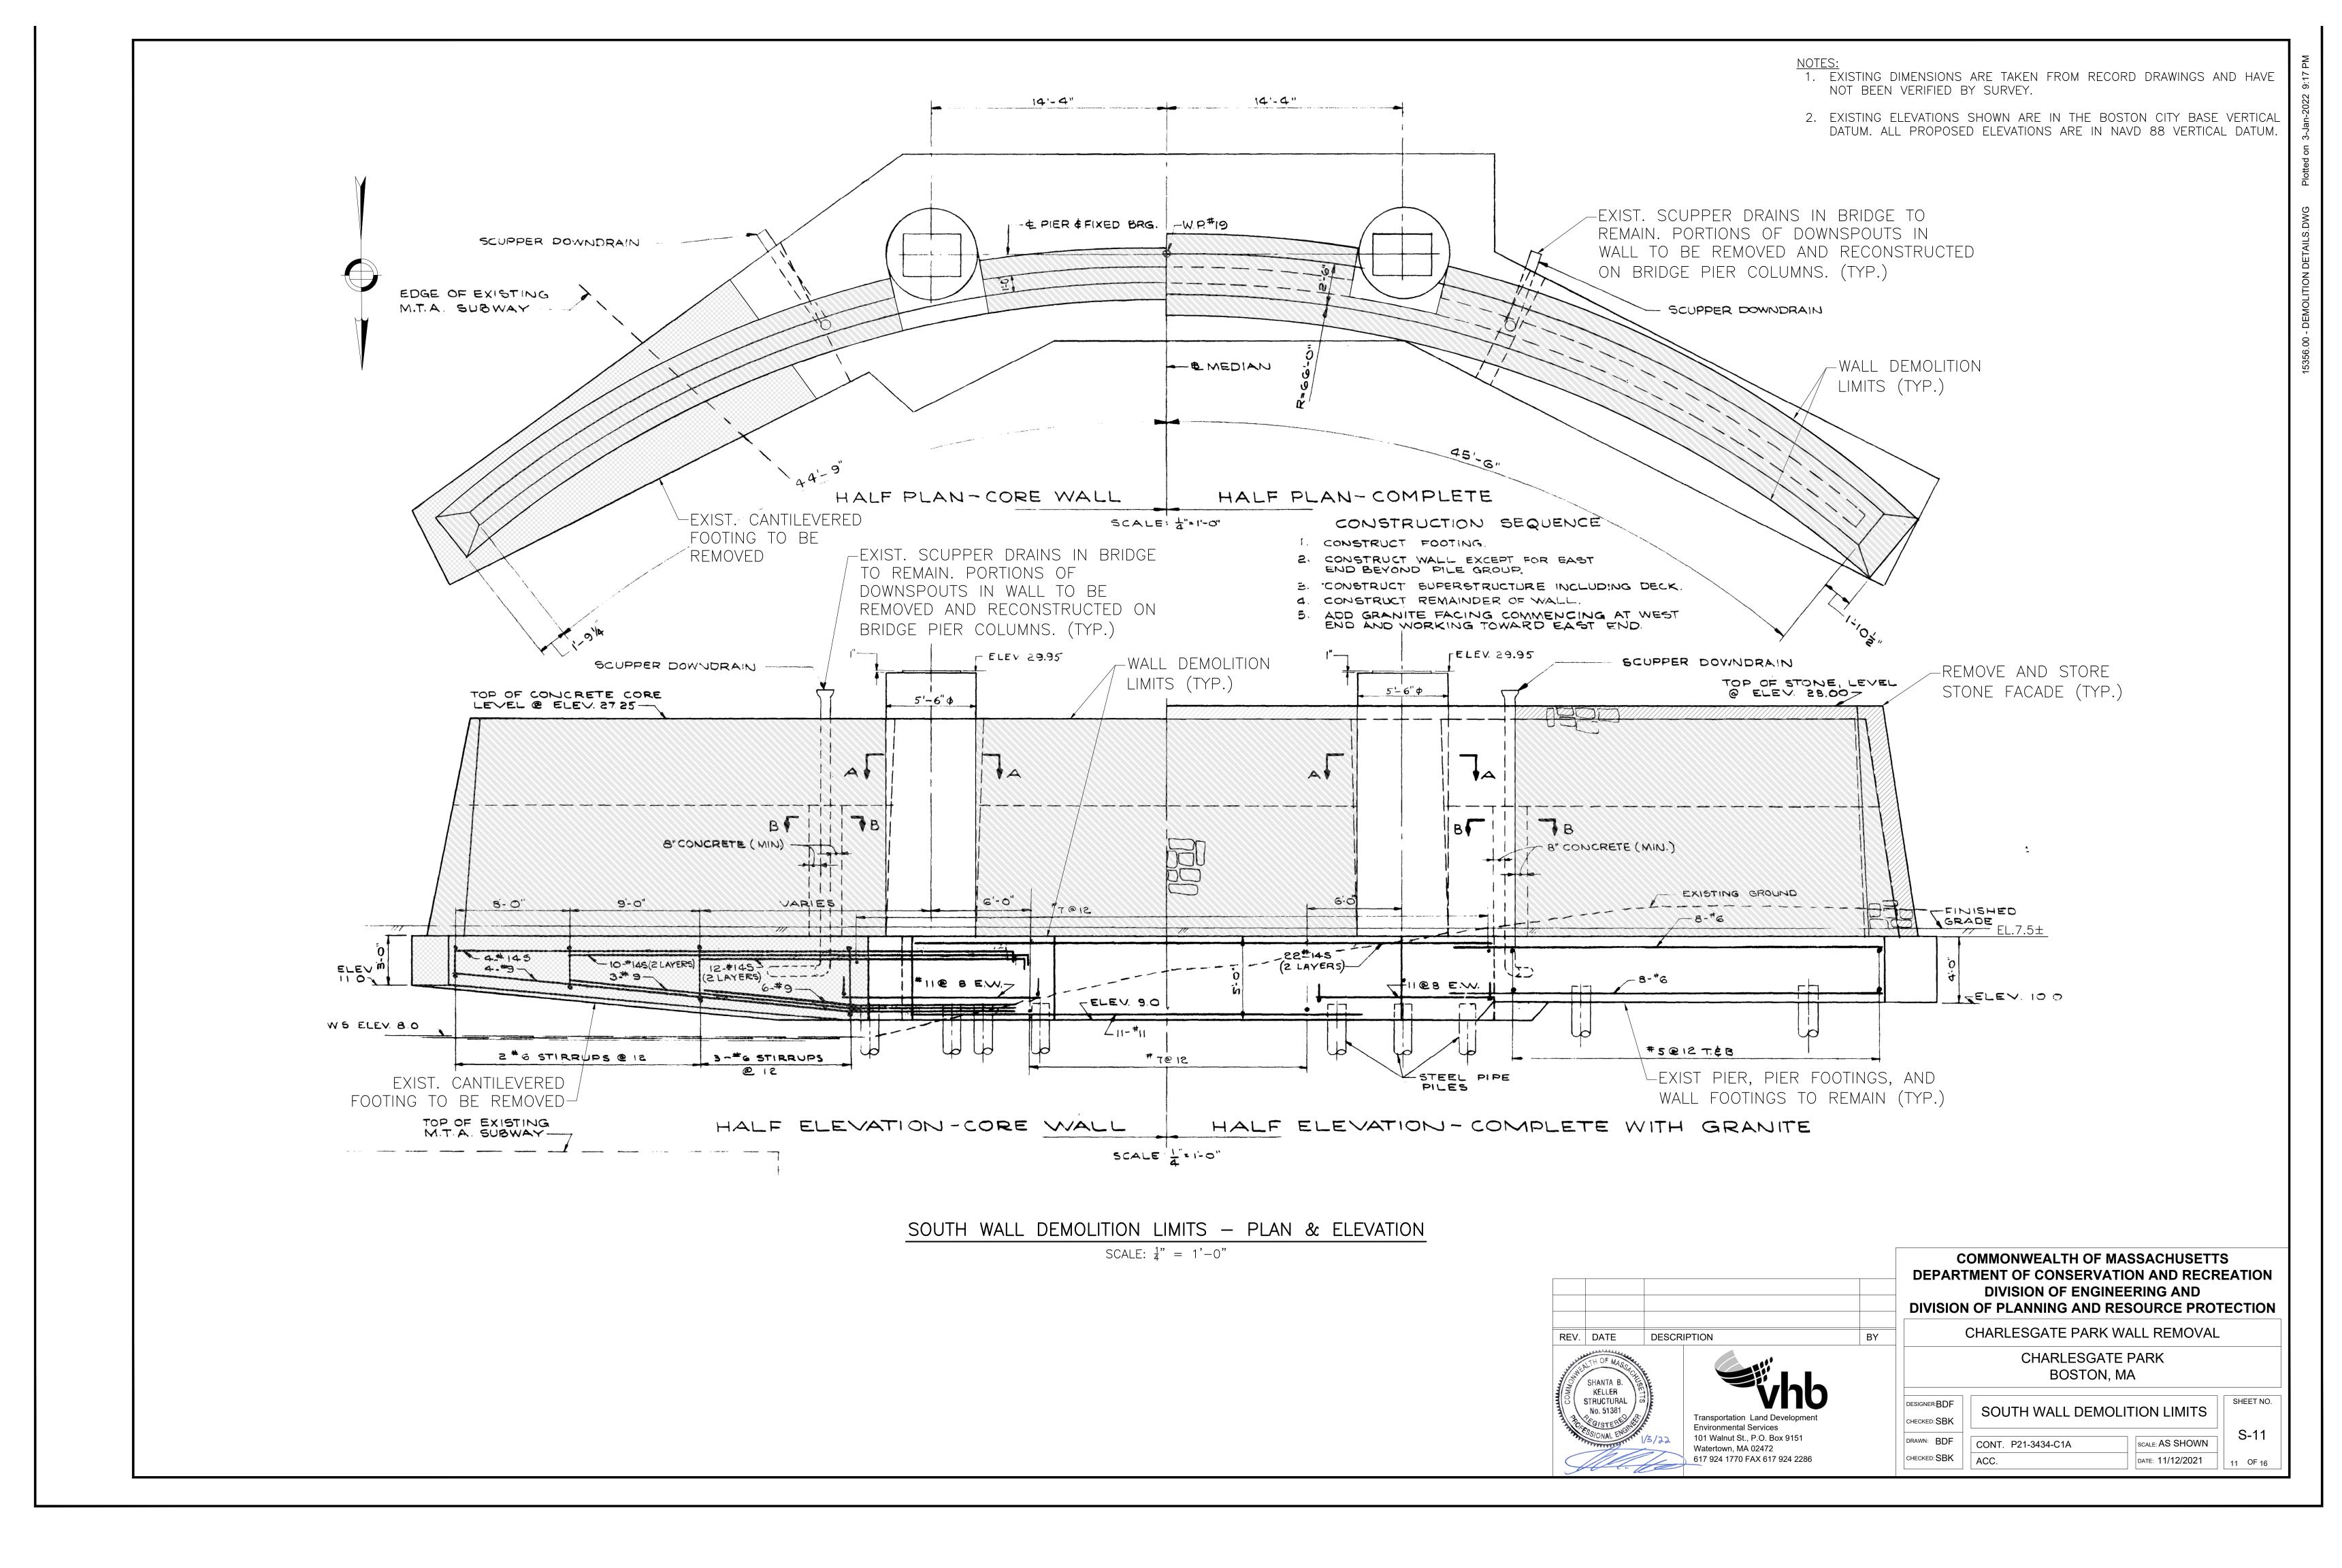


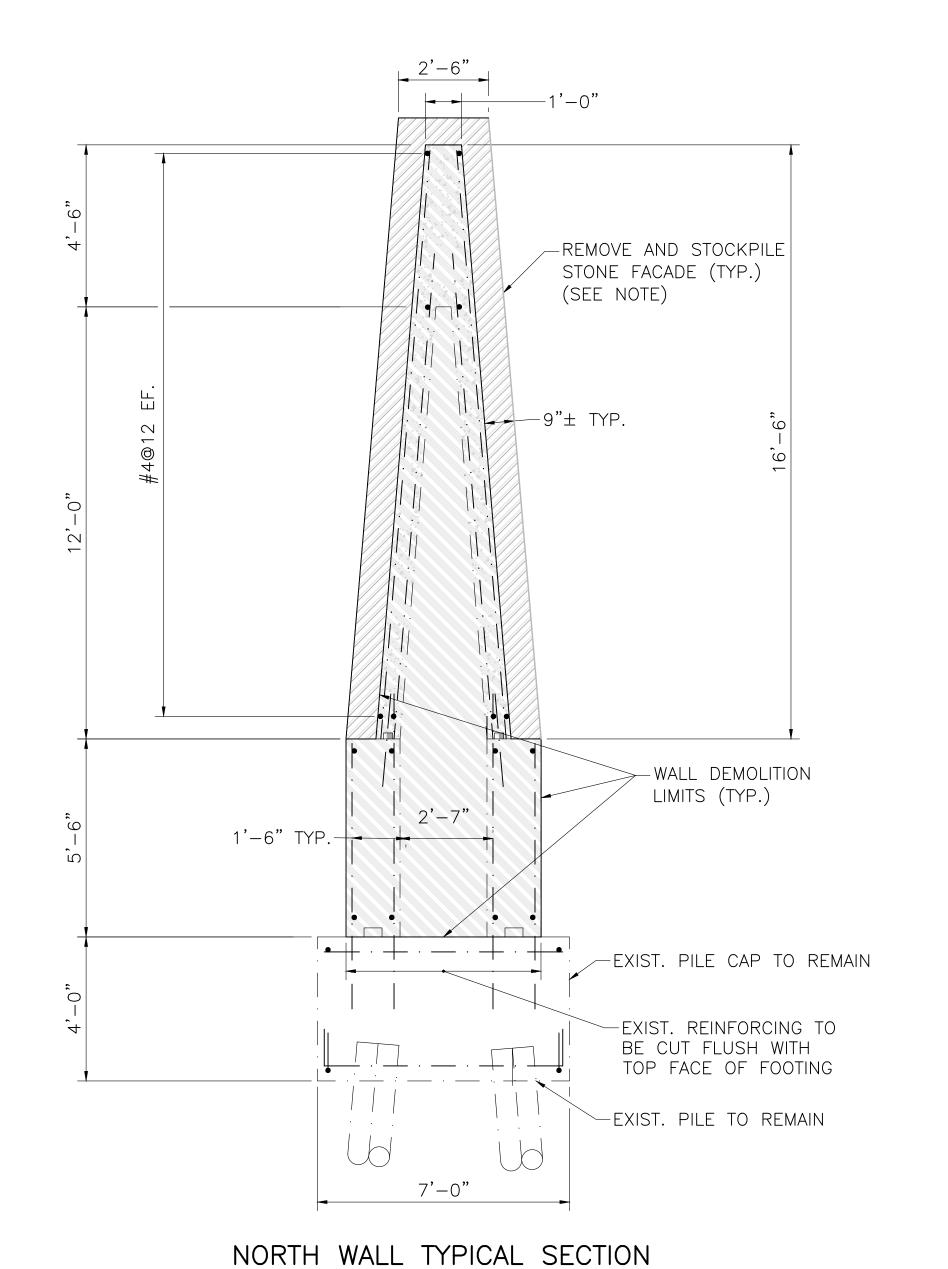

SCALE: $\frac{3}{8}$ " = 1'-0"

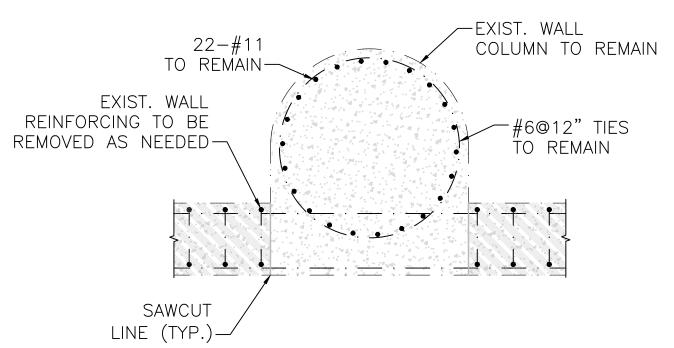


SOUTH WALL SECTION AT BRIDGE COLUMN

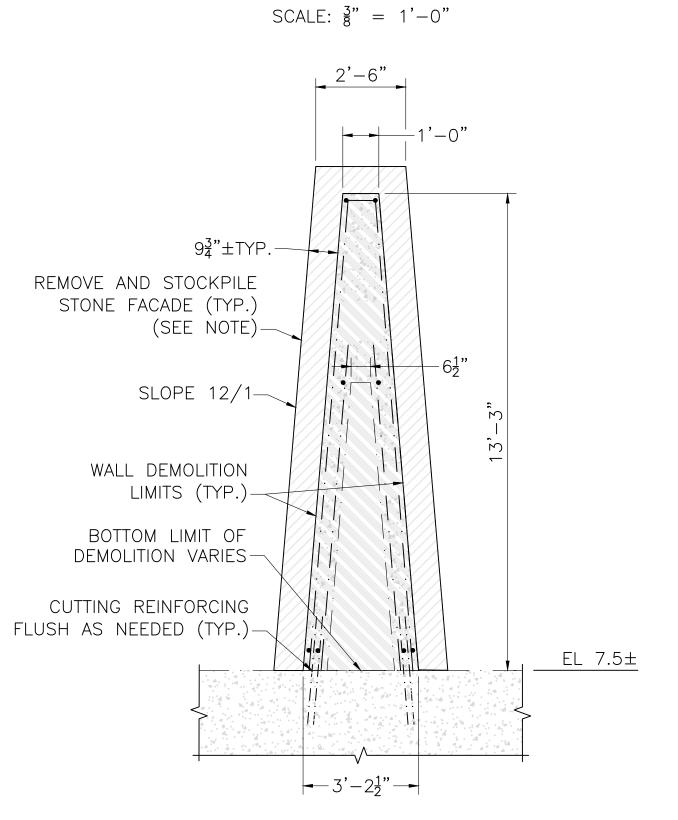

SOUTH WALL TYPICAL SECTION SCALE: $\frac{3}{8}$ " = 1'-0"

- 1. EXISTING DIMENSIONS ARE TAKEN FROM RECORD DRAWINGS AND HAVE NOT BEEN VERIFIED BY SURVEY.
- 2. 200 SF OF STONE FACADE SHALL BE RETAINED AND STOCKPILED ON SITE IN GOOD CONDITION.
- 3. NEWLY EXPOSED REBAR SHALL BE COATED WITH AND APPROVED GALVANIZED REPAIR PRODUCT.
- 4. TOP SURFACES OF PILE CAPS (FOOTINGS) AND ALL NEWLY EXPOSED CONCRETE SURFACES TO BE BACKFILLED SHALL RECEIVE A DAMPPROOFING LAYER PER MASSDOT STANDARD SPECIFICATIONS AFTER REPAIRING DAMAGED AREAS WHERE NECESSARY.

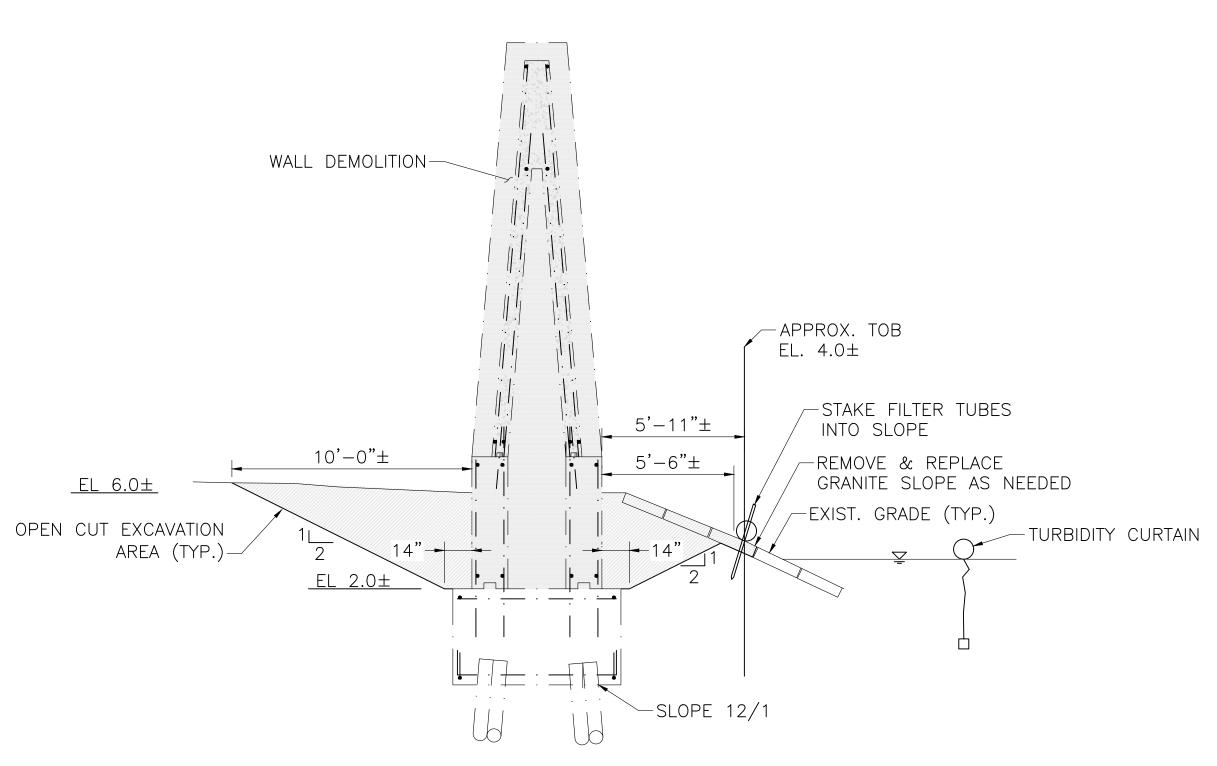


NORTH WALL - EXCAVATION AT NORTHEAST CORNER SCALE: $\frac{1}{4}$ " = 1'-0"



COMMONWEALTH OF MASSACHUSETTS DEPARTMENT OF CONSERVATION AND RECREATION

DIVISION OF PLANNING AND RESOURCE PROT			
	CHARLESGATE PARK	WALL REMOVAL	
CHARLESGATE PARK BOSTON, MA			
DESIGNER:BDF CHECKED: SBK	DEMOLITION DE	TAILS 1 OF 2	SHEET NO
1		40.01101441	S-12
DRAWN: BDF	CONT. P21-3434-C1A	SCALE: AS SHOWN	

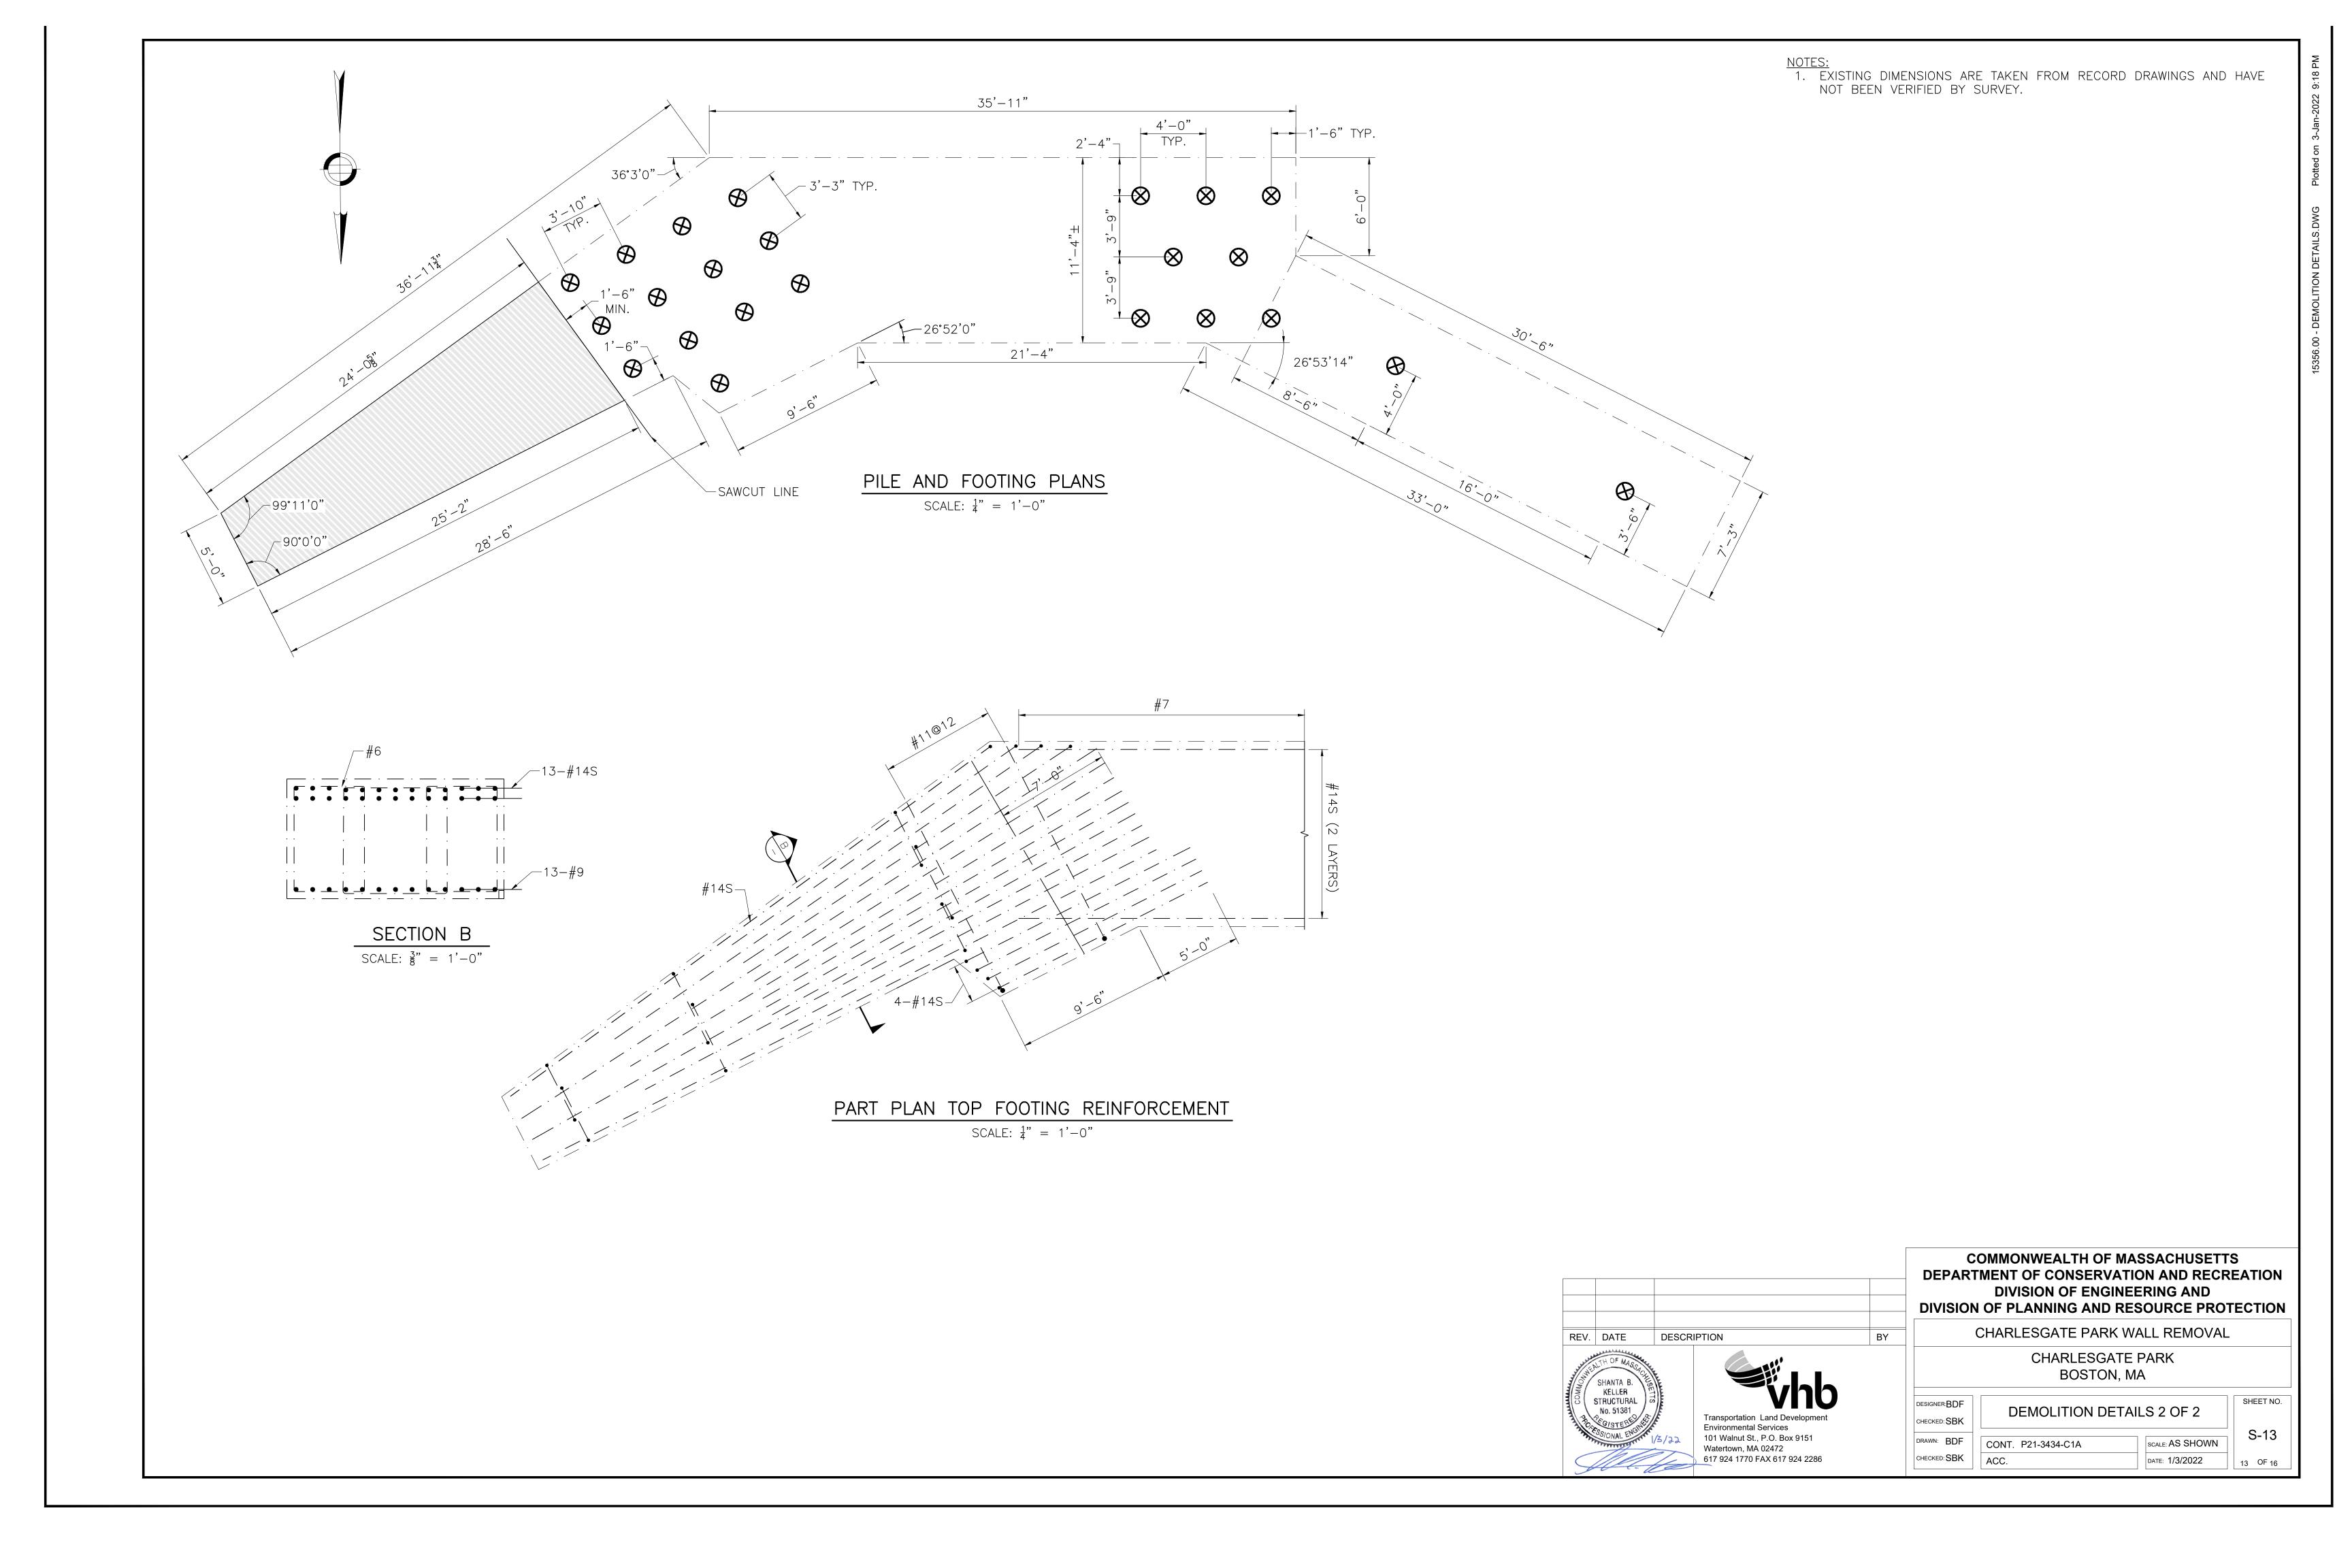

NORTH WALL WATER MANAGEMENT - PLAN & ELEVATION SCALE: \(\frac{1}{4}\)" = 1'-0"

NOTES:

1. EXISTING ELEVATIONS SHOWN ARE IN THE BOSTON CITY BASE VERTICAL DATUM. ALL PROPOSED ELEVATIONS ARE IN NAVD 88 VERTICAL DATUM.

2. RECONSTRUCT NEW DOWNSPOUTS ON PIER COLUMNS PRIOR TO DEMOLISHING WALL, SO DOWNSPOUTS CAN BE QUICKLY SPLICED OVER AND BRIDGE DRAINAGE CAN BE MAINTAINED.



COMMONWEALTH OF MASSACHUSETTS DEPARTMENT OF CONSERVATION AND RECREATION DIVISION OF ENGINEERING AND DIVISION OF PLANNING AND RESOURCE PROTECTION

CHARLESGATE PARK WALL REMOVAL
CHARLESGATE PARK
BOSTON, MA

DESIGNER:BDF
CHECKED: SBK


DRAWN: BDF


CONT. P21-3434-C1A

SCALE: AS SHOWN

DRAWN: BDF CONT. P21-3434-C1A SCALE: AS SHOWN DATE: 1/3/2022 14 OF 16


SHEET NO.

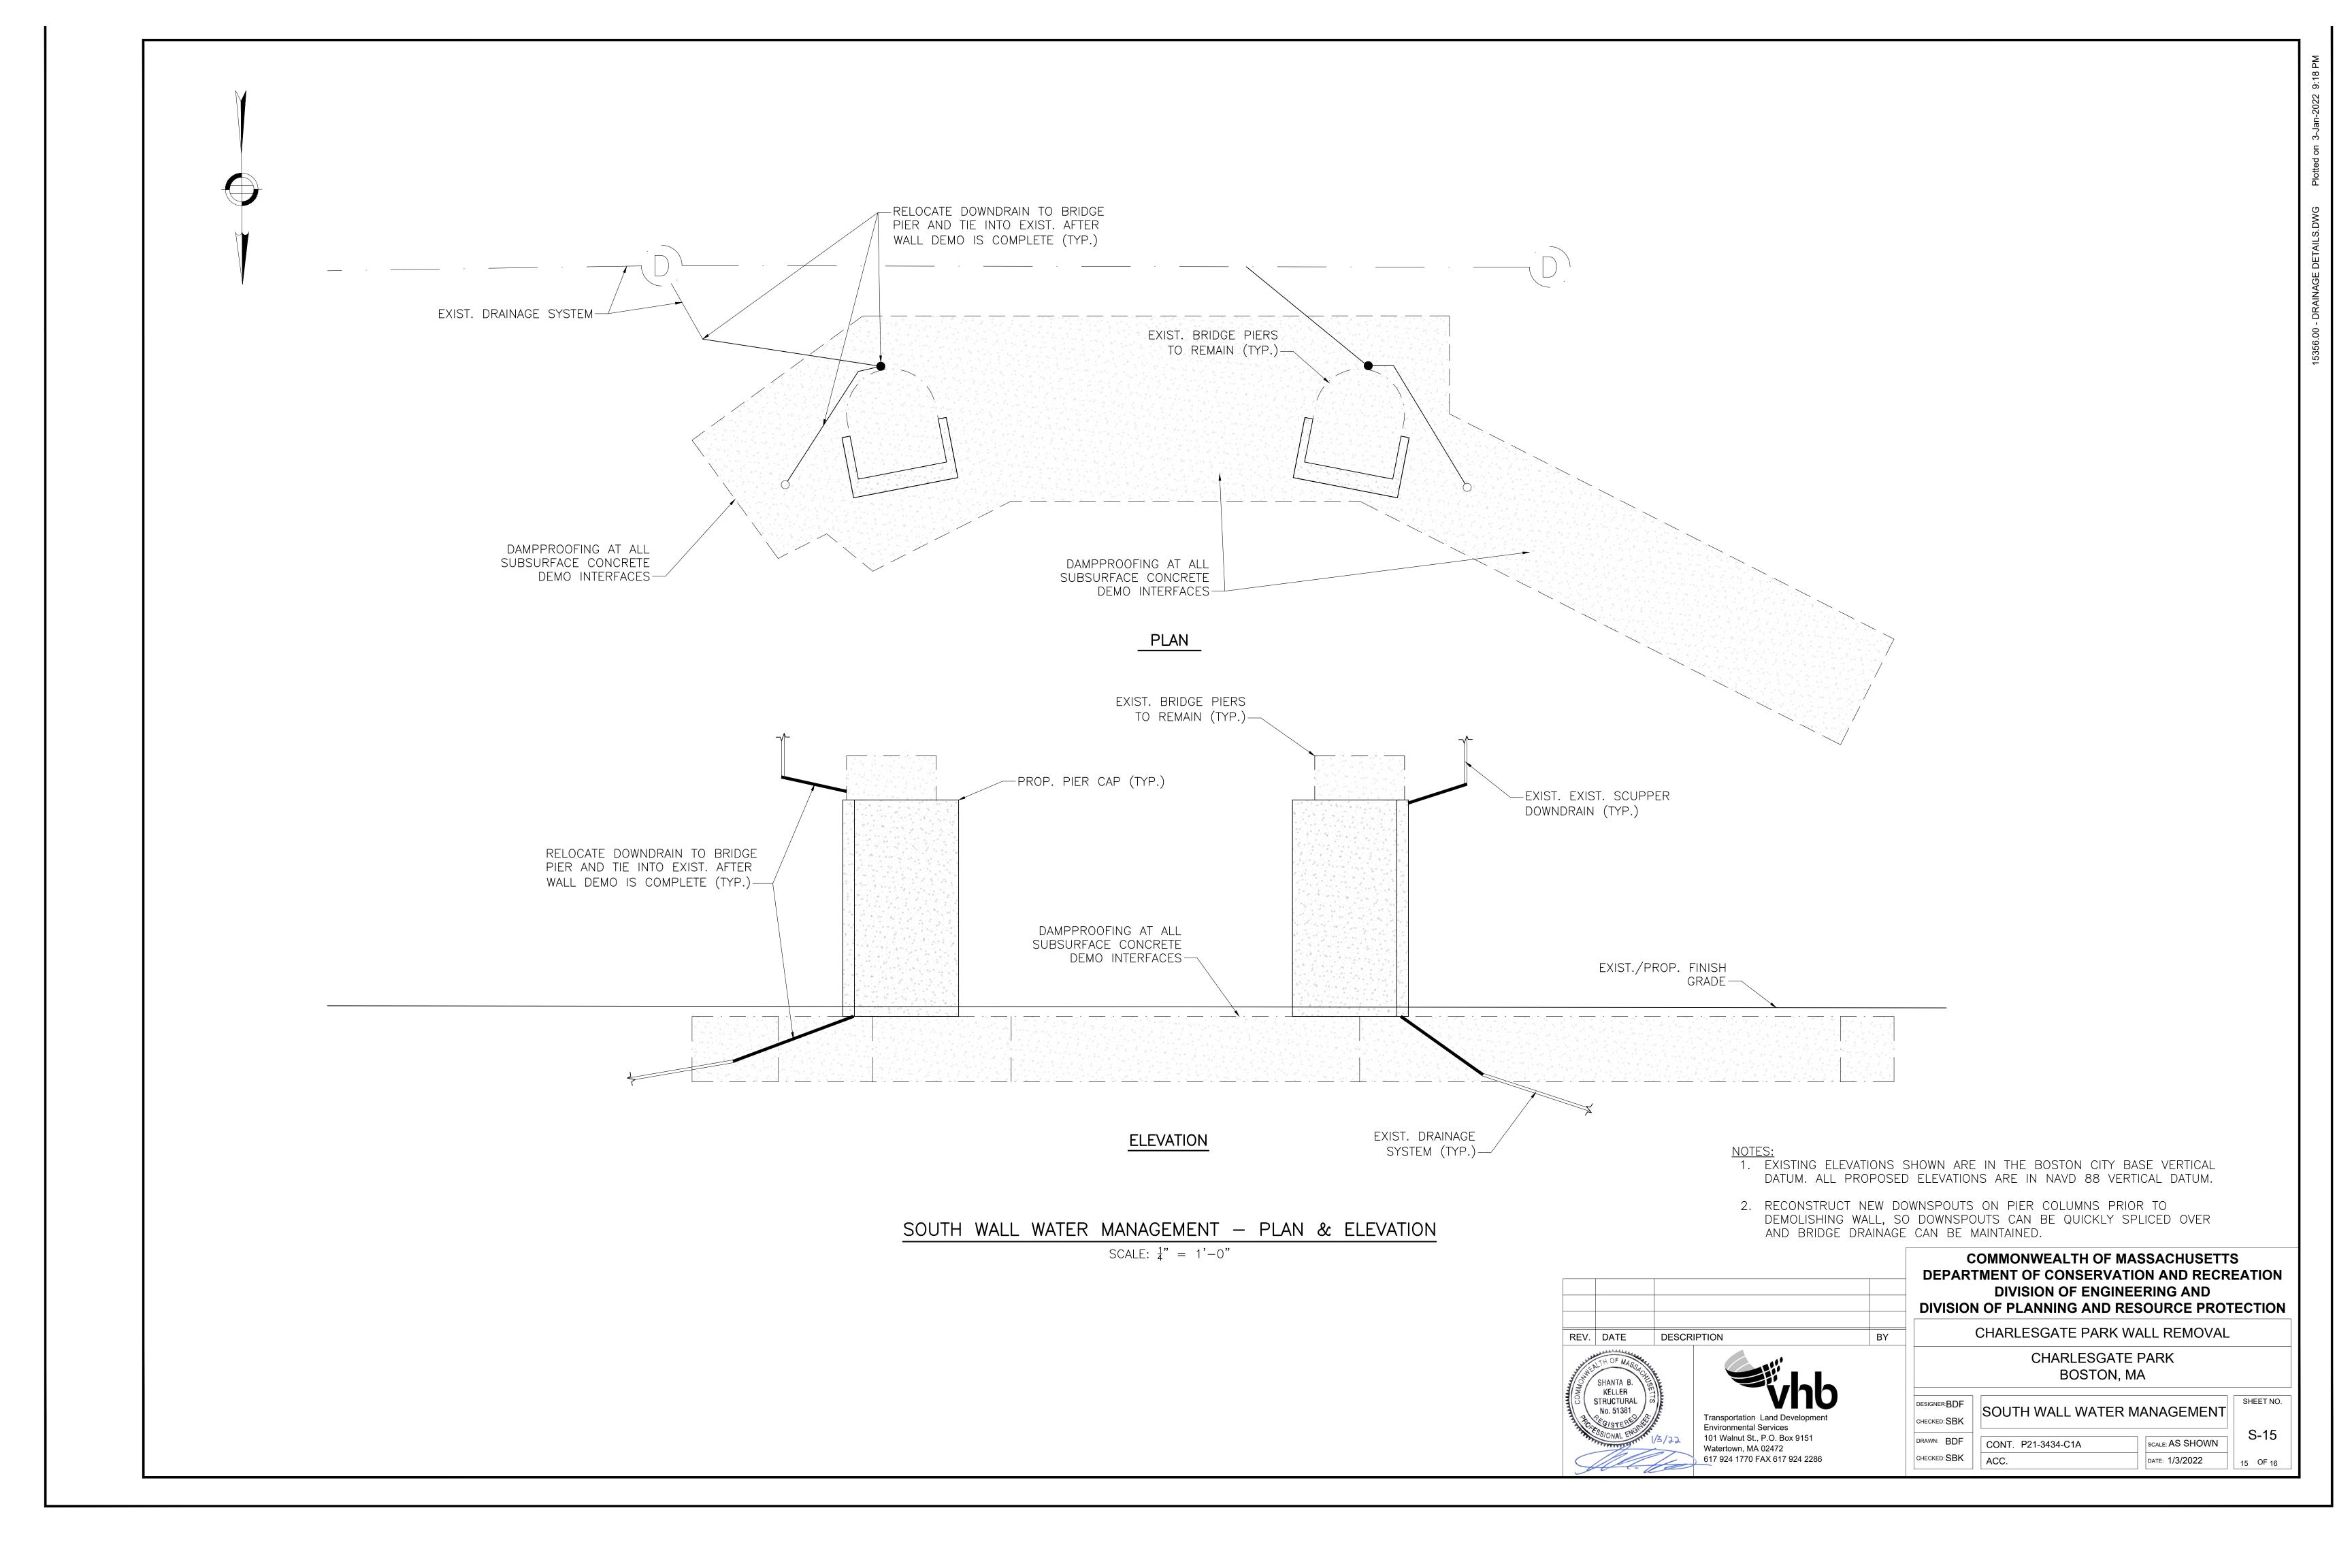

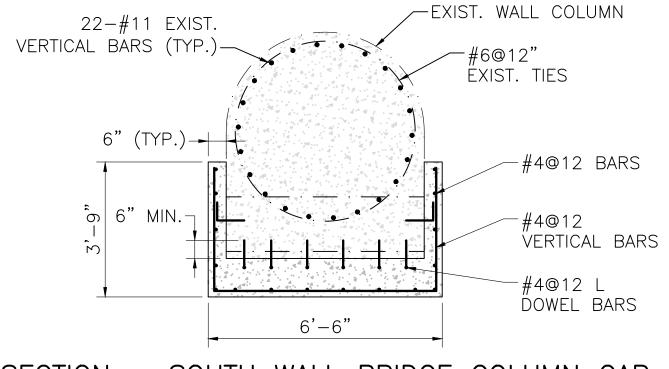


SECTION - SOUTH WALL BRIDGE COLUMN CAP

SCALE: \(\frac{3}{8} \) = 1'-0"

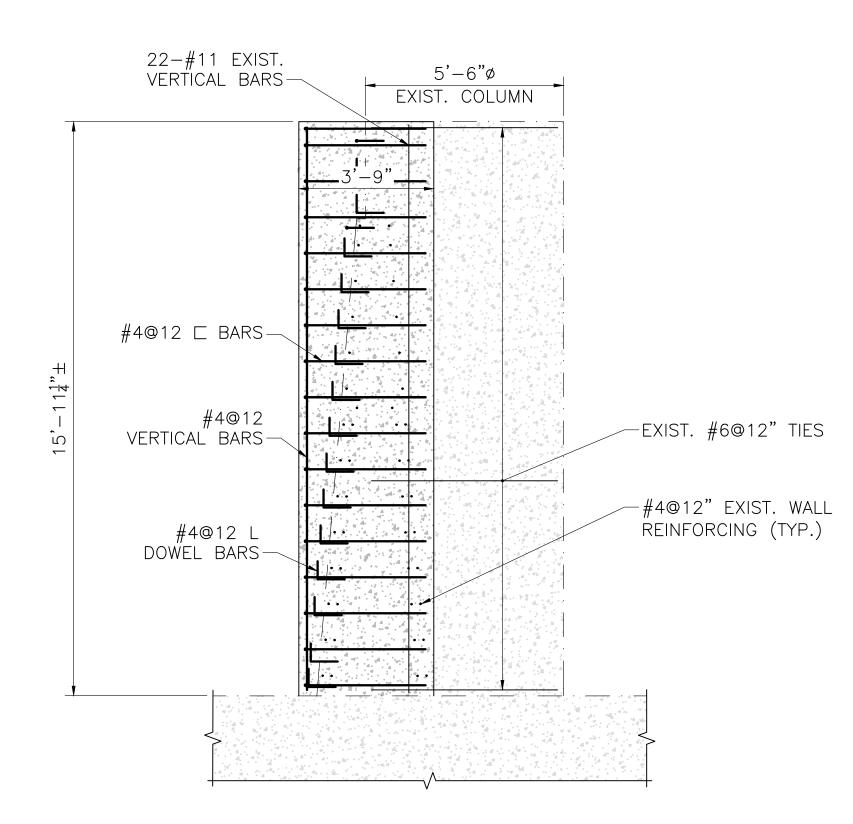

ELEVATION - SOUTH WALL BRIDGE COLUMN CAP

SCALE: \(\frac{3}{8} \) = 1'-0"

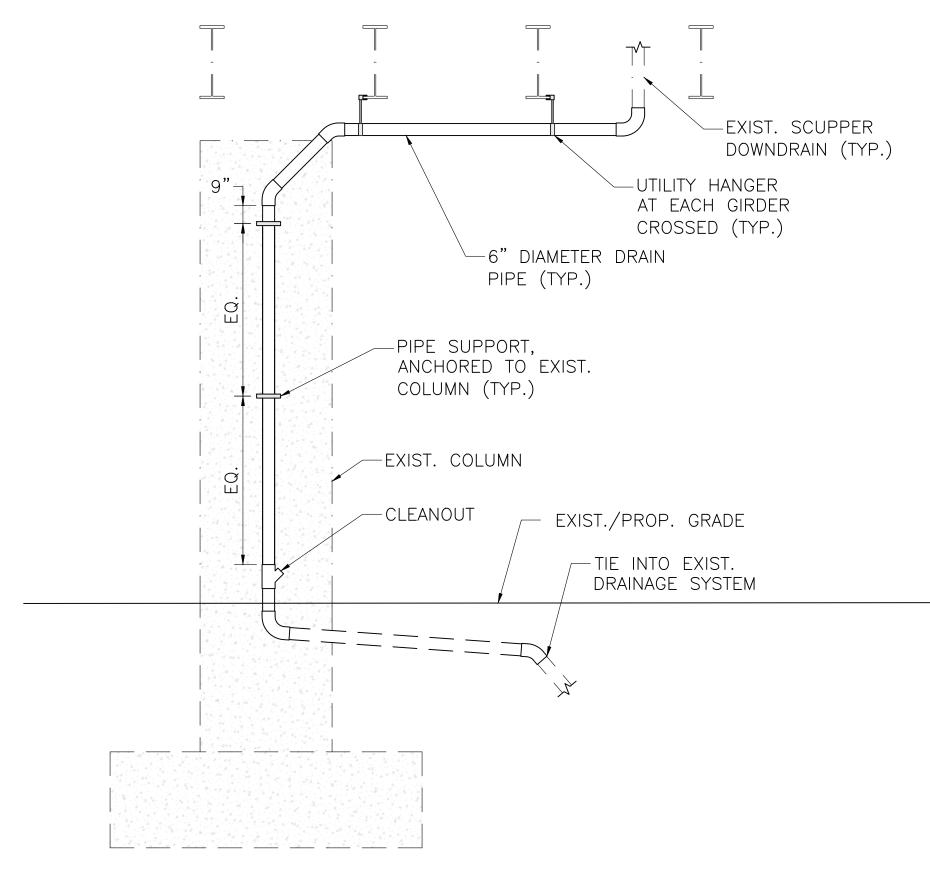

TYPICAL BRIDGE DRAINAGE MODIFICATIONS

SCALE: \(\frac{1}{4}\)" = 1'-0"

NOTES:

- EXISTING DIMENSIONS ARE TAKEN FROM RECORD DRAWINGS AND HAVE NOT BEEN VERIFIED BY SURVEY.
- 2. BRIDGE DRAINAGE MODIFICATIONS SHOWN ARE SCHEMATIC. CONTRACTOR SHALL DESIGN SPECIFIC DETAILS AND SUBMIT FOR REVIEW AND APPROVAL.



COMMONWEALTH OF MASSACHUSETTS
DEPARTMENT OF CONSERVATION AND RECREATION
DIVISION OF ENGINEERING AND
DIVISION OF PLANNING AND RESOURCE PROTECTION

CHARLESGATE PARK WALL REMOVAL

CHARLESGATE PARK BOSTON MA

	BOSTON, MA	4	
DESIGNER:BDF	STRUCTURAL DE	ΤΔΙΙ ς	SHEET NO.
CHECKED: SBK	OTROOTORAL DE	TAILO	S-16
DRAWN: BDF	CONT. P21-3434-C1A	SCALE: AS SHOWN	3-10
CHECKED: SBK	ACC.	DATE: 1/3/2022	16 OF 16