
463 BEACON STREET

BOSTON, MA 02115

JUNE 03, 2020 ISSUED FOR CONSTRUCTION

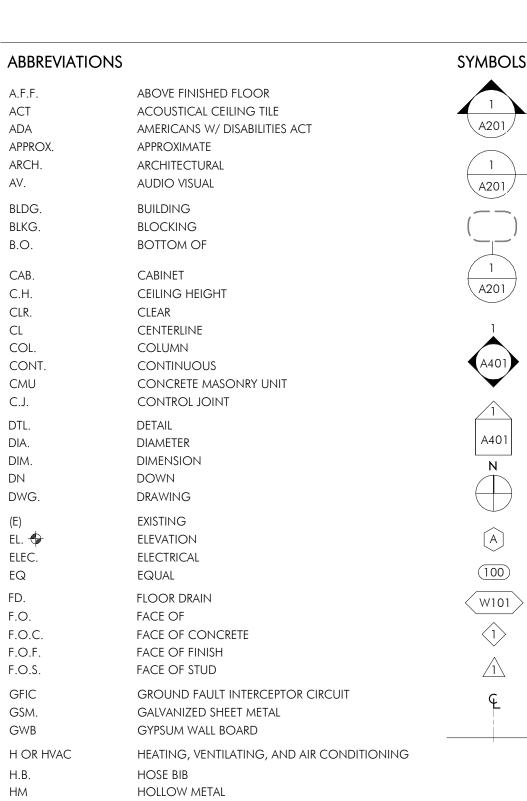

MAXIMUM

MINIMUM

METAL

NUMBER

OVER

MECHANICAL

MISCELLANEOUS

NOT IN CONTRACT

OUTSIDE DIAMETER

NOT TO SCALE

ON CENTER

OPENING

OPPOSITE

PAINT GRADE

PLYWOOD

REQUIRED

SCHEDULE

SQUARE

STEEL

STORAGE

STRUCTURAL

SYMMETRICAL

TONGUE AND GROOVE

UNLESS OTHERWISE NOTED

WATERPROOFING MEMBRANE

TEMPERED

TOP OF

TYPICAL

TUBULAR STEEL

VERIFY IN FIELD

WITHOUT

STAIN GRADE

SPECIFICATION

STAINLESS STEEL

ROUGH OPENING

SEE LANDSCAPE DRAWINGS

SEE STRUCTURAL DRAWINGS

PAINTED ROOF DRAIN

MASONRY OPENING

MECHANICAL ELECTRICAL PLUMBING

M.O.

MECH.

MEP

MISC.

MTL.

N.I.C.

NO.

N.T.S.

O.C.

O.D.

OPNG.

OPP.

P.G.

PLYWD.

PTD.

REQ'D.

SCHED.

R.O.

S.G.

SIM. S.L.D.

SQ.

SPEC.

S.S.D.

SSTL.

STL.

STOR.

SYM.

T&G

THK.

T.O.

T.S.

TYP.

U.O.N

V.I.F.

W/O

WD. WPM.

STRUCT.


GENERAL REQUIREMENTS

- ALL WORK SHALL BE IN COMPLIANCE WITH ALL APPLICABLE LOCALS BUILDING CODES AND REGULATIONS. CONTRACTOR SHALL BE RESPONSIBLE FOR PERMITS APPLICABLE TO SPECIFIC TRADES OR SUBCONTRACTORS.
- CONTRACTOR SHALL EXAMINE THE PREMISES AND SITE SO AS TO COMPARE THEM TO THE CONTRACT DRAWINGS AND WILL BE FAMILIAR WITH THE EXISTING CONDITIONS OF THE BUILDING AND ADJACENT PROPERTY PRIOR TO SUBMISSION OF BID NUMBER. ALLOWANCES ARE TO BE MADE TO INCLUDE ALL ITEMS OF WORK INCLUDING BOTH LABOR OR MATERIALS FOR ALL NOTED, DETAILS, OR IMPLIED ITEMS REQUIRED TO ATTAIN THE COMPLETED CONDITIONS PROPOSED IN THE DRAWINGS AND SPECIFICATIONS.
- ALL SUBCONTRACTORS SHALL INSPECT THE SITE AND CONVEY ANY QUESTIONS REGARDING DESIGN INTENT AND SCOPE OF WORK TO THE GENERAL CONTRACTOR WHO WILL CONVEY THESE TO THE ARCHITECT PRIOR TO SUBMITTING A BID AND PRIOR TO COMMENCING WORK.
- CONTRACTOR SHALL COORDINATE THE WORK OF ALL TRADES AND SUBCONTRACTORS AND SHALL BE RESPONSIBLE FOR ANY ACTS, OMISSIONS, OR ERRORS OF THE SUBCONTRACTORS AND OR PERSON DIRECTLY OR INDIRECTLY EMPLOYED BY THEM.
- CONTRACTOR SHALL ASSUME SOLE RESPONSIBILITY FOR JOB SITE CONDITIONS INCLUDING THE SAFETY OF PERSONS AND PROPERTY FOR THE

DOORS AND WINDOWS. ALL SIDES OF NEW DOORS ARE TO BE WEATHERSTRIPPED INCLUDING THE THRESHOLD.

- CONTRACTOR SHALL CONFORM TO ALL NEIGHBORHOOD ASSOCIATION RULES AND GUIDELINES. CONTRACTOR SHALL NOTIFY ARCHITECT IMMEDIATELY AND PRIOR TO ORDERING OF ALL LONG LEAD TIME ITEMS AND OF APPROXIMATE DELIVERY DATES. ALL CONSTRUCTION MATERIALS AND SUPPLIES ARE TO BE STORED, HANDLED, AND INSTALLED ACCORDING TO MANUFACTURERS' RECOMMENDATIONS. IF ERRORS OR OMISSIONS ARE FOUND IN THE CONTRACT DOCUMENTS, THEY SHALL BE BROUGHT TO THE ATTENTION OF THE ARCHITECT BEFORE
- DRAWINGS SCHEMATICALLY INDICATE NEW CONSTRUCTION. THE CONTRACTOR SHALL ANTICIPATE, BASED ON EXPERIENCE, A REASONABLE NUMBER OF ADJUSTMENTS TO BE NECESSARY TO MEET THE DESIGN OBJECTIVES AND SHOULD CONSIDER SUCH ADJUSTMENTS AS INCLUDED IN THE SCOPE OF
- WHEN SPECIFIC FEATURES OF CONSTRUCTION ARE NOT FULLY SHOWN ON THE DRAWINGS OR CALLED FOR IN THE GENERAL NOTES, THEIR CONSTRUCTION SHALL BE OF THE SAME CHARACTER AS SIMILAR CONDITIONS.
- ALL DIMENSIONS ARE TO BE TAKEN FROM NUMERIC DESIGNATIONS ONLY; DIMENSIONS ARE NOT TO BE SCALED OFF OF THE DRAWINGS. THESE NOTES ARE TO APPLY TO ALL DRAWINGS AND GOVERN UNLESS MORE SPECIFIC REQUIREMENTS ARE INDICATED THAT ARE APPLICABLE TO PARTICULAR DIVISIONS OF THE WORK. SEE SPECIFICATIONS AND GENERAL NOTES IN THE INDIVIDUAL SUBSECTIONS OF CONTRACT DOCUMENTS FOR PROVIDE WEATHERSTRIPPING AT ALL DOORS LEADING FROM HEATED TO UNHEATED AREAS. PROVIDE VINYL BEAD TYPE WEATHERSTRIPPING AT THESE

DESIGN IS BASED ON THE INTERNATIONAL BUILDING CODE (IBC) 2015, THE INTERNATIONAL ENERGY CONSERVATION CODE (IECC) 2015, AND THE MASSACHUSETTS BUILDING CODE 2015 AMENDMENTS. CONSTRUCTION SHALL CONFORM WITH ALL APPLICABLE SECTIONS.

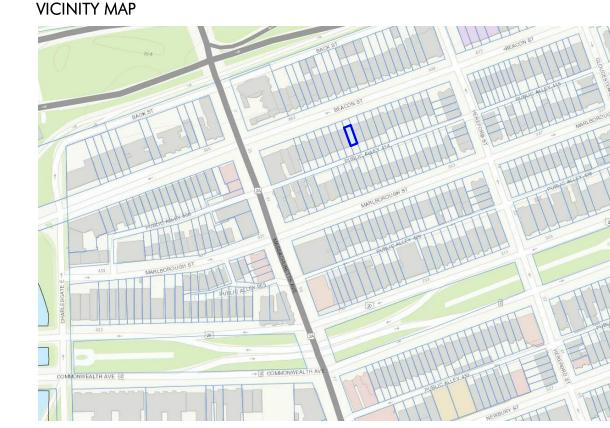



S2.1 SECTIONS AND DETAILS II FIRE PROTECTION FIRE PROTECTION DETAILS - FP FLOOR PLAN FIRE PROTECTION DETAILS - INFO SHEET

SECTIONS AND DETAILS I

S2.0

REFERENCE NUMBER

REFERENCE NUMBER

REFERENCE NUMBER

REFERENCE NUMBER

REFERENCE NUMBER

EXTERIOR ELEVATION

DRAWING SHEET

DRAWING SHEET

NORTH ARROW

WINDOW TAG

WALL TYPE TAG

APPLIANCE TAG

CENTER LINE

EXIT 1

HVAC

GARDEN LEVEL

DOOR TAG

INTERIOR ELEVATION


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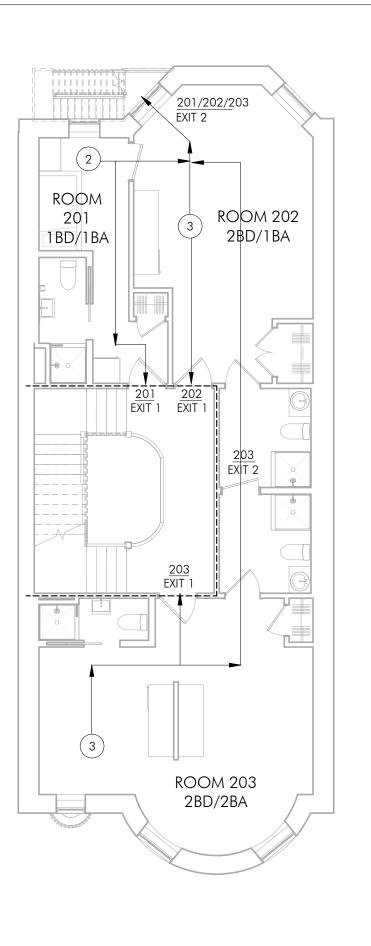
DRAWING SHEET

DRAWING SHEET


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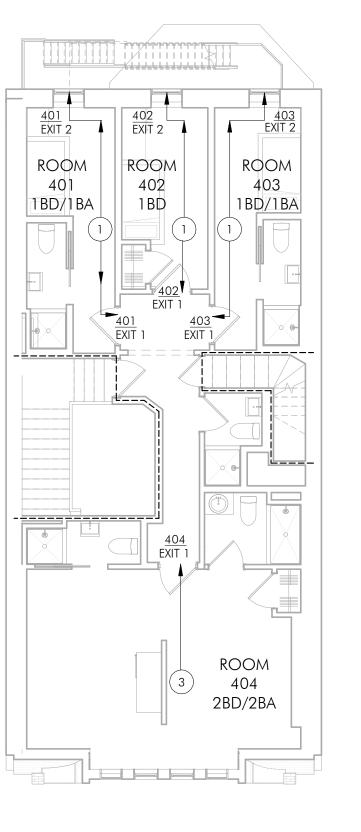
BUILDING SECTION




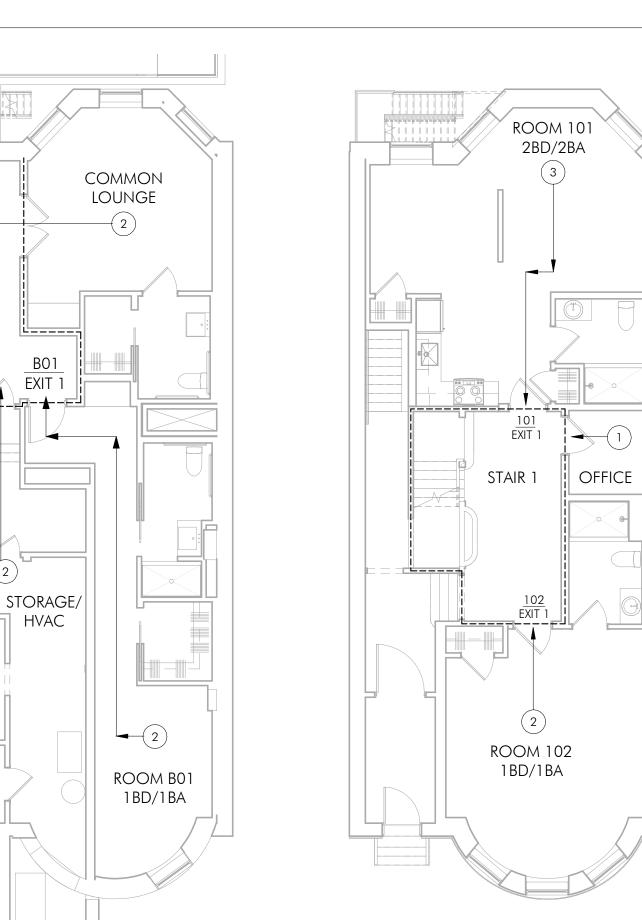

SECOND FLOOR



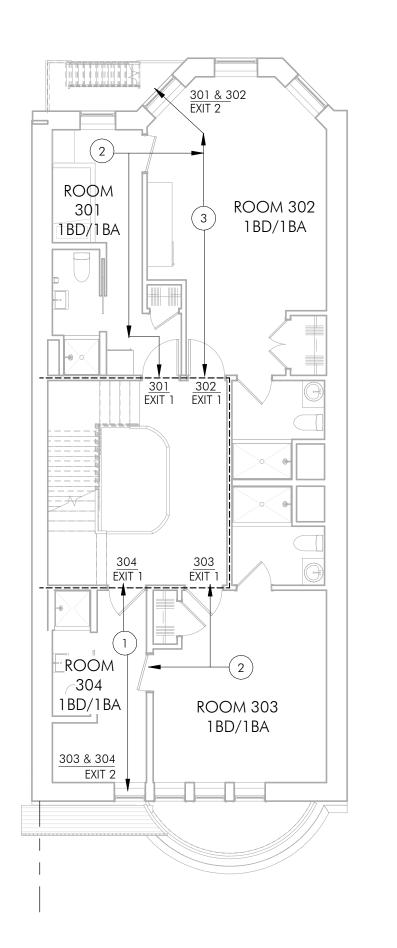

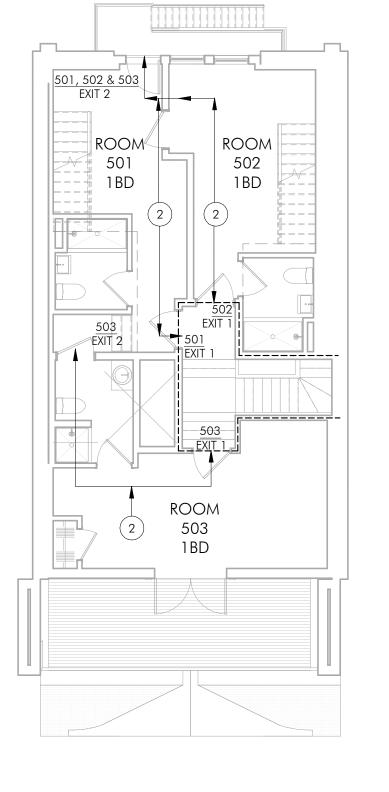

ARCHITECT BOSTON, MA 02127 O: 617.766.8330

www.embarcstudio.com OWNER

FOUR 63 BEACON LLC 301 SOUTH AVE WESTON MA 02493

CONSULTANTS

STONEHAM, MA 02180

RJ O'CONNELL & ASSOC. 80 montvale avenue ste. 201

STRUCTURAL ENGINEER H+O STRUCTURAL ENG. 51 MELCHER ST, FLR 1

FIRE PROTECTION PLS INC.

BOSTON, MA 02210

23 SAGAMORE LN. BOXFORD, MA 01921

CIVIL ENGINEER COLUMBIA DESIGN GROUP 14 UPHAM AVENUE

NSTRUC Δ \Box Ш 9 S

REVISIONS

MARK ISSUE



DRAWING INFORMATION

ISSUED FOR CONSTRUCTION JUNE 03, 2020 PROJECT #: 19054

DRAWING TITLE COVER

DRAWING NUMBER

PARLOR LEVEL

THIRD FLOOR

FOURTH FLOOR

FIFTH FLOOR



(NOT ALL SYMBOLS SHOWN IN THE LEGEND BELOW WILL BE DEPICTED ON THE FACE OF THE PLAN)

		PROPERTY LIN	E
		ABUTTING PRO	PERTY LINE
		EASEMENT LINE	E
	Ohw	OVERHEAD WIR	RES
X—	X X	CHAIN LINK FE	ENCE
~UP	UTILITY POLE	CC	CONCRETE CURB
₩ LP	LIGHT POLE	VGC	VERTICAL GRANITE CURB
	ELECTRIC HAND HOLE	BCB	BITUMINOUS CONC. CURB
©	CABLE MANHOLE	HC	HANDICAP
S	SEWER MANHOLE	HPDE	HIGH DENSITY POLYETHYLENE
0	DRAIN MANHOLE	CONC.	CONCRETE
(B)	CATCH BASIN	LSA	LANDSCAPE AREA
H	WATER VALVE		DOOR
\forall	FIRE HYDRANT	þ	SIGN
O SPR	SPRINKLER CONNECTION	(8)/(8C)	PARKING COUNT/COMPACT
O PIV	POST INDICATOR VALVE	~~~~	NUMBER
•	BOLLARD	(+ ;	DECIDUOUS TREE
⊓ <i>GM</i>	GAS METER	4 We 6	
\bowtie	GAS VALVE	A CE	CONIFEROUS TREE
\square RD	ROOF DRAIN		
O AD	AREA DRAIN		

NOTES

- 1. UNDERGROUND UTILITIES SHOWN ARE NOT SHOWN. BEFORE CONSTRUCTION CALL "DIG SAFE" 811.
- 2. THIS PLAN WAS PREPARED FROM AN ACTUAL SURVEY MADE ON THE GROUND USING TOTAL STATION METHODS ON 12/23/2019.
- 3. THE HORIZONTAL DATUM IS NAD83 THE VERTICAL DATUM IS BOSTON CITY BASE DATUM WAS ESTABLISHED USING RTK GPS METHODS.
- 4. THE POSITIONAL ACCURACY OF THE DATA AND PHYSICAL IMPROVEMENTS ON THIS PLAN MAY BE APPROXIMATE. ANY USE OF ELECTRONIC DATA CONTAINED IN AUTOCAD VERSIONS OF THIS PLAN TO GENERATE COORDINATES OR DIMENSIONS NOT SHOWN ON THE PLAN IS NOT

PLAN REFERENCES

- 1. CITY OF BOSTON LAYOUT PLAN L-2953
- 2. CITY OF BOSTON LAYOUT PLAN L-2760
- 3. CITY OF BOSTON LAYOUT PLAN L-1052



301 SOUTH AVENUE WESTON, MA 02493 BK 49193 / PG 261 PARCEL ID: 0503653000 **463 BEACON STREET** BOSTON, MA

RJO'CONNELL

& ASSOCIATES, INC.

CIVIL ENGINEERS, SURVEYORS & LAND PLANNERS

80 MONTVALE AVENUE, SUITE 201 STONEHAM, MA 02180
PHONE: 781.279.0180 RJOCONNELL.COM


Record Owner: **463 BEACON LLC**

FIRST CAMBRIDGE CAPITAL

6 BENNETT STREET CAMBRIDGE, MA 02138

463 BEACON STREET

BOSTON, MA

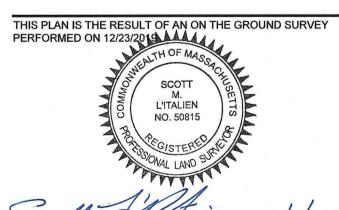

PROFESSIONAL LAND SURVEYOR FOR RJO'CONNELL & ASSOCIATES, INC DRAWN BY:

REVIEWED BY: FIELD CREW: FIELD BOOK: FIELD BOOK 36 / PG 52 01/06/2020 DATE:

DRAWING NAME: **EXISTING**

CONDITIONS PLAN

EX-1


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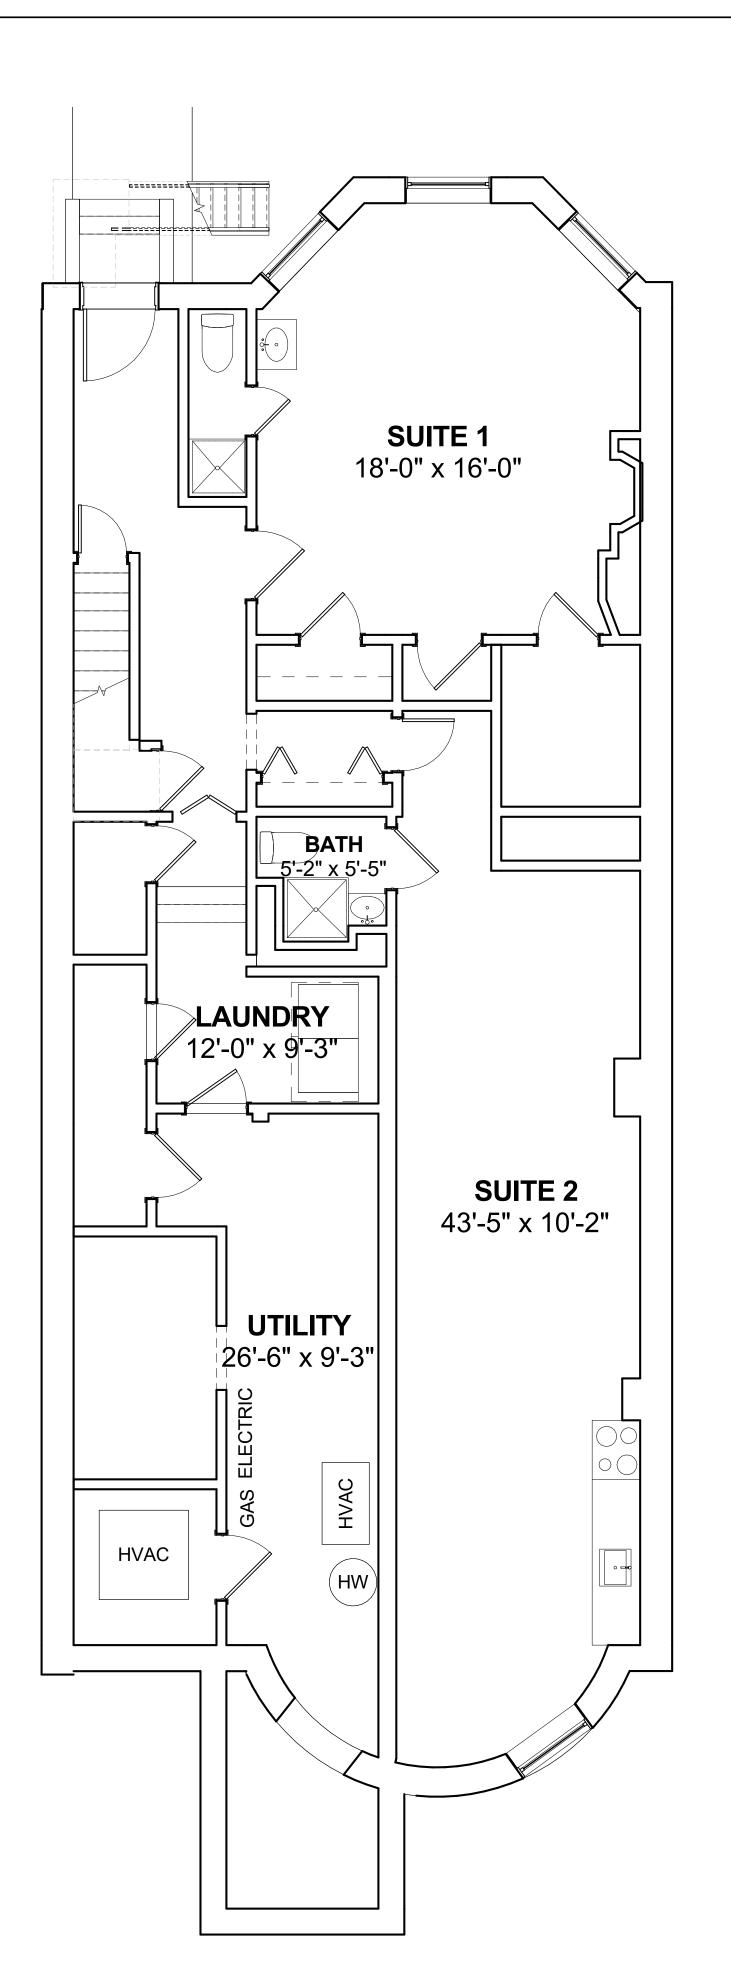
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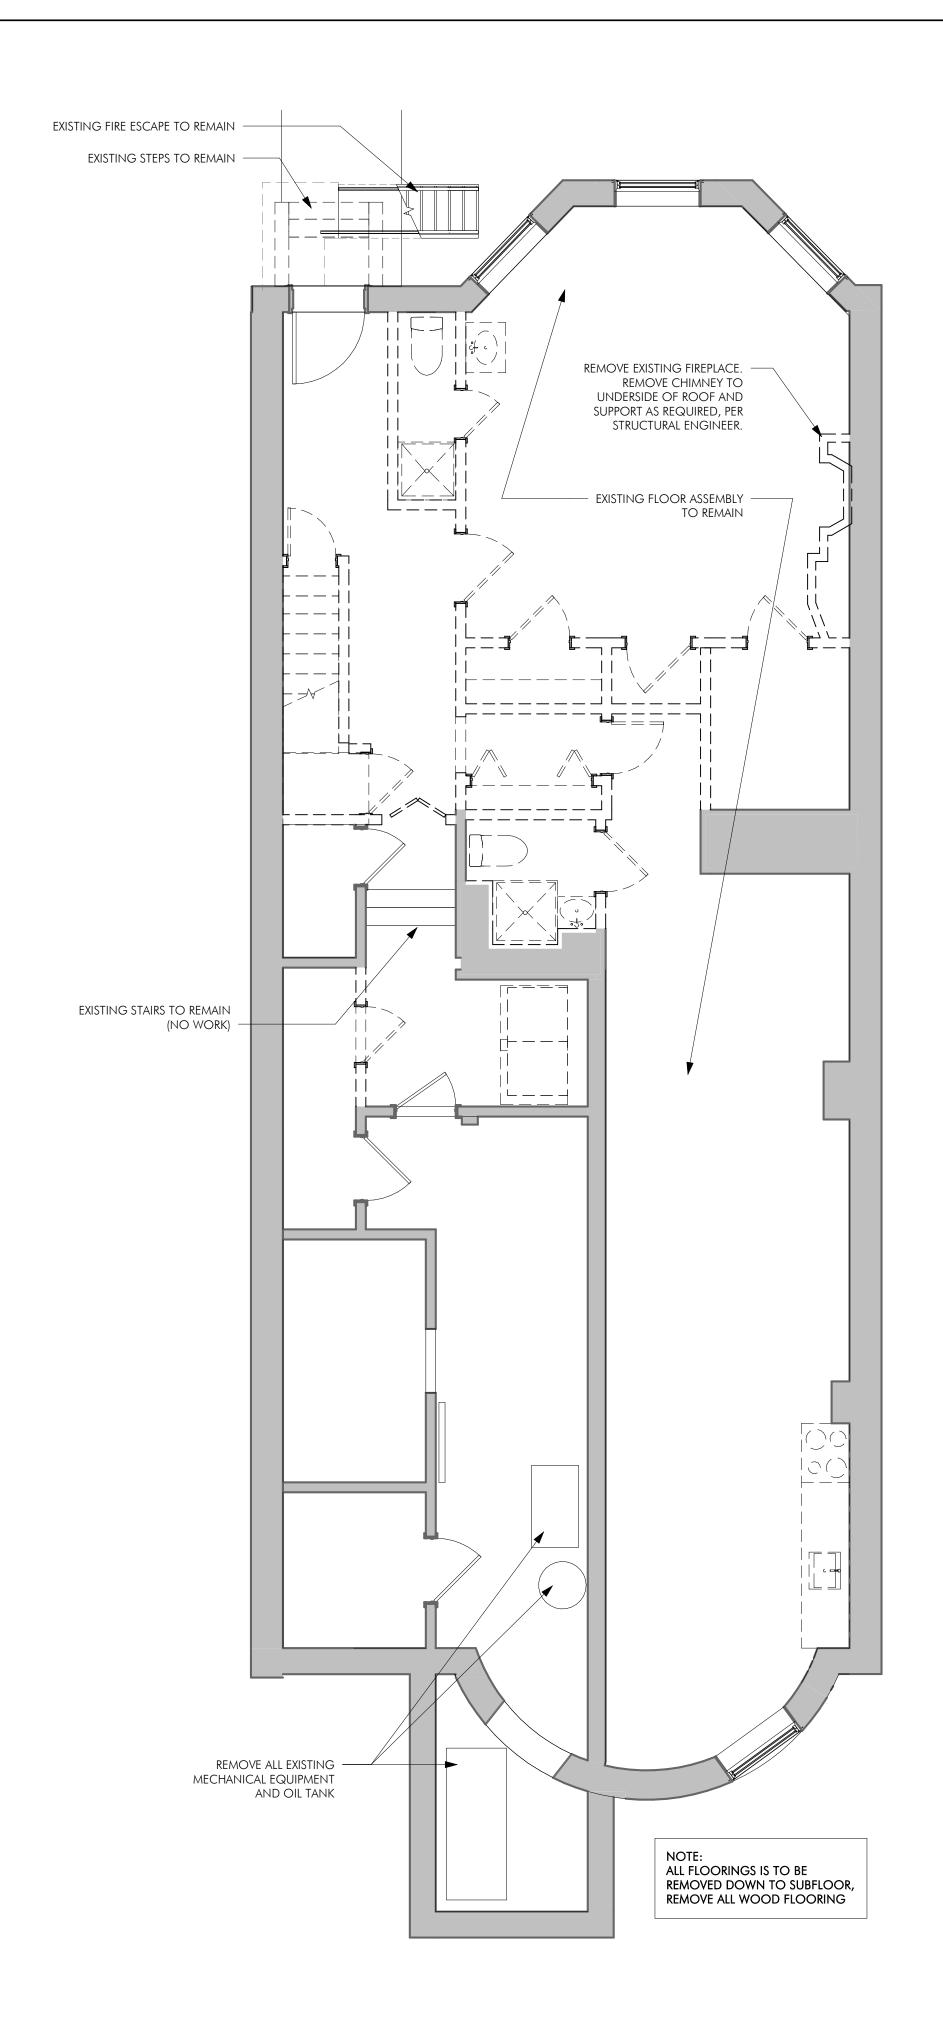
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DIG SAFE BEFORE YOU DIG **CALL 811**

GRAPHIC SCALE IN FEET







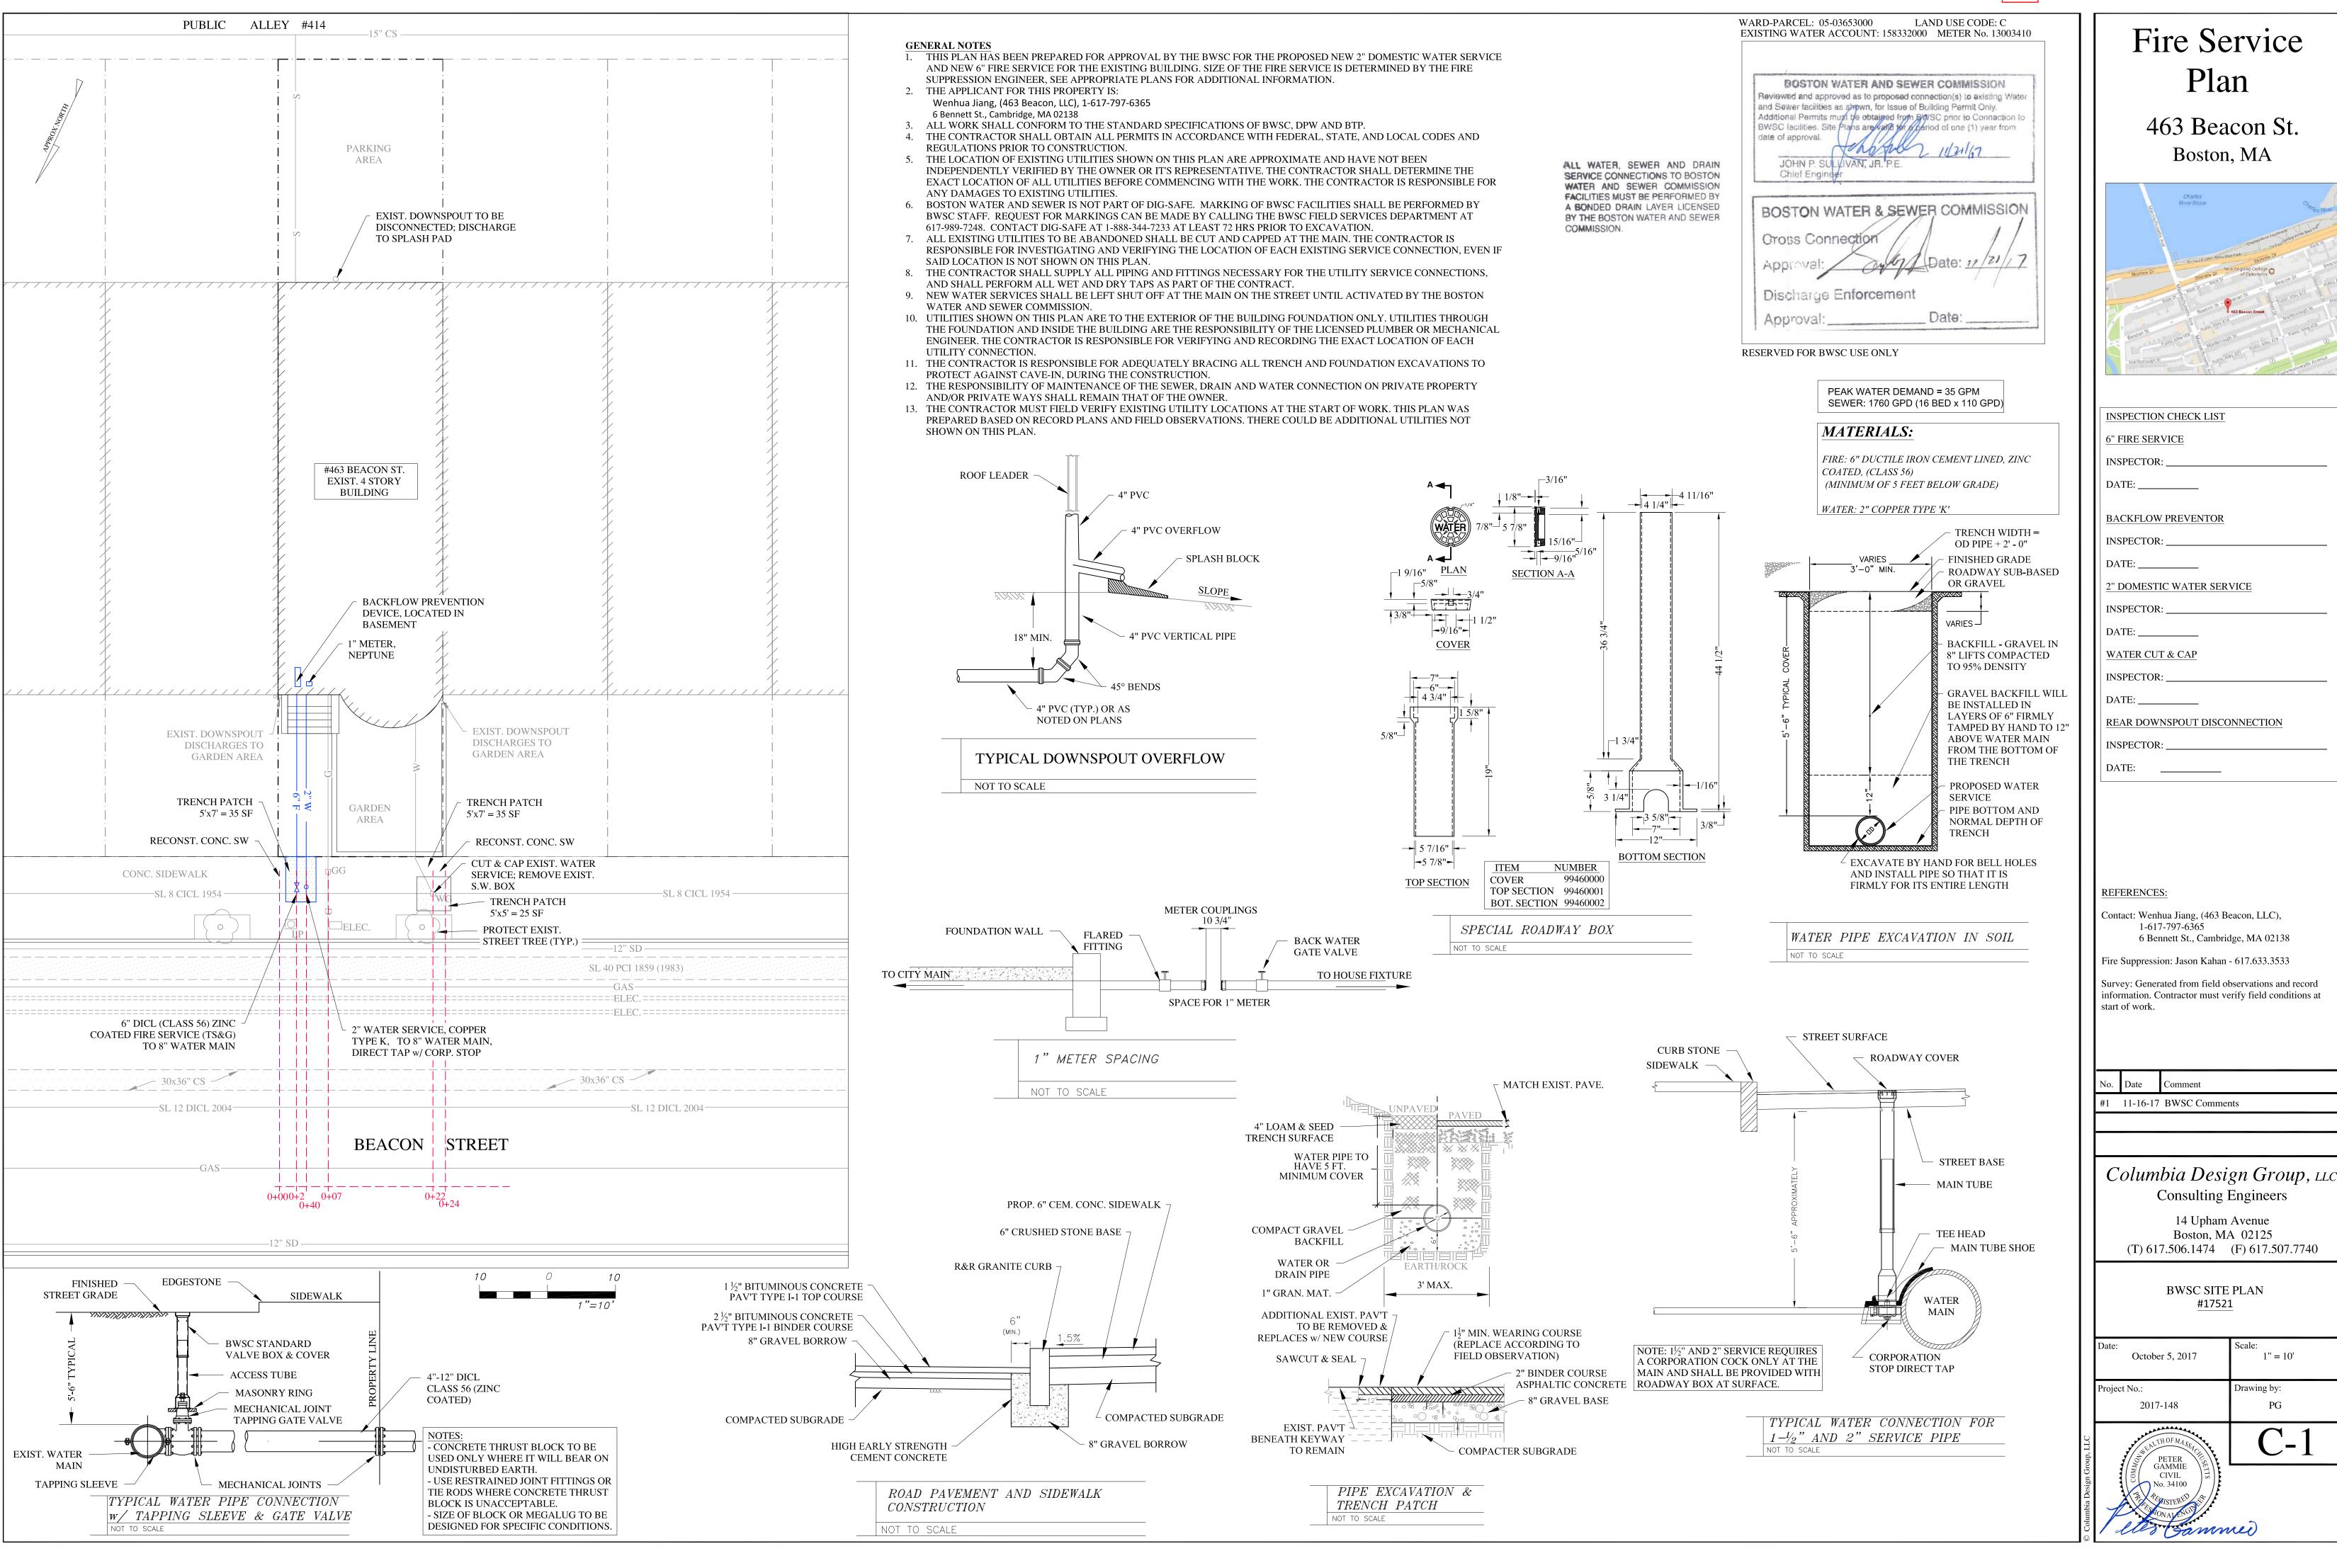

DEMOLITION PLAN LEGEND

EXISTING WALL TO REMAIN

DEMOLISHED BUILDING ELEMENT



AREA NOT IN CONTRACT

GENERAL DEMOLITION NOTES

- 1. ALL DEMOLITION WORK IS TO BE CONDUCTED In Such a manner as to protect remaining ELEMENTS. REMAINING ELEMENTS ARE TO BE PROTECTED AS REQUIRED.
- 2. ALL EXISTING EXTERIOR WALLS ARE TO REMAIN UNLESS OTHERWISE NOTED.
- 3. ALL EXISTING DOORS AND WINDOWS ARE TO BE removed unless otherwise noted.
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- 7. ALL ELECTRICAL OUTLETS, SWITCHES, AND DEVICES ARE TO BE REMOVED.
- 8. CONTRACTOR IS TO VERIFY BEARING AND NON-BEARING STATUS OF EXISTING CONSTRUCTION TO BE DEMOLISHED BEFORE PROCEEDING WITH

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BOSTON, MA 02127

OWNER

FOUR 63 BEACON LLC 301 SOUTH AVE WESTON MA 02493

CONSULTANTS

SURVEYOR

rj o'connell & assoc. 80 MONTVALE AVENUE STE. 201 STONEHAM, MA 02180

STRUCTURAL ENGINEER H+O STRUCTURAL ENG. 51 MELCHER ST, FLR 1 BOSTON, MA 02210

FIRE PROTECTION

PLS INC.

23 SAGAMORE LN. BOXFORD, MA 01921

CIVIL ENGINEER COLUMBIA DESIGN GROUP 14 UPHAM AVENUE BOSTON, MA 02125

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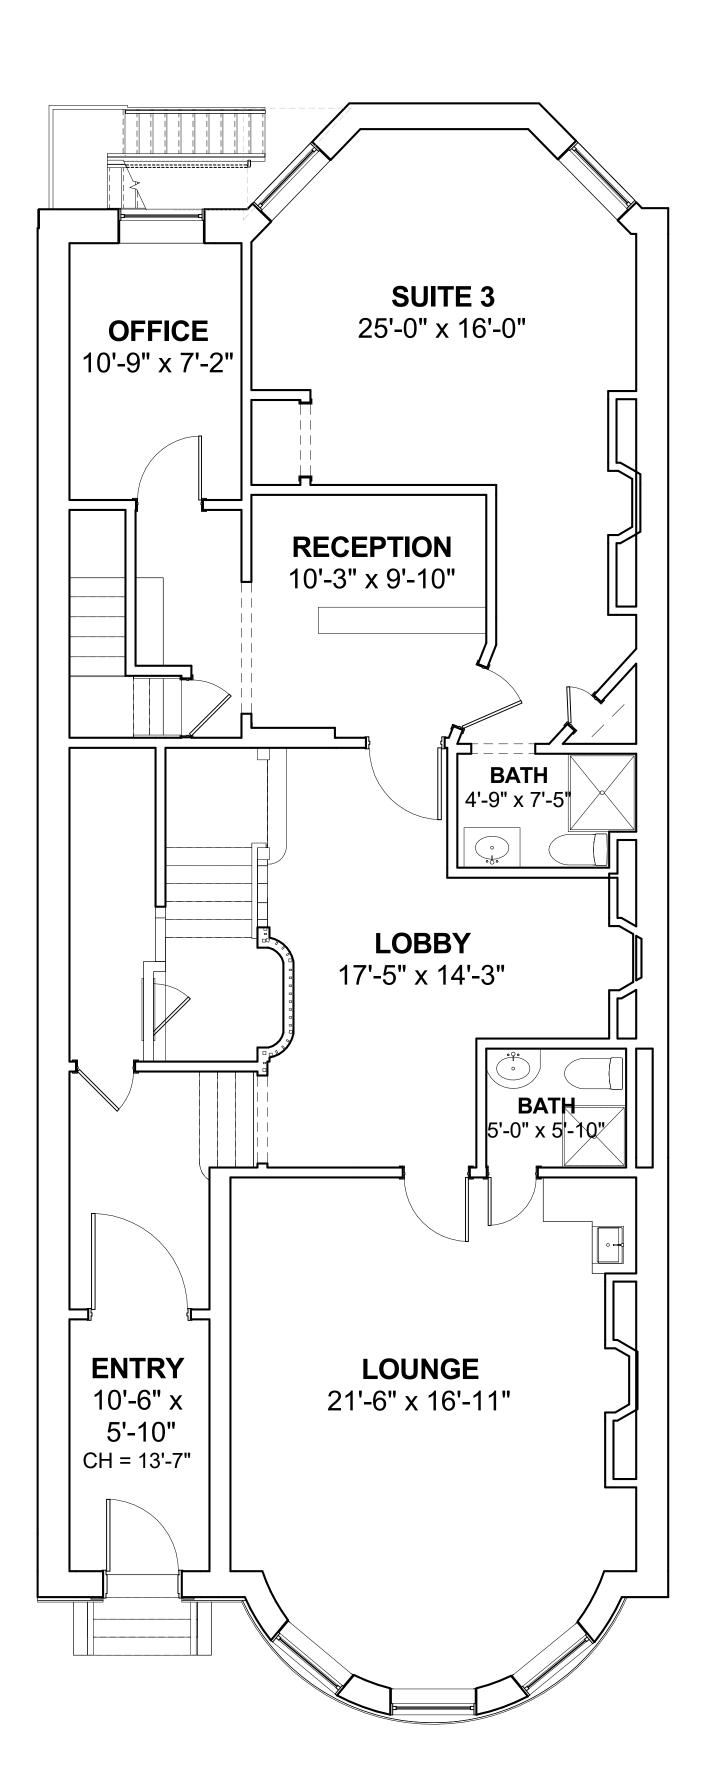



DRAWING INFORMATION

ISSUED FOR CONSTRUCTION

PROJECT #: 19054 1/4" = 1'-0"

DRAWING TITLE DEMOLITION PLANS



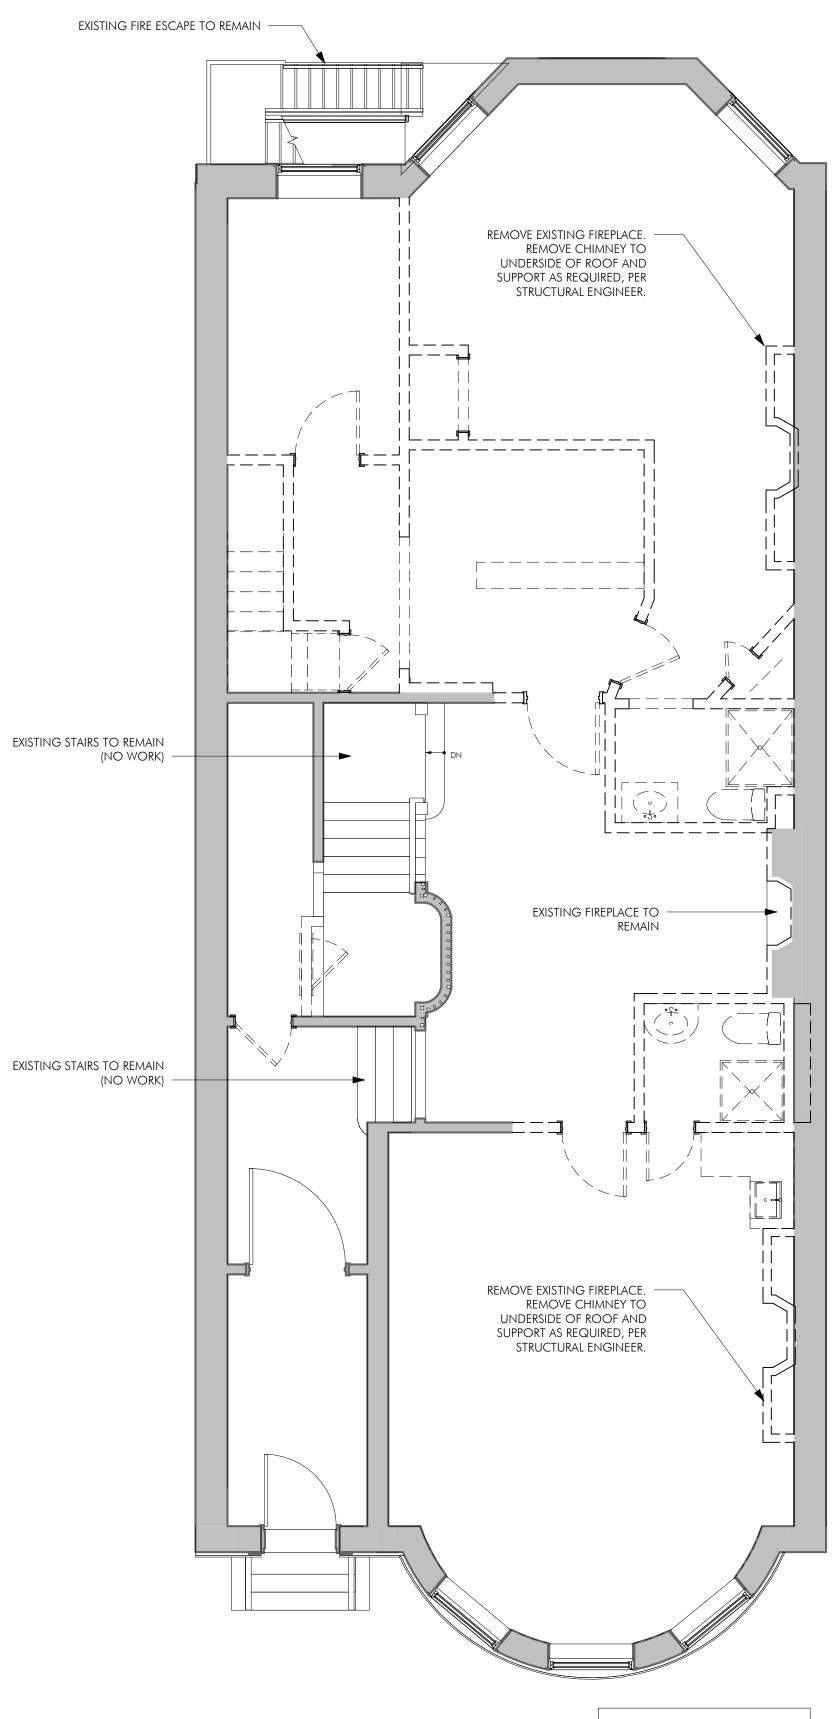

NOTE:
ALL FLOORINGS IS TO BE
REMOVED DOWN TO SUBFLOOR,
REMOVE ALL WOOD FLOORING

FIRST FLOOR DEMOLITION PLAN

1/4" = 1'-0"



EXISTING WALL TO REMAIN

60 K STREET, 3RD FLOOR BOSTON, MA 02127 O: 617.766.8330 DEMOLISHED BUILDING ELEMENT



OWNER AREA NOT IN CONTRACT FOUR 63 BEACON LLC

GENERAL DEMOLITION NOTES

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SURVEYOR

CONSULTANTS

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STRUCTURAL ENGINEER H+O STRUCTURAL ENG.

51 MELCHER ST, FLR 1 BOSTON, MA 02210

FIRE PROTECTION PLS INC. 23 Sagamore ln.

BOXFORD, MA 01921

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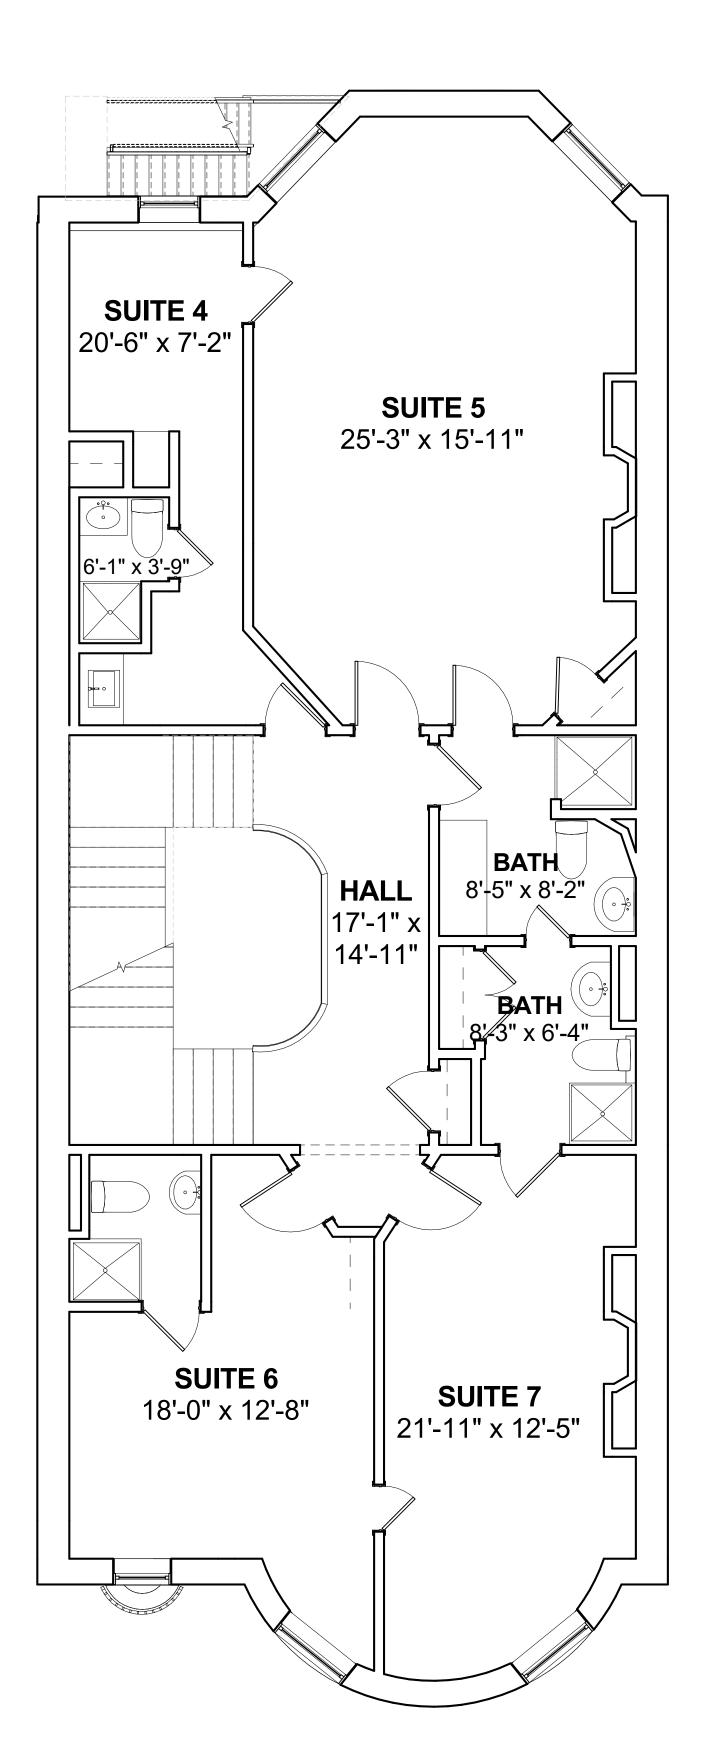
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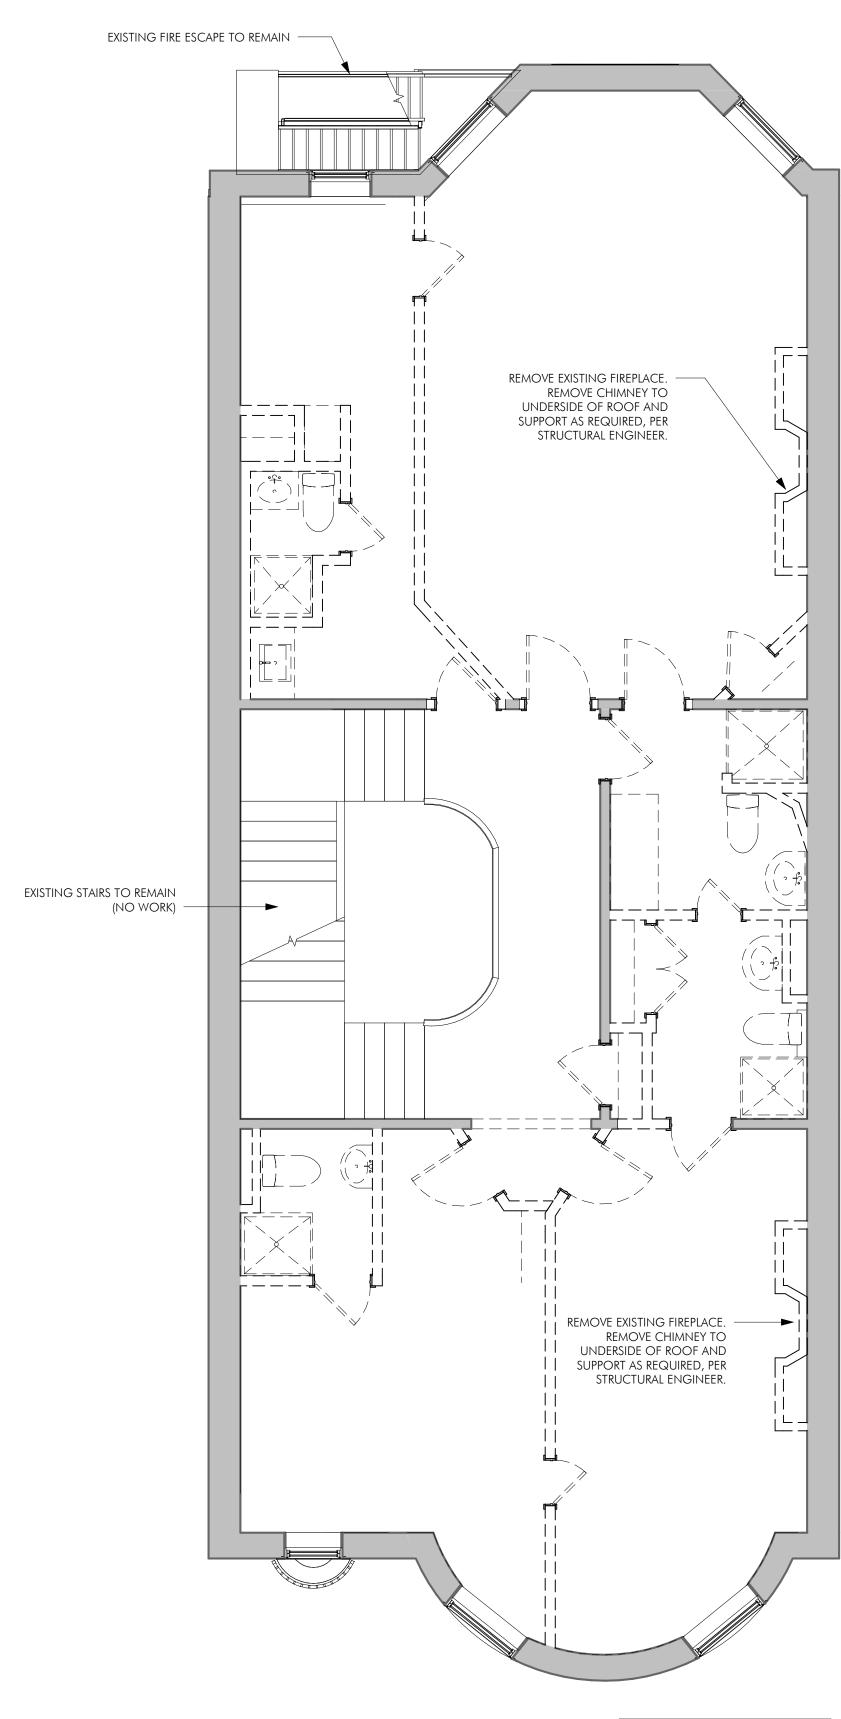
PROJECT #: 19054 1/4" = 1'-0"

DRAWING TITLE DEMOLITION PLANS

DRAWING NUMBER

FIRST FLOOR EXISTING PLAN
1/4" = 1'-0"





NOTE:
ALL FLOORINGS IS TO BE
REMOVED DOWN TO SUBFLOOR,
REMOVE ALL WOOD FLOORING

1 SECOND FLOOR DEMOLITION PLAN



EXISTING WALL TO REMAIN

DEMOLISHED BUILDING ELEMENT



AREA NOT IN CONTRACT

GENERAL DEMOLITION NOTES

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BOSTON, MA 02127 O: 617.766.8330 www.embarcstudio.com

FOUR 63 BEACON LLC 301 SOUTH AVE WESTON MA 02493

CONSULTANTS

OWNER

SURVEYOR

rj o'connell & assoc. 80 MONTVALE AVENUE STE. 201 STONEHAM, MA 02180

STRUCTURAL ENGINEER H+O STRUCTURAL ENG. 51 MELCHER ST, FLR 1 BOSTON, MA 02210

FIRE PROTECTION

PLS INC.

23 SAGAMORE LN. BOXFORD, MA 01921

CIVIL ENGINEER

COLUMBIA DESIGN GROUP 14 UPHAM AVENUE BOSTON, MA 02125

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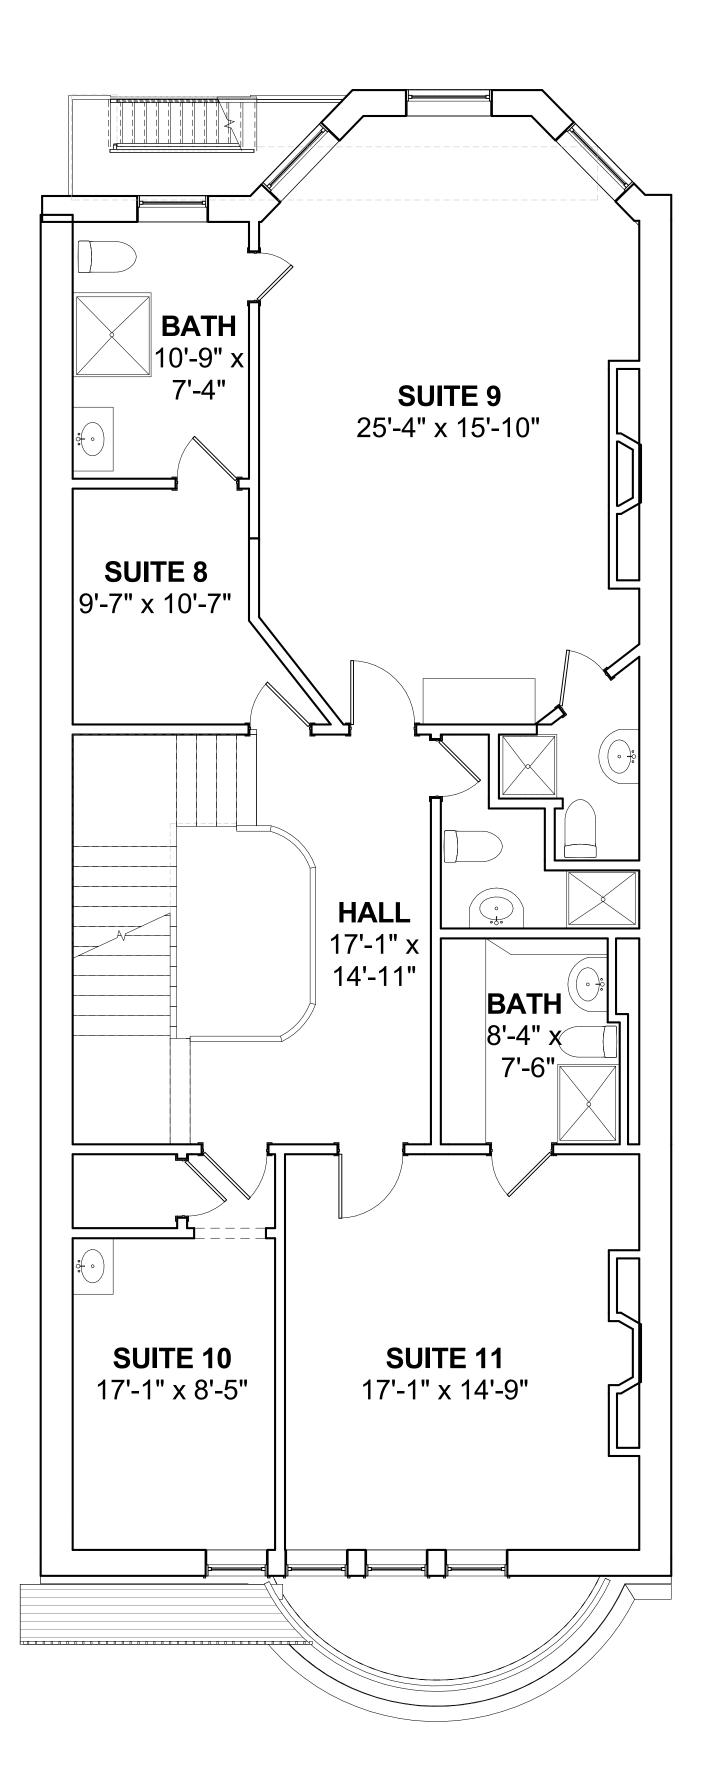
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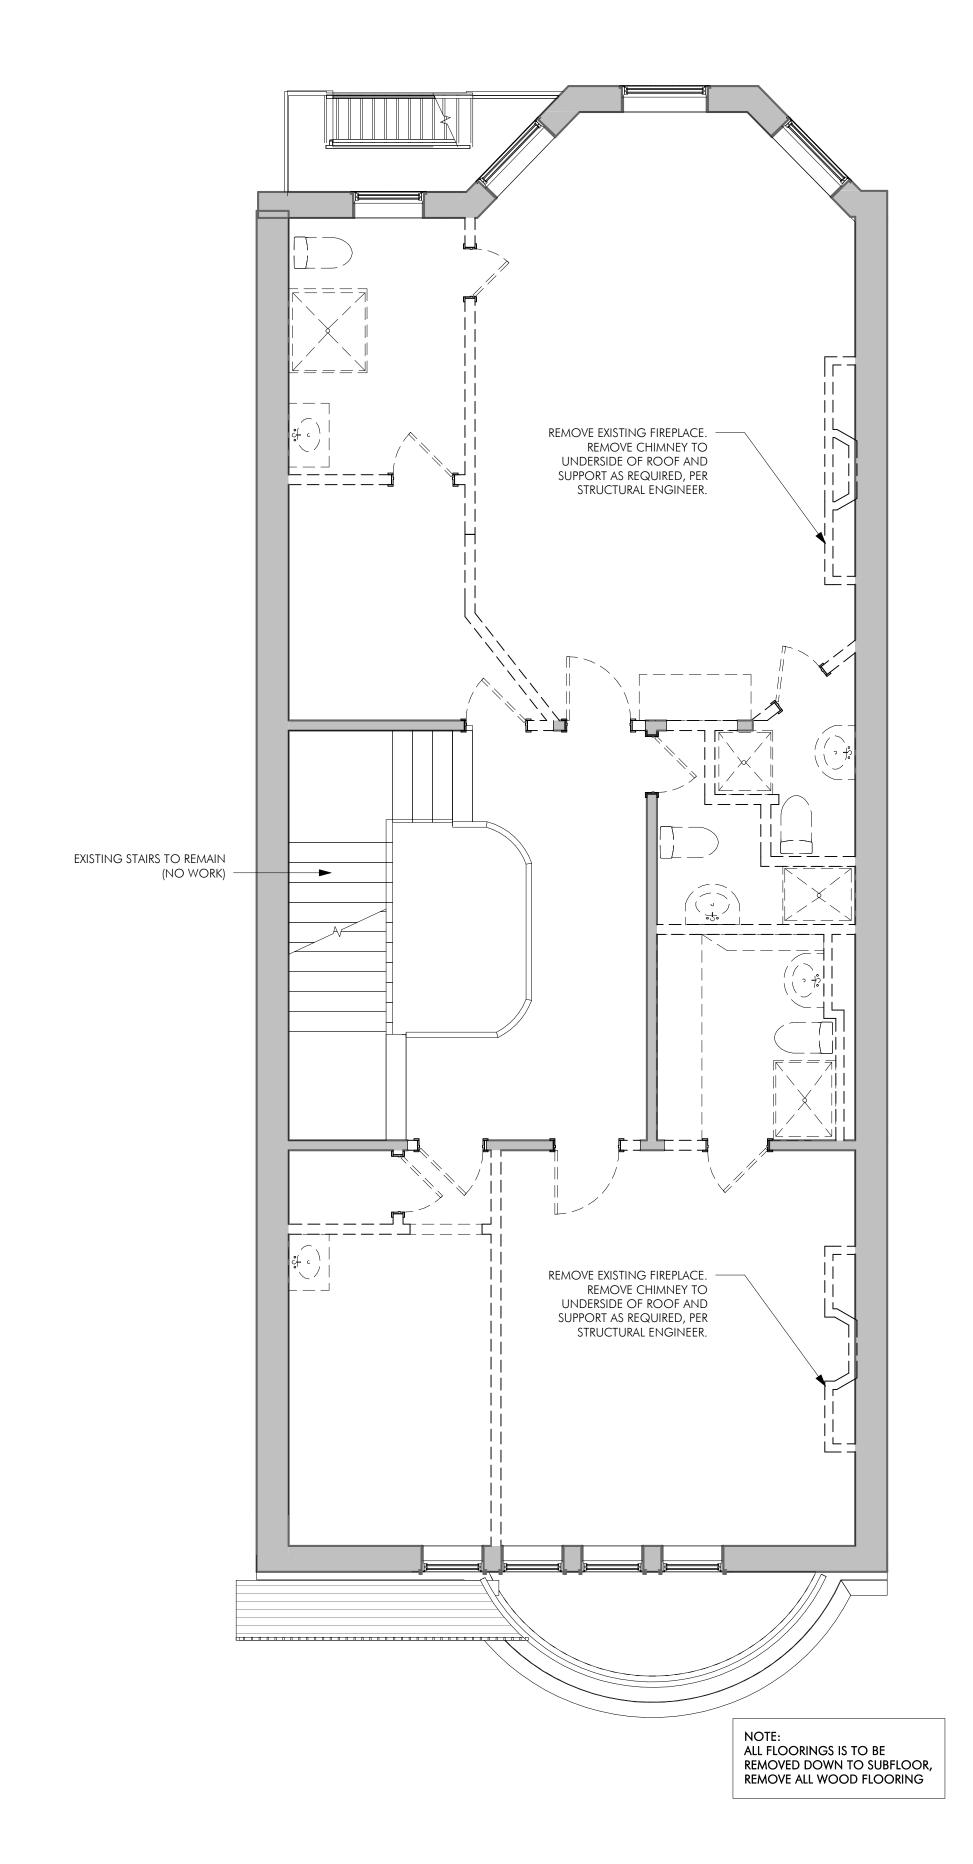
PROJECT #: 19054

DRAWING TITLE DEMOLITION

1/4" = 1'-0"

PLANS





THIRD FLOOR DEMOLITION PLAN

1/4" = 1'-0"



EXISTING WALL TO REMAIN

DEMOLISHED BUILDING ELEMENT

AREA NOT IN CONTRACT

60 K STREET, 3RD FLOOR

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STRUCTURAL ENGINEER H+O STRUCTURAL ENG.

4. ALL FLOORING NOTED AS DEMOLISHED REFERS

THE REMOVAL OF THE DOOR, HARDWARE, AND

6. REMOVE ALL REDUNDANT PLUMBING IN WALL OR FLOOR CAVITIES OPENED FOR CONSTRUCTION.

DEVICES ARE TO BE REMOVED.

GENERAL DEMOLITION NOTES

PROTECTED AS REQUIRED.

unless otherwise noted.

1. ALL DEMOLITION WORK IS TO BE CONDUCTED

2. ALL EXISTING EXTERIOR WALLS ARE TO REMAIN

In such a manner as to protect remaining

ELEMENTS. REMAINING ELEMENTS ARE TO BE

3. ALL EXISTING DOORS AND WINDOWS ARE TO BE REMOVED UNLESS OTHERWISE NOTED.

TO FINISH SURFACE ONLY; REPAIR AND REPLACE SUB-FLOORING AS REQUIRED. 5. ALL DOORS NOTED AS DEMOLISHED INCLUDE

FRAME UNLESS OTHERWISE NOTED.

7. ALL ELECTRICAL OUTLETS, SWITCHES, AND

8. CONTRACTOR IS TO VERIFY BEARING AND NON-BEARING STATUS OF EXISTING CONSTRUCTION TO BE DEMOLISHED BEFORE PROCEEDING WITH

51 MELCHER ST, FLR 1 BOSTON, MA 02210

FIRE PROTECTION PLS INC.

23 Sagamore ln. BOXFORD, MA 01921

CIVIL ENGINEER

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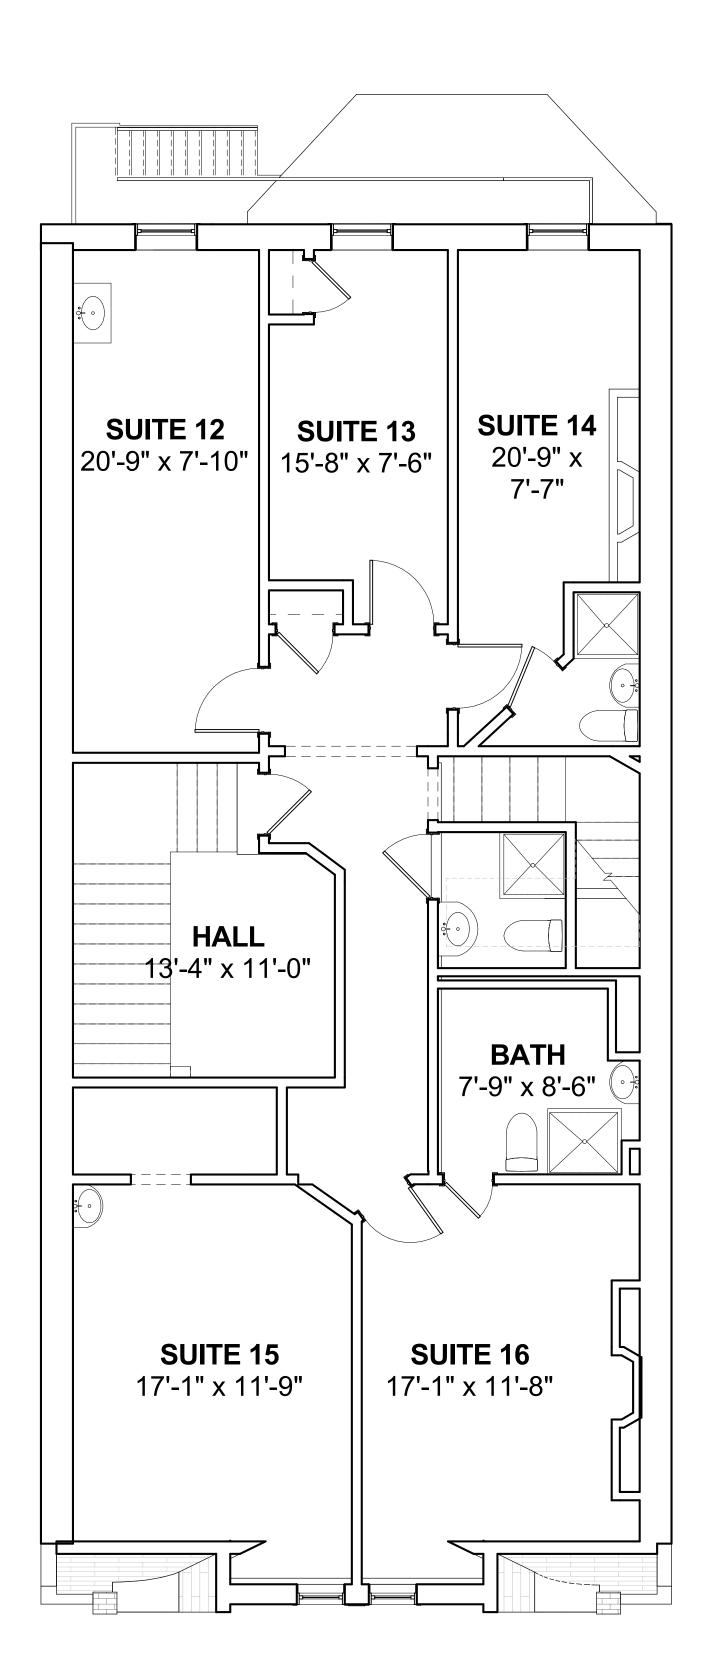
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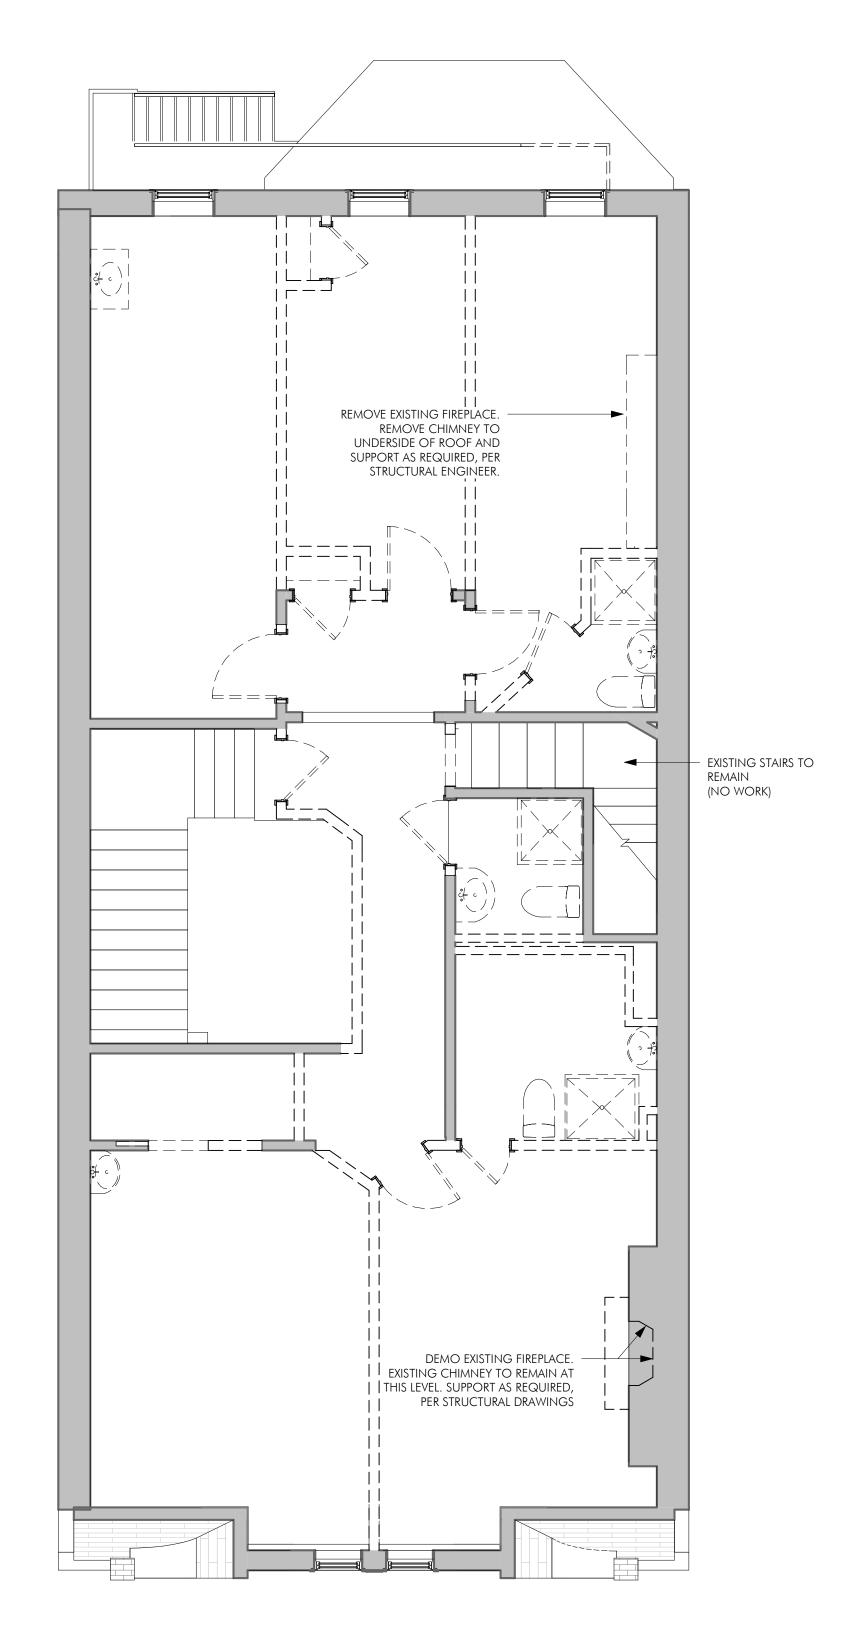
1/4" = 1'-0"

DRAWING TITLE DEMOLITION PLANS

DRAWING NUMBER

2 THIRD FLOOR EXISTING PLAN





NOTE:
ALL FLOORINGS IS TO BE
REMOVED DOWN TO SUBFLOOR,
REMOVE ALL WOOD FLOORING

FOURTH FLOOR DEMOLITION PLAN

1/4" = 1'-0"

DEMOLITION PLAN LEGEND

EXISTING WALL TO REMAIN

GENERAL DEMOLITION NOTES

DEMOLISHED BUILDING ELEMENT



AREA NOT IN CONTRACT

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| ARCHITECT

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FOUR 63 BEACON LLC 301 SOUTH AVE WESTON MA 02493

CONSULTANTS

SURVEYOR rj o'connell & assoc. 80 MONTVALE AVENUE STE. 201 STONEHAM, MA 02180

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51 MELCHER ST, FLR 1 BOSTON, MA 02210

FIRE PROTECTION PLS INC.

23 Sagamore ln. BOXFORD, MA 01921

CIVIL ENGINEER

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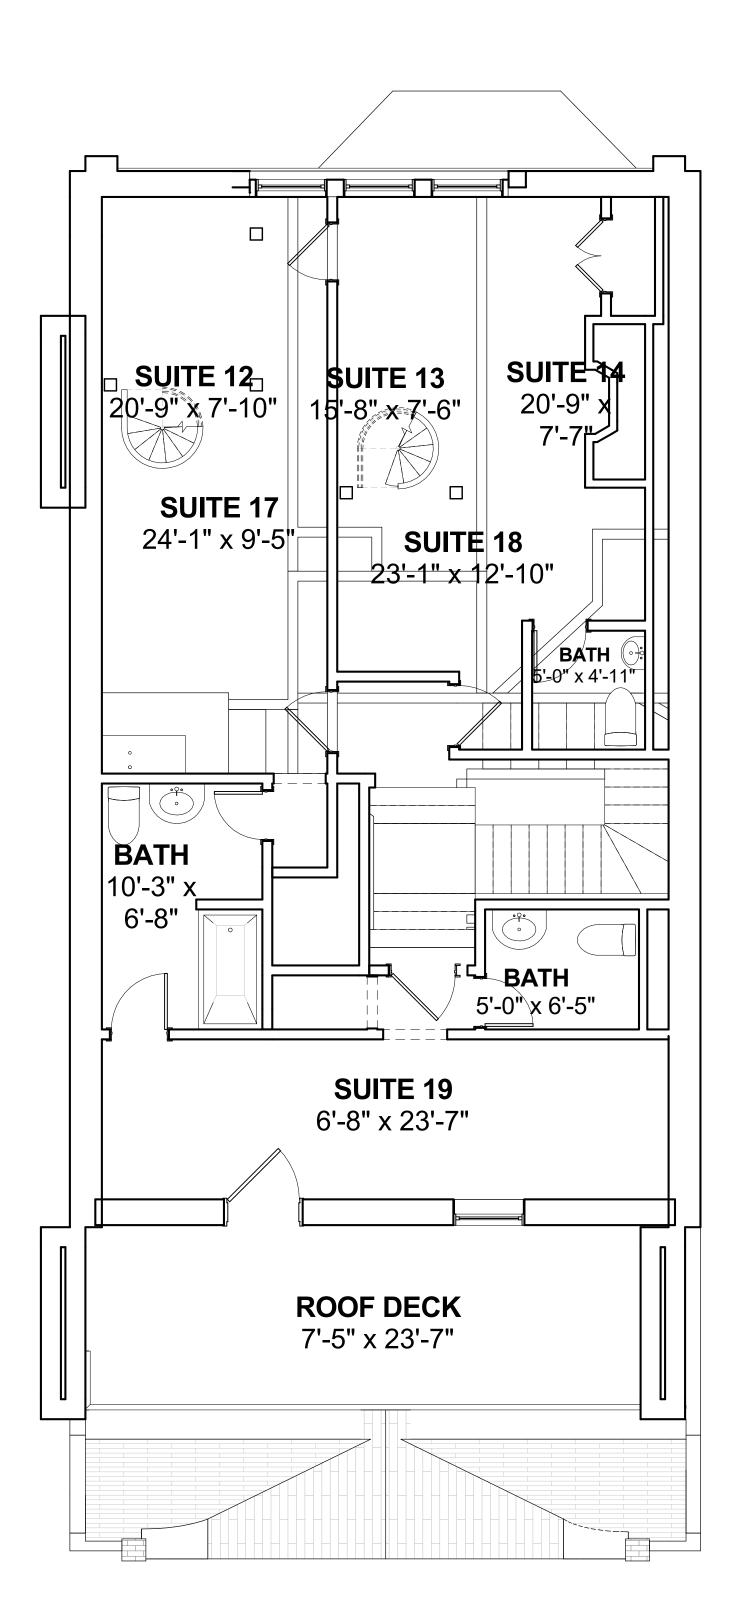



DRAWING INFORMATION

ISSUE: ISSUED FOR CONSTRUCTION

DATE: <u>JUNE 03, 2020</u> 1/4" = 1'-0"

DRAWING TITLE DEMOLITION PLANS



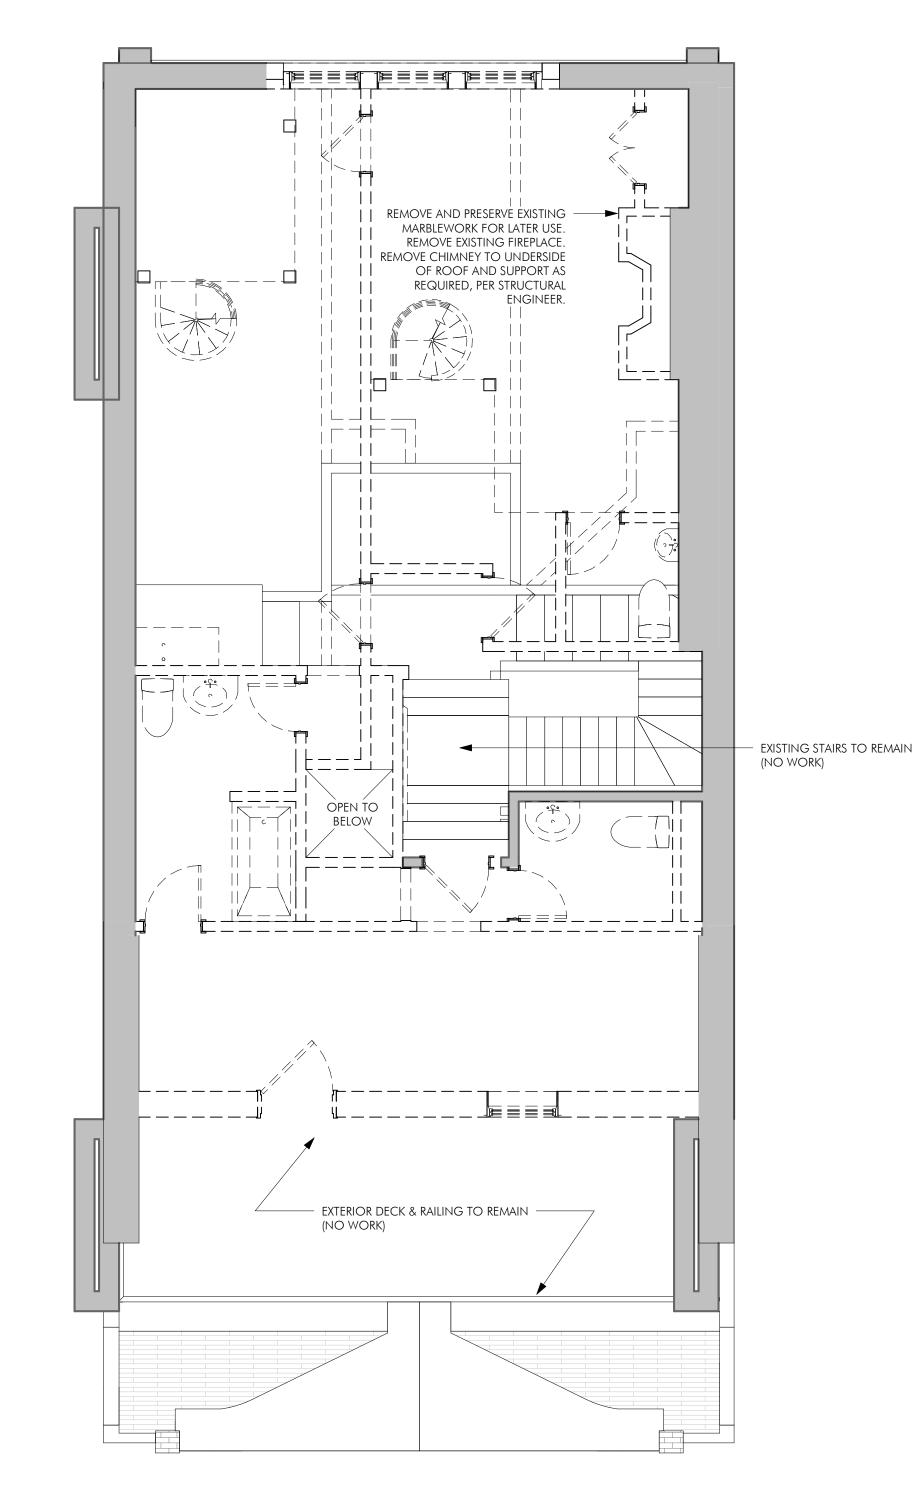

NOTE:
ALL FLOORINGS IS TO BE
REMOVED DOWN TO SUBFLOOR,
REMOVE ALL WOOD FLOORING

FIFTH FLOOR DEMOLITION PLAN

DEMOLITION PLAN LEGEND

EXISTING WALL TO REMAIN

DEMOLISHED BUILDING ELEMENT



AREA NOT IN CONTRACT

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| ARCHITECT 60 K STREET, 3RD FLOOR

BOSTON, MA 02127 O: 617.766.8330 www.embarcstudio.com

OWNER

FOUR 63 BEACON LLC 301 SOUTH AVE WESTON MA 02493

CONSULTANTS

SURVEYOR rj o'connell & assoc.

80 MONTVALE AVENUE STE. 201 STONEHAM, MA 02180 STRUCTURAL ENGINEER

51 MELCHER ST, FLR 1 BOSTON, MA 02210

FIRE PROTECTION PLS INC.

23 Sagamore ln. BOXFORD, MA 01921

BOSTON, MA 02125

CIVIL ENGINEER COLUMBIA DESIGN GROUP 14 UPHAM AVENUE

NSTRUC

BE ISSUED 463 B BOSTON,

REVISIONS

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DRAWING INFORMATION

ISSUED FOR CONSTRUCTION

1/4" = 1'-0"

DRAWING TITLE DEMOLITION

DRAWING NUMBER

PLANS

W001: WOOD FURRING PARTITION WITH 2X4" STUDS AT PARTY WALLS

W002: WOOD FURRING PARTITION WITH 2X6" STUDS AT PARTY WALLS WITH PLUMBING

– 1/2" Drainage Board - AT EXTERIOR WALLS PROVIDE 2 1/2" OF CLOSED CELL INSULATION IN STUD (1) LAYER 5/8" GWB, PTD. **W003:** 2X4 WOOD STUDS AT 16" O.C. **W004:** 2X6 WOOD STUDS AT 16" O.C. FINISH FLOOR — AND WALL BASE AS SCHEDULED EXISTING EXTERIOR WALL, SHOWN SHADED, SEE FLOOR Plans CONCRETE SLAB 5 5/8" (SEE STRUCTURAL)


WOOD FURRING WITH 2X4 STUD AT EXISTING EXTERIOR MASONRY WALLS

WOOD FURRING WITH 2X6 STUD AT EXISTING EXTERIOR MASONRY WALLS

NOTE: REFER TO RCP FOR CEILING HEIGHT & TYPE SOUND ATTENUATION Insulation where shown, SEE PLANS WOOD STUDS AT 16" O.C. - (1) LAYER OF 5/8" GWB. PROVIDE MOISTURE RESISTANT BOARD AT KITCHENS AND BATHROOMS $(S)_{\vdash}$ Finish flooring, refer TO FINISH PLAN

W010: TYPICAL PARTITION - 2X4 STUD

W011: TYPICAL PARTITION - 2X6 STUD

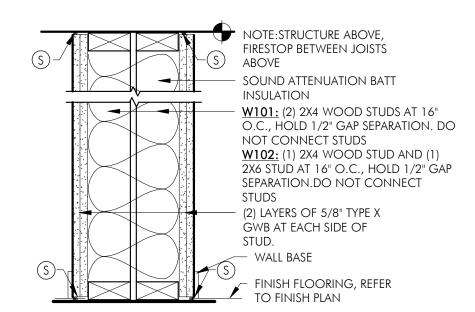

W101: TENANT TO STAIRWELL - 2X4 x 2x4 STUD

W102: TENANT TO STAIRWELL - 2X4 x 2x6 STUD

1. SEE FLOOR PLANS FOR PARTITION TAGS AND LOCATIONS.

SEE FLOOR PLANS FOR LOCATIONS OF SOUND INSULATION.

PARTITION TYPE DETAILS SHOW ONLY PRINCIPLE COMPONENTS AND REQUIREMENTS; RATED PARTITIONS WITH U.L. DESIGN NUMBERS MAY HAVE ADDITIONAL COMPONENTS AND REQUIREMENTS; REFER TO U.L. FIRE RESISTANCE DIRECTORY.

4. RATED PARTITIONS SHALL HAVE U.L. HEAD DESIGNS, SEALANT, AND FILL MATERIAL OF THE SAME RATING.

ALL THROUGH-WALL PENETRATIONS MUST BE COMPLETED TO PREVENT DIRECT CONTACT WITH FRAMING MEMBERS AND SHALL BE ACOUSTICALLY SEALED WITH A RESILIENT, NON-HARDENING CAULK. IF THE PENETRATION IS THOUGH A FIRE-RATED PARTITION, AN ACOUSTICAL FIRE-RATED CAULK SHALL BE USED.

6. SEE SPECIFICATIONS AND STRUCTURAL DRAWINGS FOR REINFORCING, BRACING AND OTHER SPECIAL REQUIREMENTS.

PROVIDE LATERAL BRACING AND CROSS-BRIDGING AS RECOMMENDED BY STUD MANUFACTURER FOR EACH CONDITION.

COORDINATE FINISHES APPLIED TO PARTITIONS AS INDICATED IN THE FINISH SCHEDULE, INTERIOR ELEVATIONS AND ELSEWHERE IN THE CONTRACT DOCUMENTS.

PROVIDE BLOCKING AT LOCATIONS INCLUDING BUT NOT LIMITED TO CASEWORK, SHELVING, COUNTERS, CABINETS, DOOR STOPS, HANDRAIL BRACKETS, TELEVISION LOCATIONS, BATHROOM ACCESSORIES, ETC. WHERE INDICATED, SPECIFIED OR REQUIRED TO PROVIDE A SOLID BASE.

10. SUBSTITUTE MOISTURE-RESISTANT GYPSUM BOARD AT ALL BATHROOMS AND LAUNDRY ROOMS.

11. WHERE TWO OR MORE LAYERS OF GYPSUM BOARD ARE USED, BOTH HORIZONTAL AND VERTICAL JOINTS SHALL BE STAGGERED.


12. FIBER INSULATION SHOULD BE UN-FACED AND SECURED TO STRUCTURE TO PREVENT SAGGING.

MAINTAIN CONTINUOUS 1/2" AIR GAP BETWEEN 2X WALL AND VERTICAL SHAFT WALL 2x4 STUD WALL TO ATTACH to stringer 2 1/2" MTL. STUD WALL MAINTAIN 3/4" GAP BETWEEN WITH (2) LAYERS STRINGERS AND WALLS; OF 5/8" TYPE 'X' CAP WITH WOOD GYPSUM WALL BOAD BREAK IN G.W.B., 2" MIN. EXISTING STRINGER - 2 1/2" METAL STUD FRAMING - EXISTING WALL, SHOWN HORIZONTAL 1HR RATED SHADED, SEE FLOOR PLANS SHAFTWALL FILL CAVITY WITH FIBERGLASS INSULATION — 2 1/2" METAL STUDS AT 16" O.C. (1) LAYERS OF 5/8" GYPSUM BOARD MAINTAIN CONTINUOUS 1/2" AIR GAP BETWEEN HORIZONTAL SHAFTWALL AND underside of stair stringer (2) LAYER OF 5/8" TYPE "X" GYPSUM BOARD ON UNDERSIDE OF STAIR HORIZONTAL SHAFTWALL

DEMISING WOOD STAIR ASSEMBLY - SECTION 1 1/2" = 1'-0"

TO HAVE NO CONNECTION

TO STAIR STRINGER FRAMING.

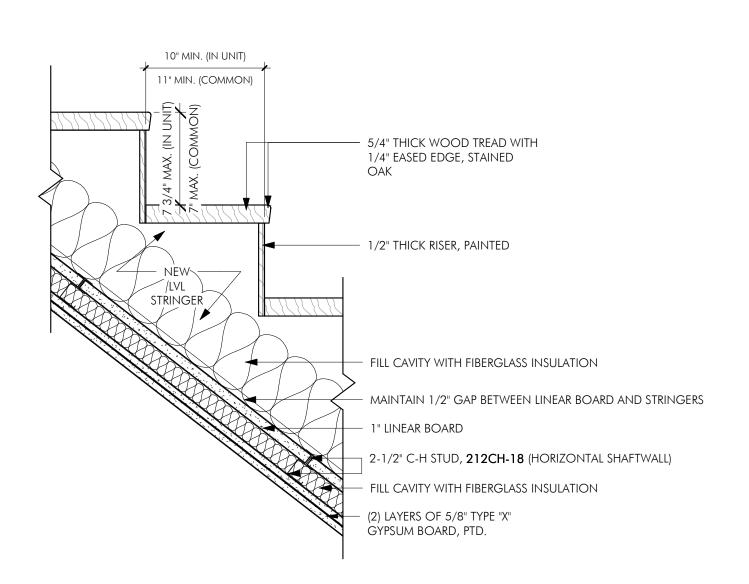

HORIZONTAL SHAFTWALL TO HAVE NO CONNECTION TO STAIR STRINGER FRAMING.

WOOD STAIRS - SHAFT WALL DEMISING STAIR 1 1/2" = 1'-0"

| ARCHITECT

OWNER

FOUR 63 BEACON LLC 301 SOUTH AVE WESTON MA 02493

BOSTON, MA 02127

www.embarcstudio.com

O: 617.766.8330

CONSULTANTS

SURVEYOR rj o'connell & assoc. 80 MONTVALE AVENUE STE. 201 STONEHAM, MA 02180

STRUCTURAL ENGINEER H+O STRUCTURAL ENG.

51 MELCHER ST, FLR 1 BOSTON, MA 02210

FIRE PROTECTION PLS INC.

23 Sagamore ln. BOXFORD, MA 01921

CIVIL ENGINEER COLUMBIA DESIGN GROUP 14 UPHAM AVENUE BOSTON, MA 02125

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REVISIONS

MARK ISSUE

DRAWING INFORMATION ISSUE: ISSUED FOR CONSTRUCTION

JUNE 03, 2020 PROJECT #: 19054 1 1/2" = 1'-0"

DRAWING TITLE PARTITION DETAILS

DRAWING NUMBER

PUBLIC ALLEYWAY ✓ SIDEWALK
✓ 8' - 6" 8' - 6" 8' - 0" 13' - 8 3/4" -9' - 8 1/2" GARDEN LEVEL SLOPE = 1:12 GARDEN ENTRY BEACON ST 2 SITE PLAN
3/16" = 1'-0"

EMBARC

60 K STREET, 3RD FLOOR BOSTON, MA 02127 O: 617.766.8330 www.embarcstudio.com

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STONEHAM, MA 02180

STRUCTURAL ENGINEER
H+O STRUCTURAL ENG.

51 MELCHER ST, FLR 1 BOSTON, MA 02210

PLS INC. 23 SAGAMORE LN. BOXFORD, MA 01921

FIRE PROTECTION

BOXFORD, MA 01921


CIVIL ENGINEER
COLUMBIA DESIGN GROUP
14 UPHAM AVENUE
BOSTON, MA 02125

ONSTRUCTION

463 BEACON STREET BOSTON, MA 02115

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DRAWING INFORMATION

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DATE: ILINE 03, 2020

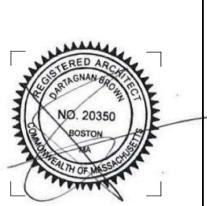DATE: JUNE 03, 2020


PROJECT #: 19054


SCALE: 3/16" = 1'-0"

DRAWING TITLE
SITE PLAN

DRAWING NUMBER

A010

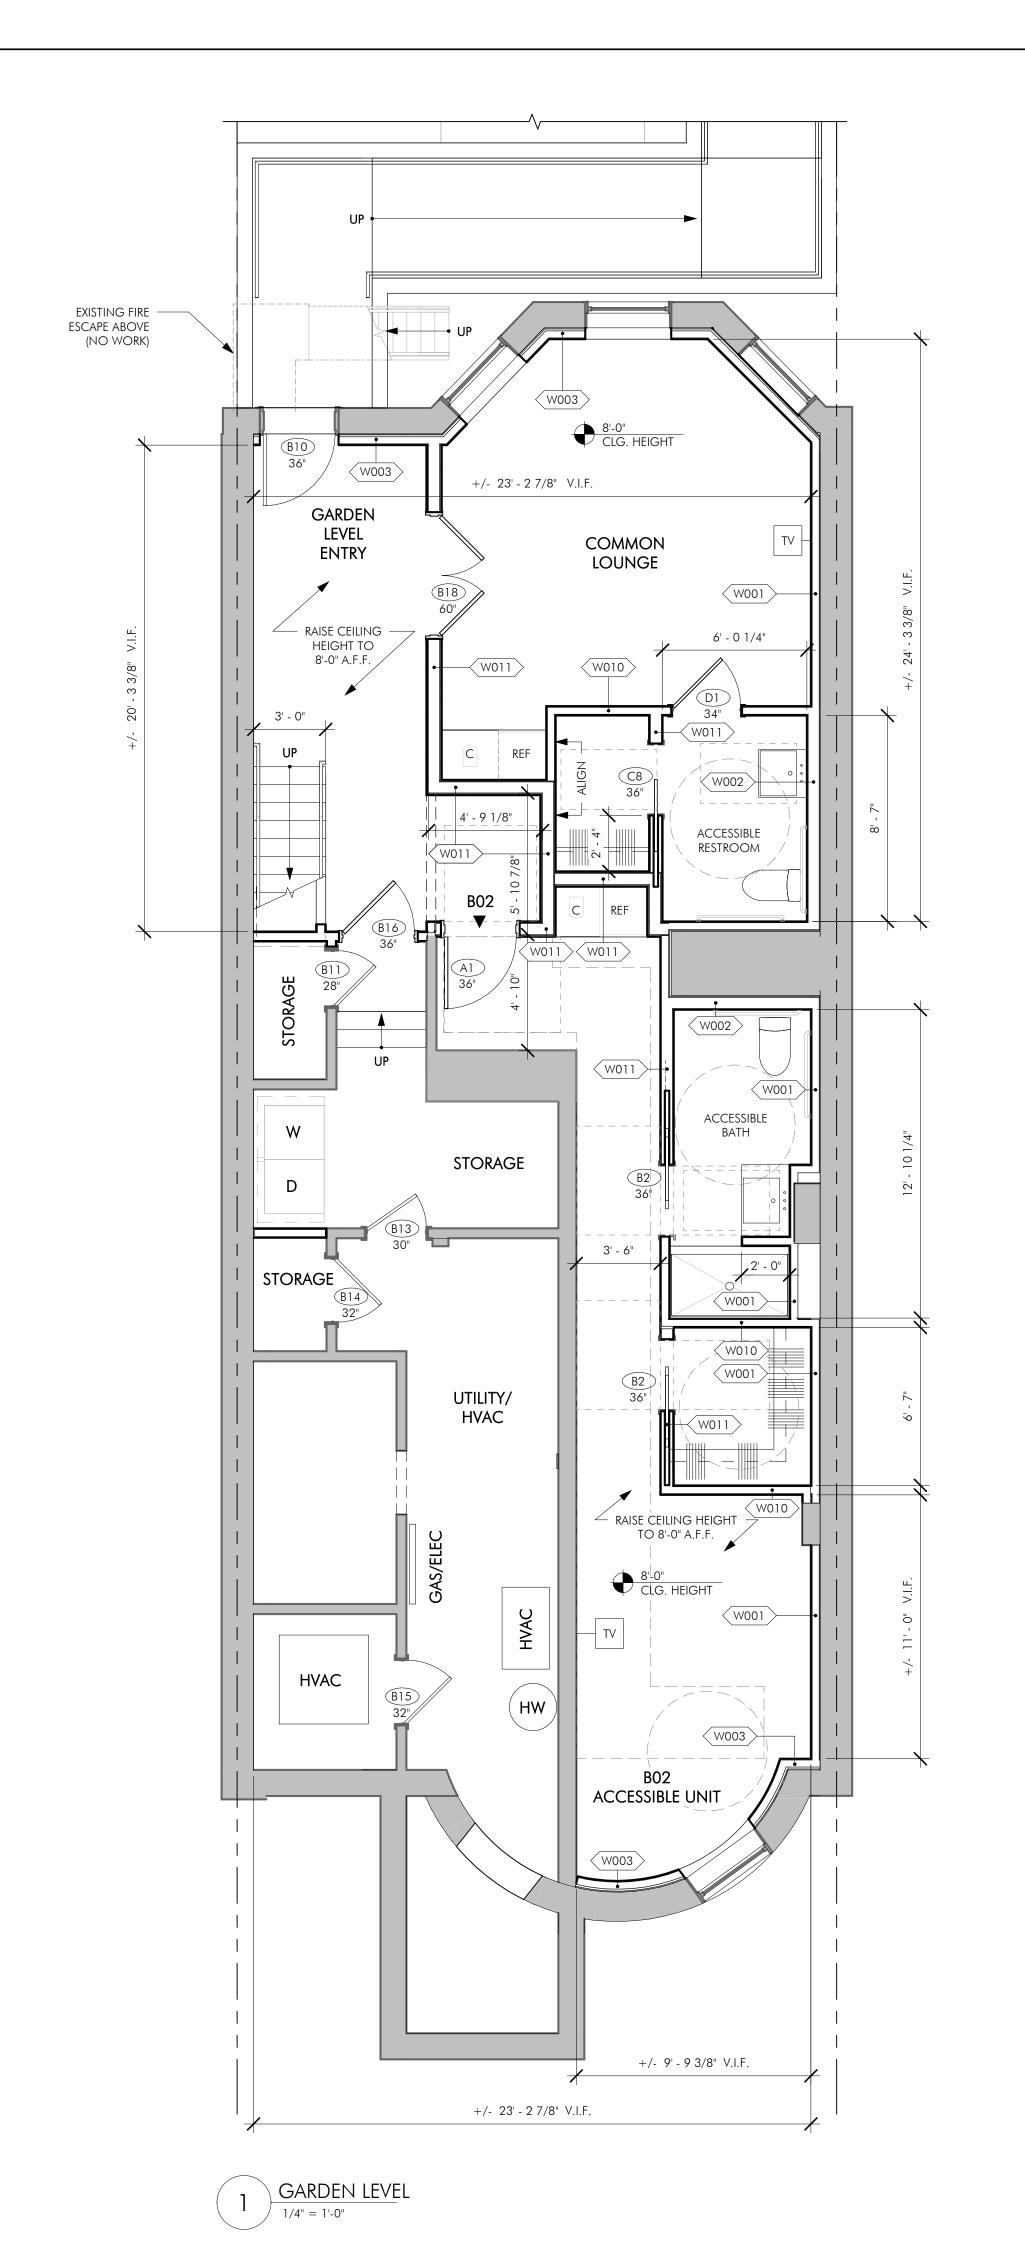

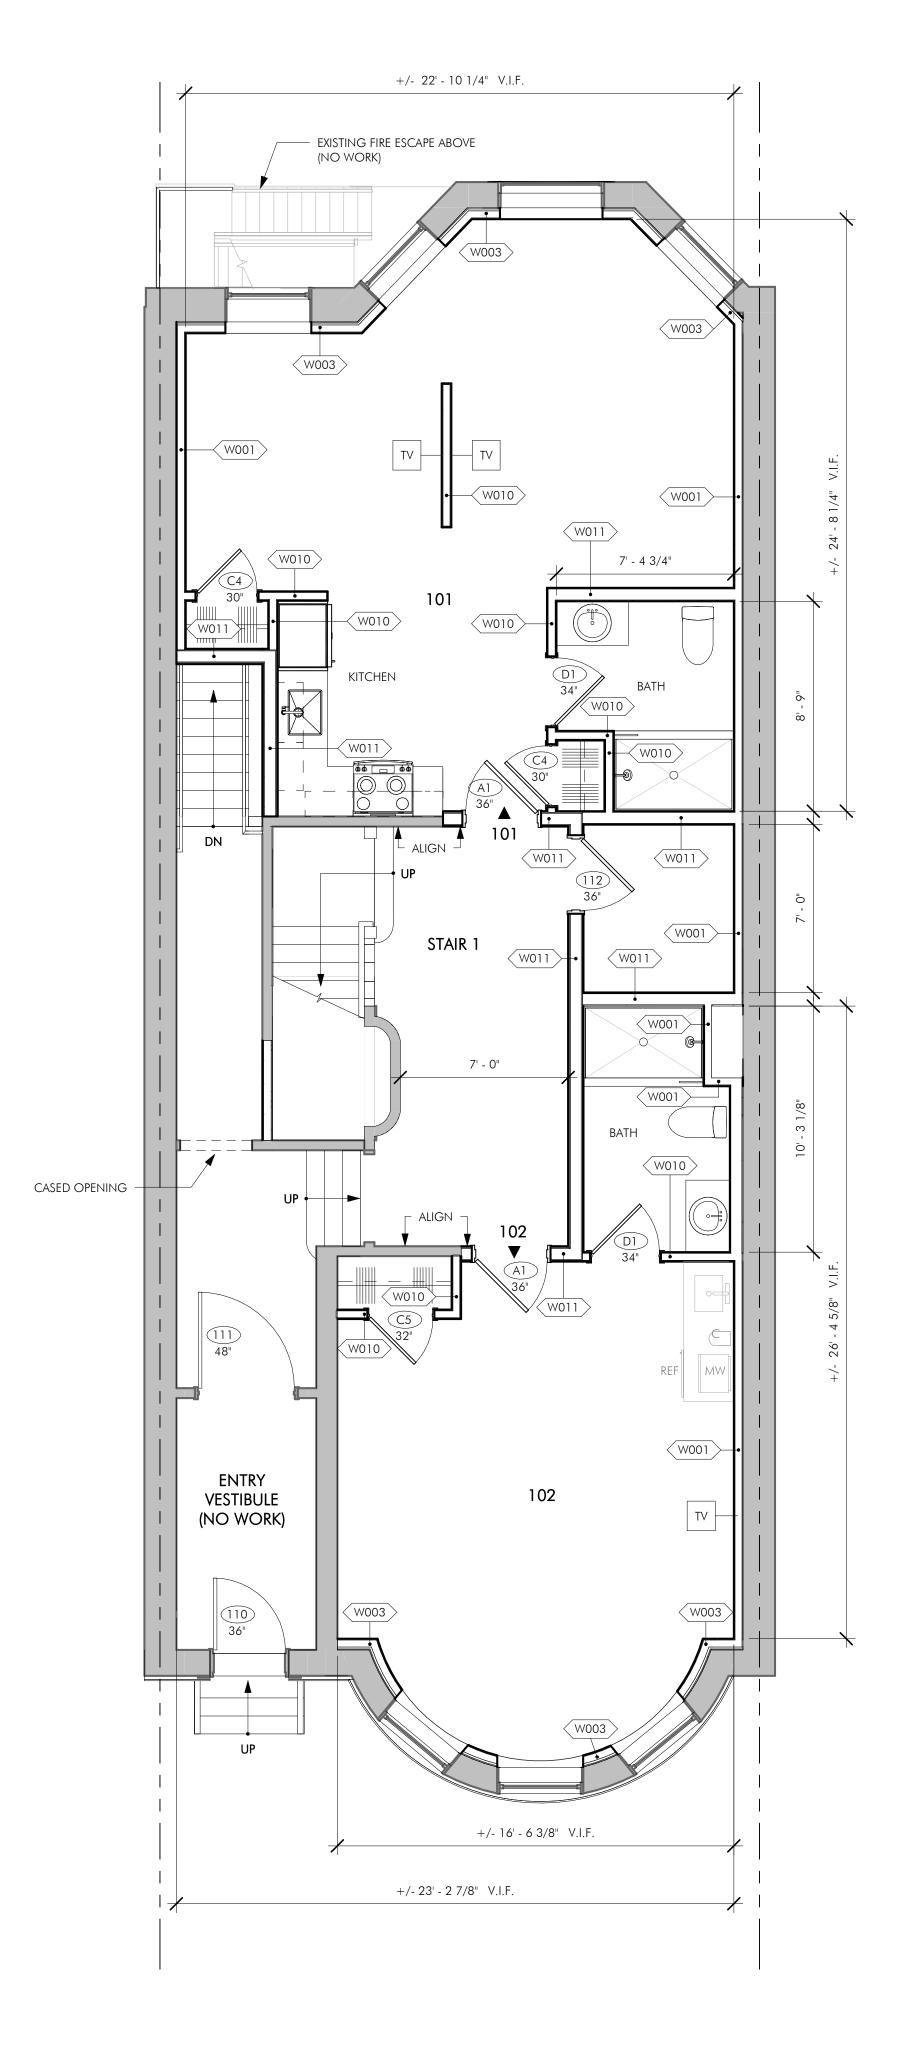

GENERAL NOTES

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- 2. ALL DIMENSIONS ARE TO BE TAKEN FROM NUMERIC DESIGNATIONS ONLY; DIMENSIONS ARE NOT TO BE SCALED OFF THE DRAWINGS.
- 3. ALL INTERIOR DIMENSIONS ARE TO FACE OF FINISH UNLESS OTHERWISE NOTED.
- 4. ALL GYPSUM BOARD SURFACES ARE TO BE 5/8" THICK UNLESS OTHERWISE NOTED.
- 5. ALL GYPSUM AND PLASTER FINISHES SHOULD BE SMOOTH, CONTINUOUS, FREE OF IMPERFECTIONS. AND HAVE NO VISIBLE JOINTS.
- 6 ALL CLOSETS SHALL HAVE SHELF AND POLE OR SHELVES AS REQUIRED, UNLESS OTHERWISE NOTED.
- 7. ALL DOORS ARE TO BE 84" TALL UNLESS OTHERWISE NOTED.
- 8. ALL REQUIRED LIFE SAFETY DEVICES, INCLUDING SMOKE & CARBON MONOXIDE DETECTORS, SHALL BE INSTALLED BY THE CONTRACTOR IN COMPLIANCE WITH THE 2015 INTERNATIONAL BUILDING CODE

ELECTRICAL NOTES

- 1. ELECTRICAL SERVICE POWER IS TO BE EVALUATED FOR MEETING LIGHTING DESIGN AND EQUIPMENT REQUIREMENTS. PROPER POWER LEVEL SHALL BE PROVIDED.
- 2. ALL NEW ELECTRICAL ITEMS ARE TO BE U.L. RATED.
- 3. ALL ELECTRICAL PANELS ARE TO BE RECESSED INTO A WALL WITH A MINIMUM 6" STUD DIMENSION. REVIEW FINAL LOCATION WITH ARCHITECT AND OWNER.

BUILDING WIRING WITH BATTERY BACK-UP.

4. ALL DISTRIBUTION PANELS ARE TO BE NEW.

5. ALL CLOSET LIGHTING IS TO BE FLUORESCENT OR HIGH EFFICIENCY LIGHTING.

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- B. MOUNT ALL SWITCHES AT 42" TO CENTERLINE ABOVE FINISH FLOOR UNLESS OTHERWISE NOTED. C. VERTICALLY ALIGN SWITCHES AND OUTLETS WHERE POSSIBLE.

FLOOR PLAN LEGEND

EXISTING WALL TO REMAIN

TV LOCATION

| ARCHITECT

BOSTON, MA 02127 O: 617.766.8330

www.embarcstudio.com OWNER

FOUR 63 BEACON LLC 301 South ave Weston ma 02493

CONSULTANTS

SURVEYOR rj o'connell & assoc. 80 MONTVALE AVENUE STE. 201 STONEHAM, MA 02180

STRUCTURAL ENGINEER H+O STRUCTURAL ENG.

51 MELCHER ST, FLR 1 BOSTON, MA 02210

FIRE PROTECTION

PLS INC.

23 SAGAMORE LN. BOXFORD, MA 01921

CIVIL ENGINEER COLUMBIA DESIGN GROUP 14 UPHAM AVENUE BOSTON, MA 02125

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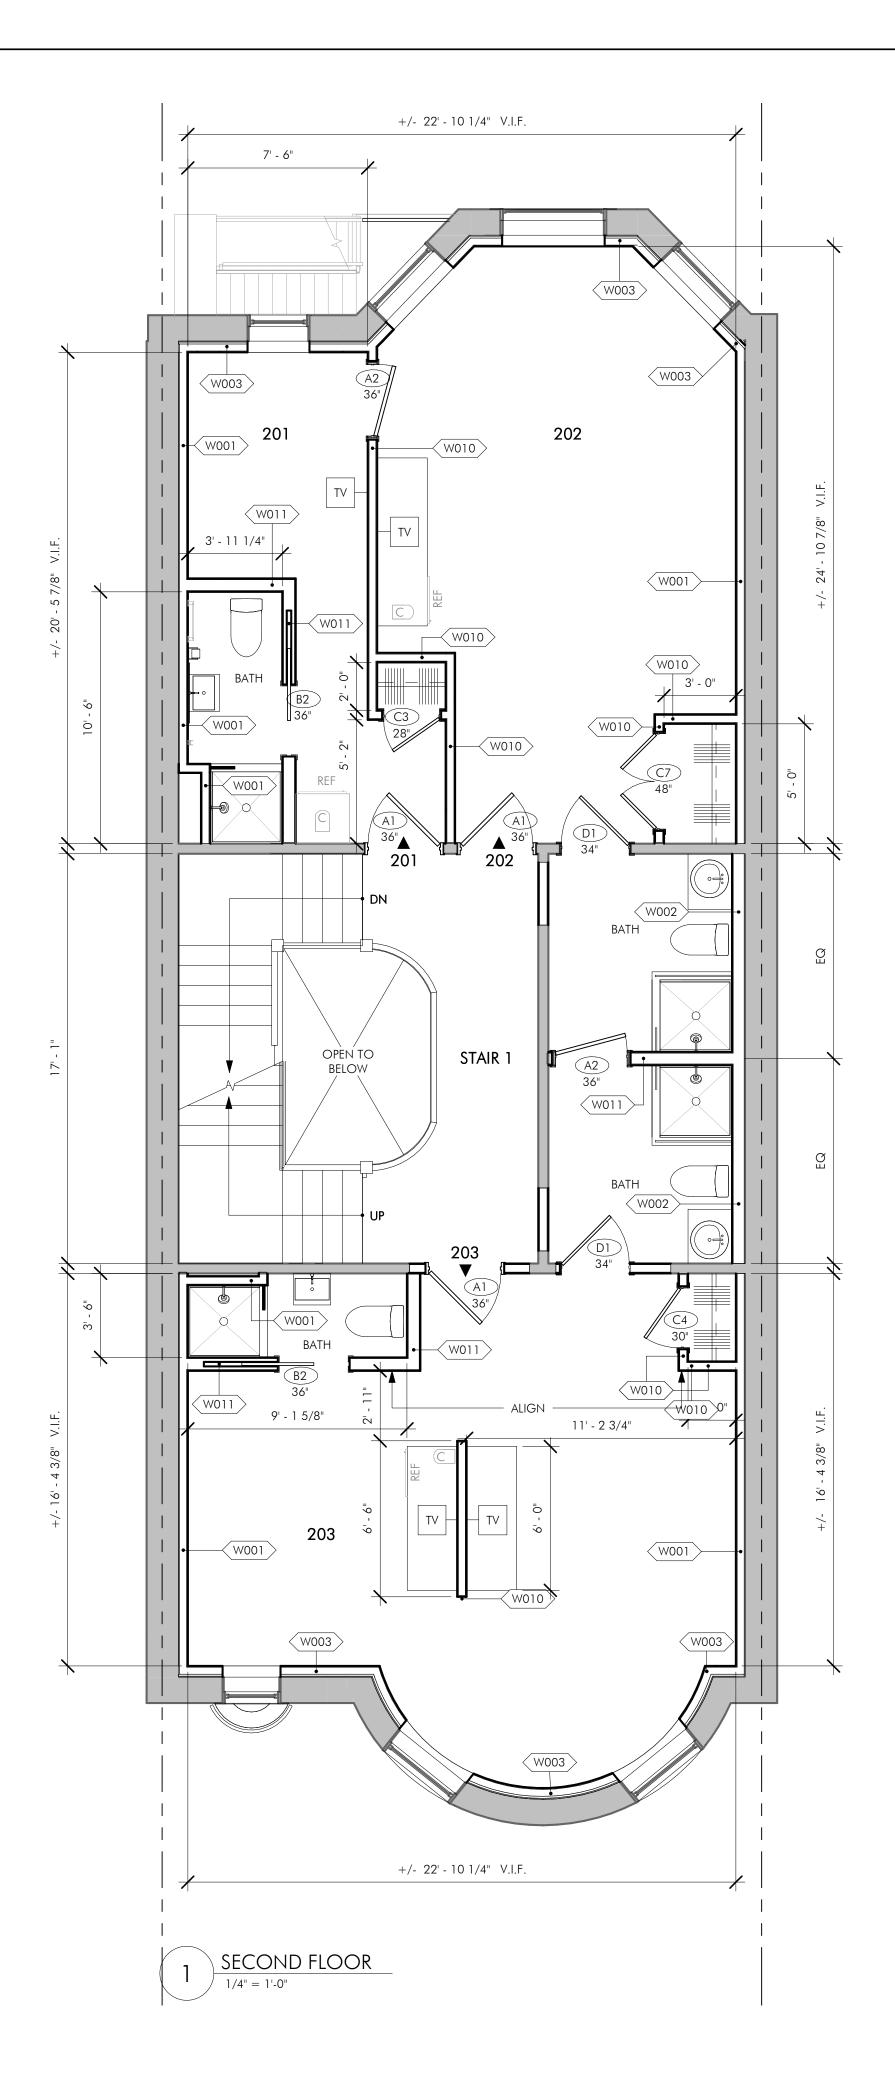
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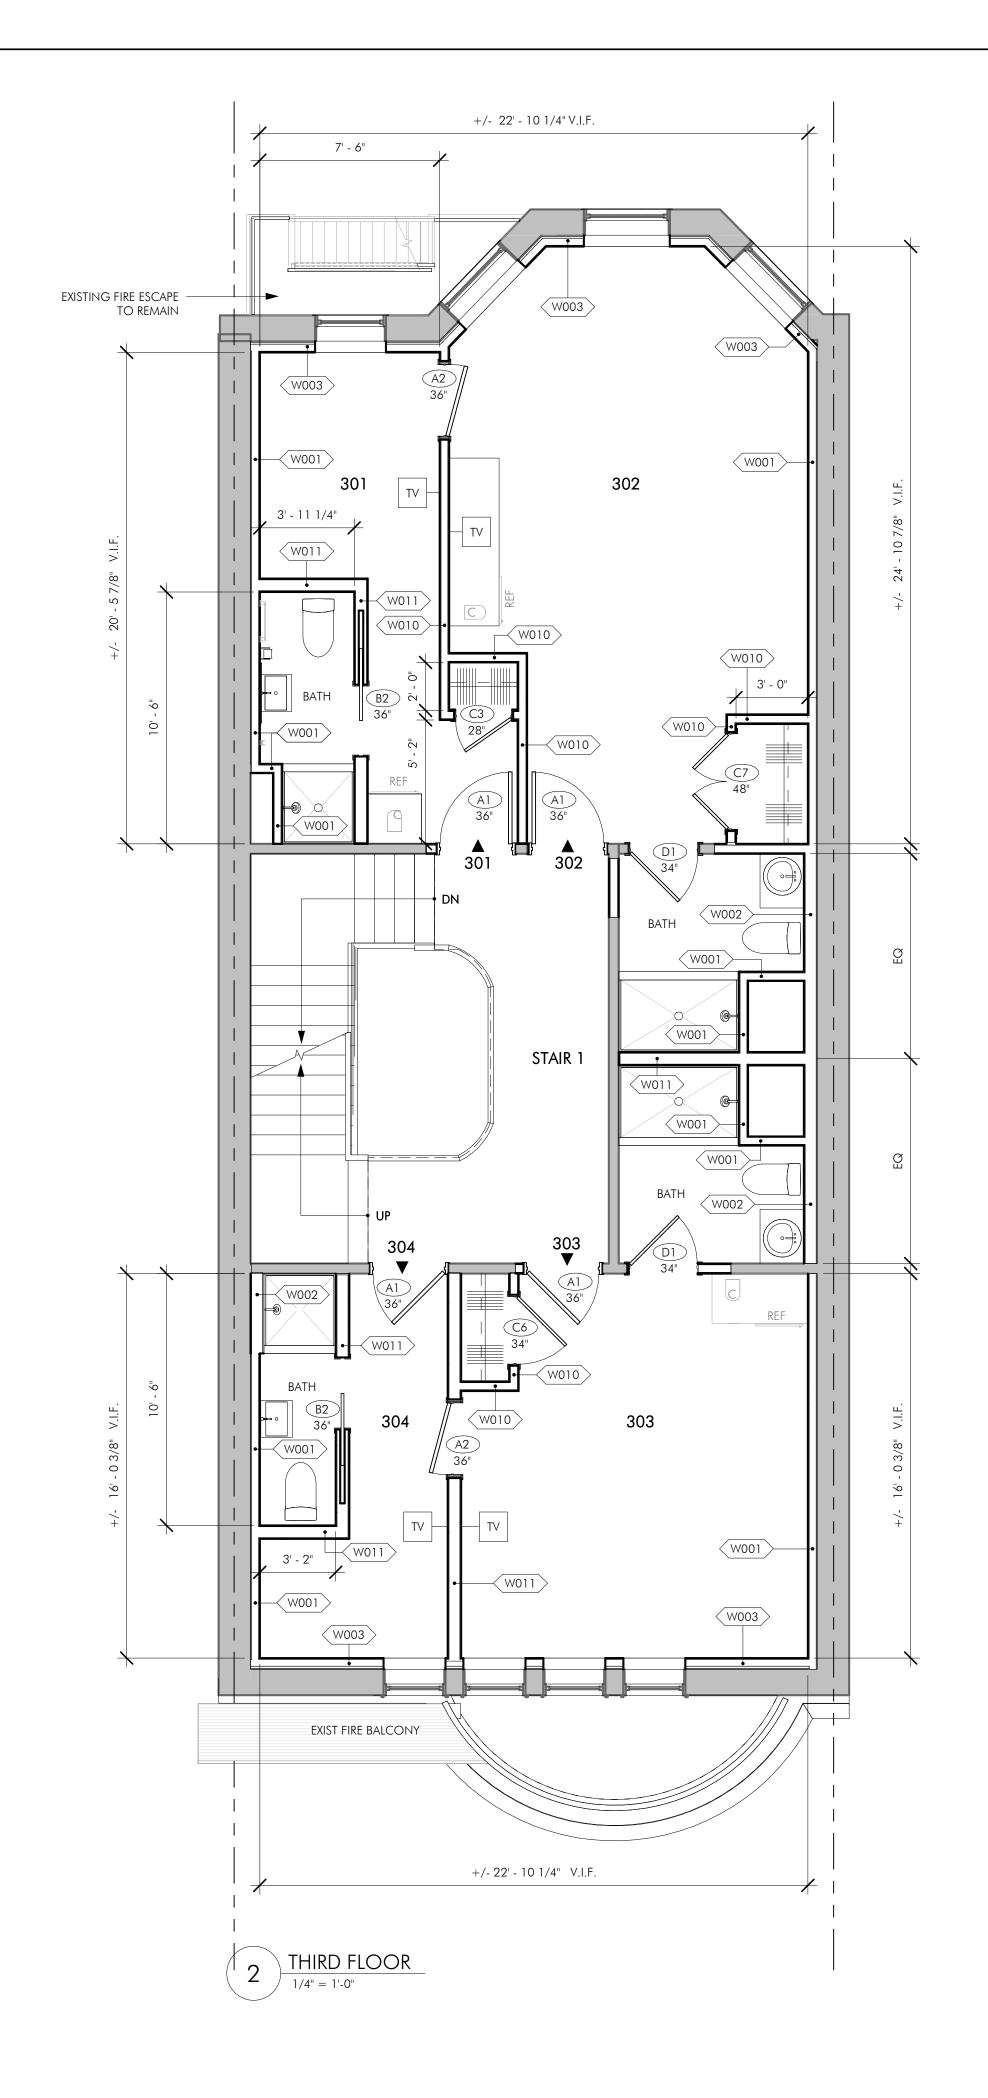


ISSUED FOR CONSTRUCTION

DRAWING TITLE GARDEN & PARLOR (FIRST FLOOR)

LEVEL PLANS DRAWING NUMBER





GENERAL NOTES

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FLOOR PLAN LEGEND

EXISTING WALL TO REMAIN

TV LOCATION

| ARCHITECT

BOSTON, MA 02127 O: 617.766.8330

www.embarcstudio.com

OWNER

FOUR 63 BEACON LLC 301 South ave Weston ma 02493

CONSULTANTS

SURVEYOR rj o'connell & assoc.

80 MONTVALE AVENUE STE. 201 STONEHAM, MA 02180 STRUCTURAL ENGINEER

H+O STRUCTURAL ENG. 51 MELCHER ST, FLR 1 BOSTON, MA 02210

FIRE PROTECTION

PLS INC.

23 SAGAMORE LN. BOXFORD, MA 01921

CIVIL ENGINEER

COLUMBIA DESIGN GROUP 14 UPHAM AVENUE BOSTON, MA 02125

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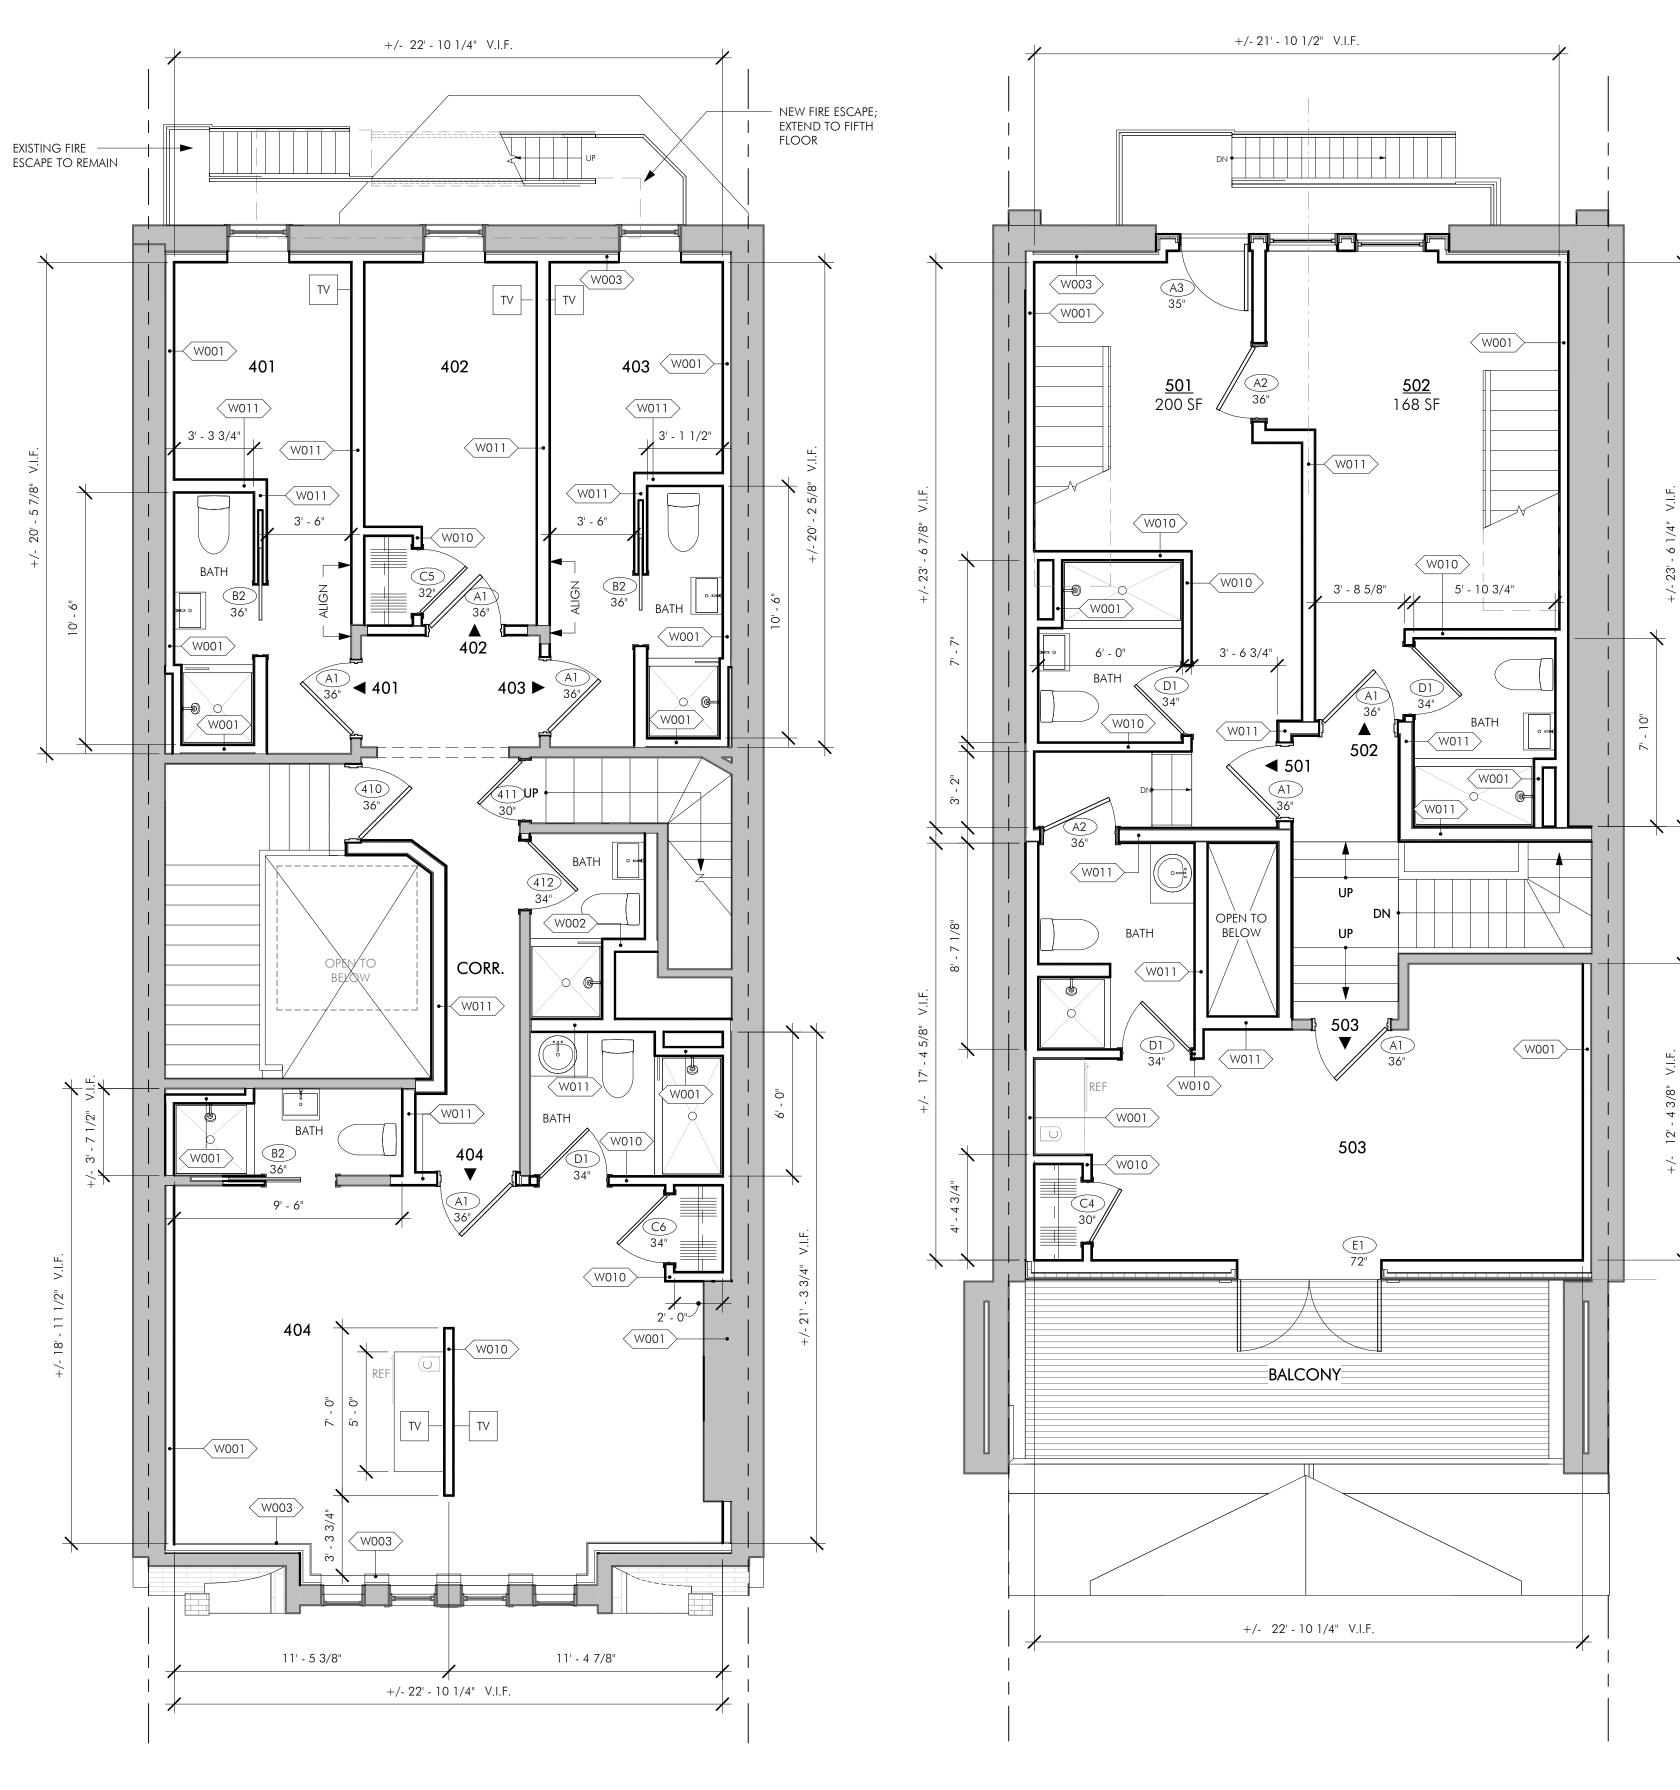


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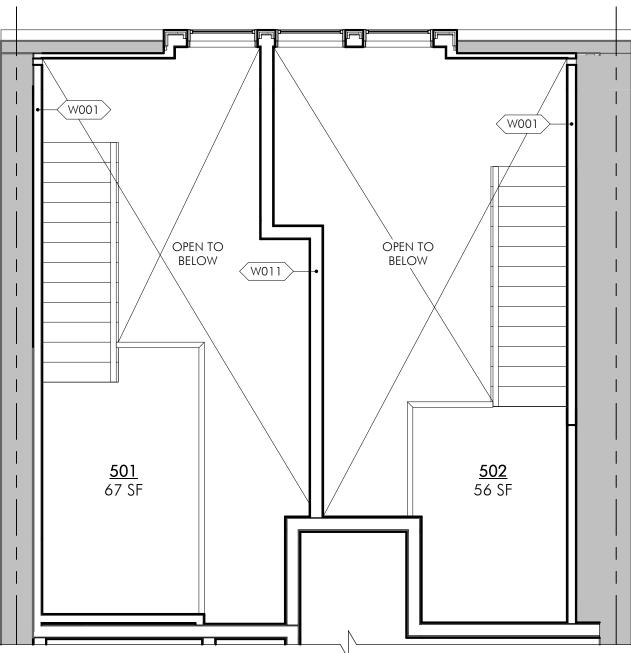
1/4" = 1'-0"

DRAWING TITLE SECOND & THIRD FLOOR PLAN



FOURTH FLOOR

1/4" = 1'-0"



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FLOOR PLAN LEGEND

EXISTING WALL TO REMAIN

NEW WALL

TV LOCATION

| ARCHITECT

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www.embarcstudio.com

OWNER

FOUR 63 BEACON LLC 301 South ave Weston ma 02493

CONSULTANTS

SURVEYOR rj o'connell & assoc.

80 MONTVALE AVENUE STE. 201 STONEHAM, MA 02180

STRUCTURAL ENGINEER H+O STRUCTURAL ENG. 51 MELCHER ST, FLR 1 BOSTON, MA 02210

FIRE PROTECTION

PLS INC.

23 SAGAMORE LN. BOXFORD, MA 01921

CIVIL ENGINEER COLUMBIA DESIGN GROUP 14 UPHAM AVENUE BOSTON, MA 02125

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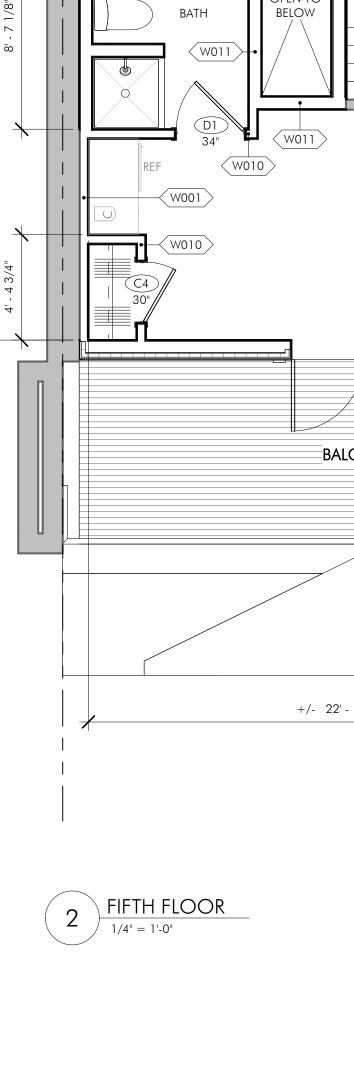
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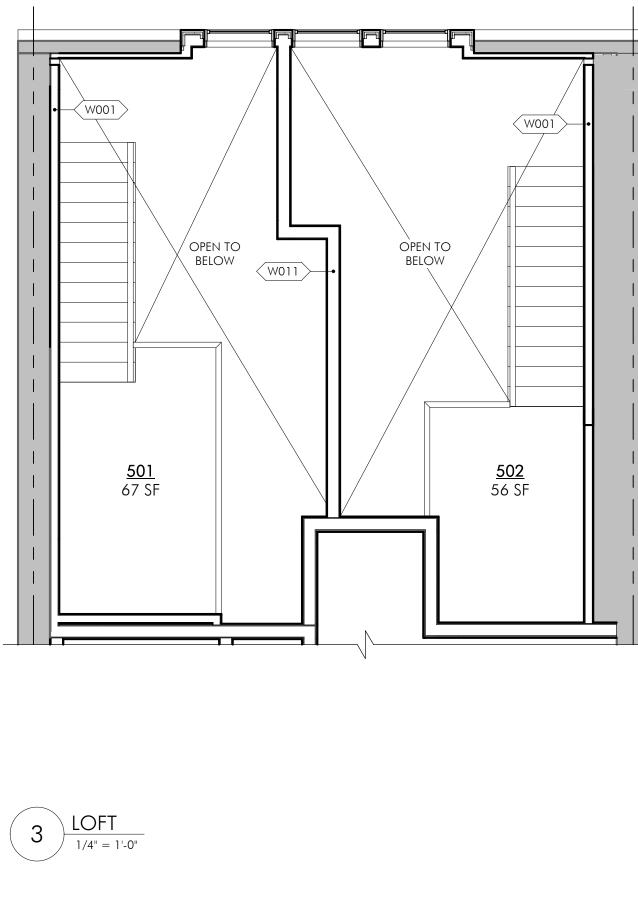
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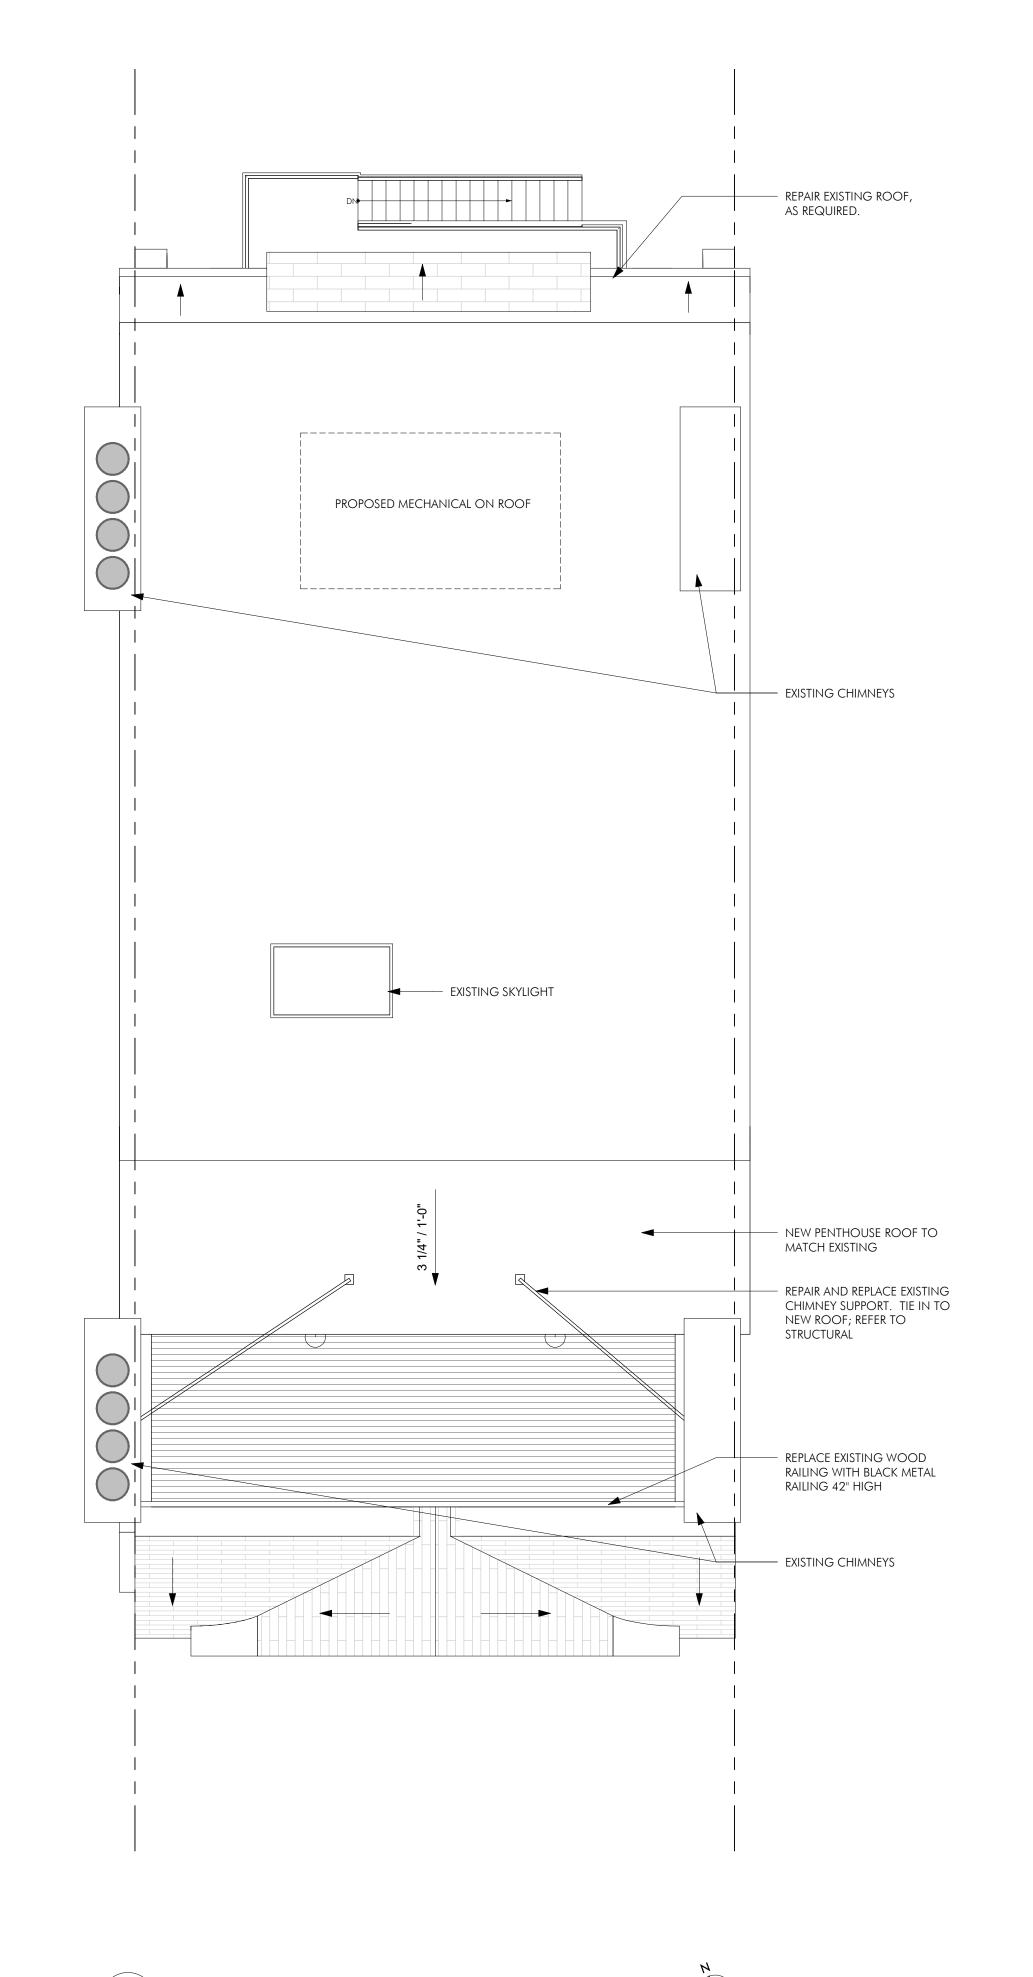


ISSUED FOR CONSTRUCTION

DRAWING TITLE FOURTH & FIFTH FLOOR PLAN







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FLOOR PLAN LEGEND

EXISTING WALL TO REMAIN

TV LOCATION

| ARCHITECT

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OWNER

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STRUCTURAL ENGINEER H+O STRUCTURAL ENG. 51 MELCHER ST, FLR 1 BOSTON, MA 02210

FIRE PROTECTION

PLS INC. 23 SAGAMORE LN. BOXFORD, MA 01921

CIVIL ENGINEER COLUMBIA DESIGN GROUP 14 UPHAM AVENUE BOSTON, MA 02125

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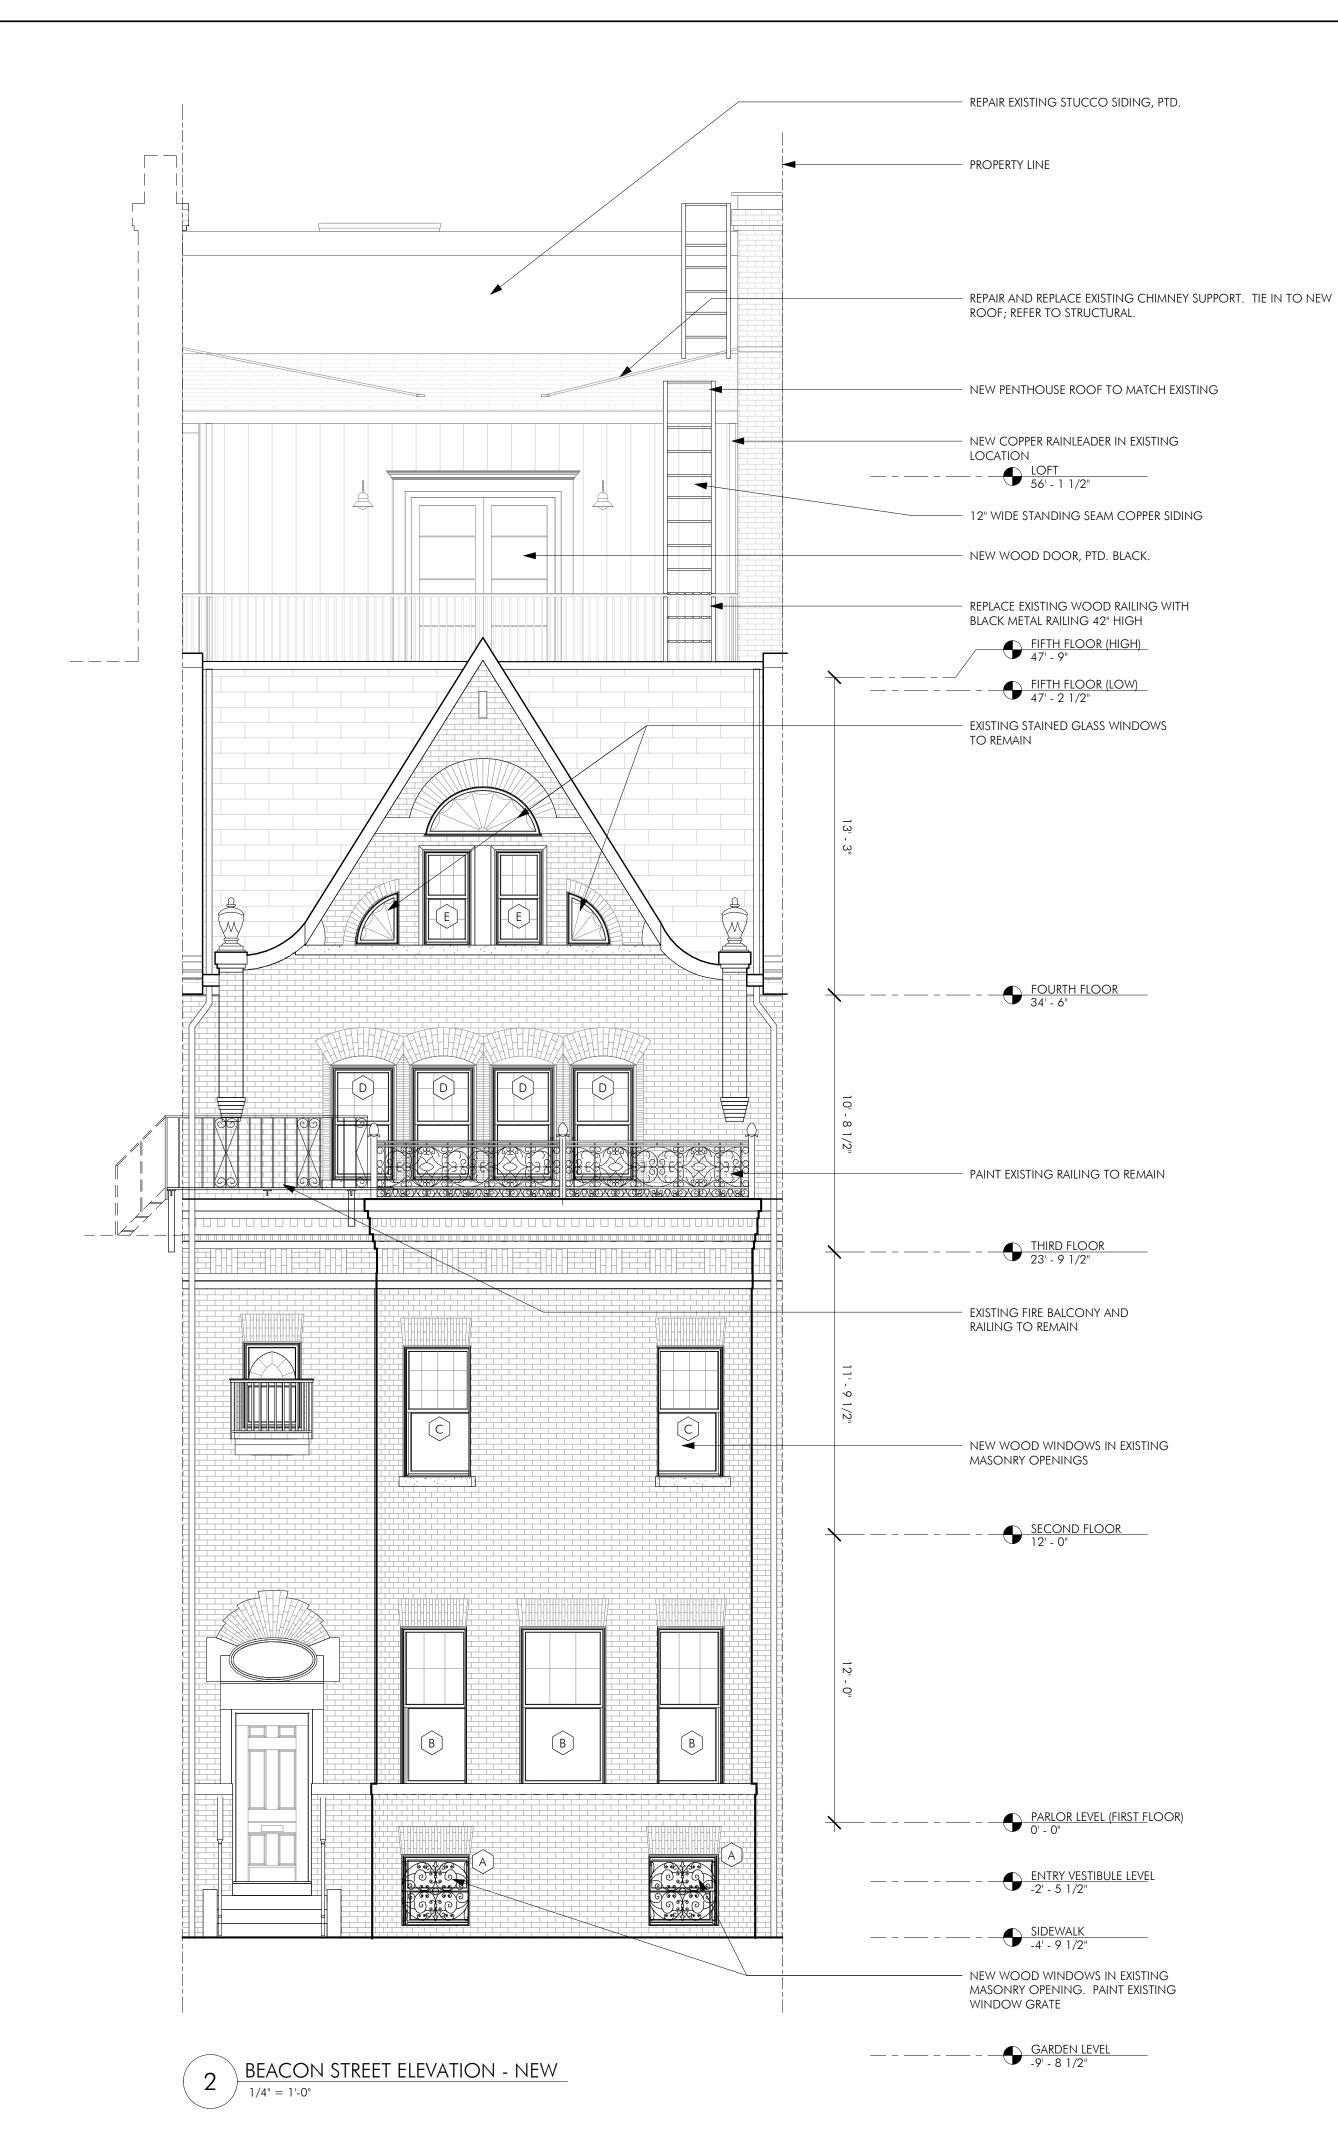
DATE: <u>JUNE 03, 2020</u> PROJECT #: 19054 SCALE: 1/4'' = 1'-0''

DRAWING TITLE

ROOF PLAN



BEACON STREET ELEVATION - EXISTING
1/4" = 1'-0"



| ARCHITECT

60 K STREET, 3RD FLOOR BOSTON, MA 02127 O: 617.766.8330 www.embarcstudio.com

FOUR 63 BEACON LLC 301 SOUTH AVE WESTON MA 02493

CONSULTANTS

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STRUCTURAL ENGINEER H+O STRUCTURAL ENG.

51 MELCHER ST, FLR 1 BOSTON, MA 02210 FIRE PROTECTION

PLS INC. 23 SAGAMORE LN. BOXFORD, MA 01921

CIVIL ENGINEER

COLUMBIA DESIGN GROUP

14 UPHAM AVENUE BOSTON, MA 02125

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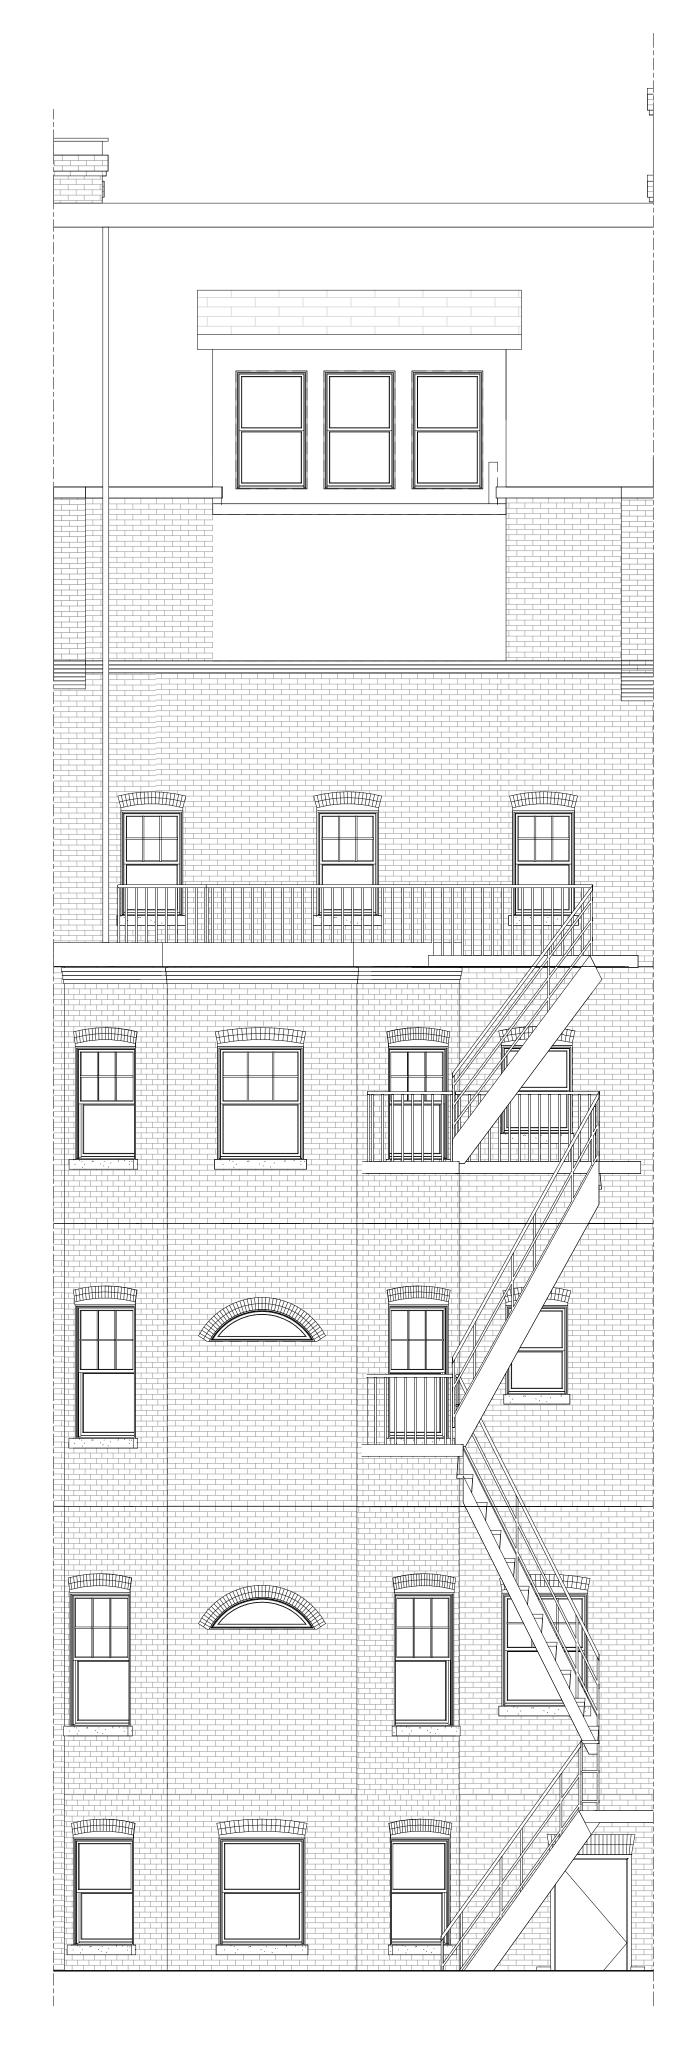


DRAWING INFORMATION ISSUE: ISSUED FOR CONSTRUCTION JUNE 03, 2020


PROJECT #: 19054 1/4" = 1'-0"

DRAWING TITLE BUILDING ELEVATIONS

DRAWING NUMBER



1 REAR ELEVATION - EXISTING

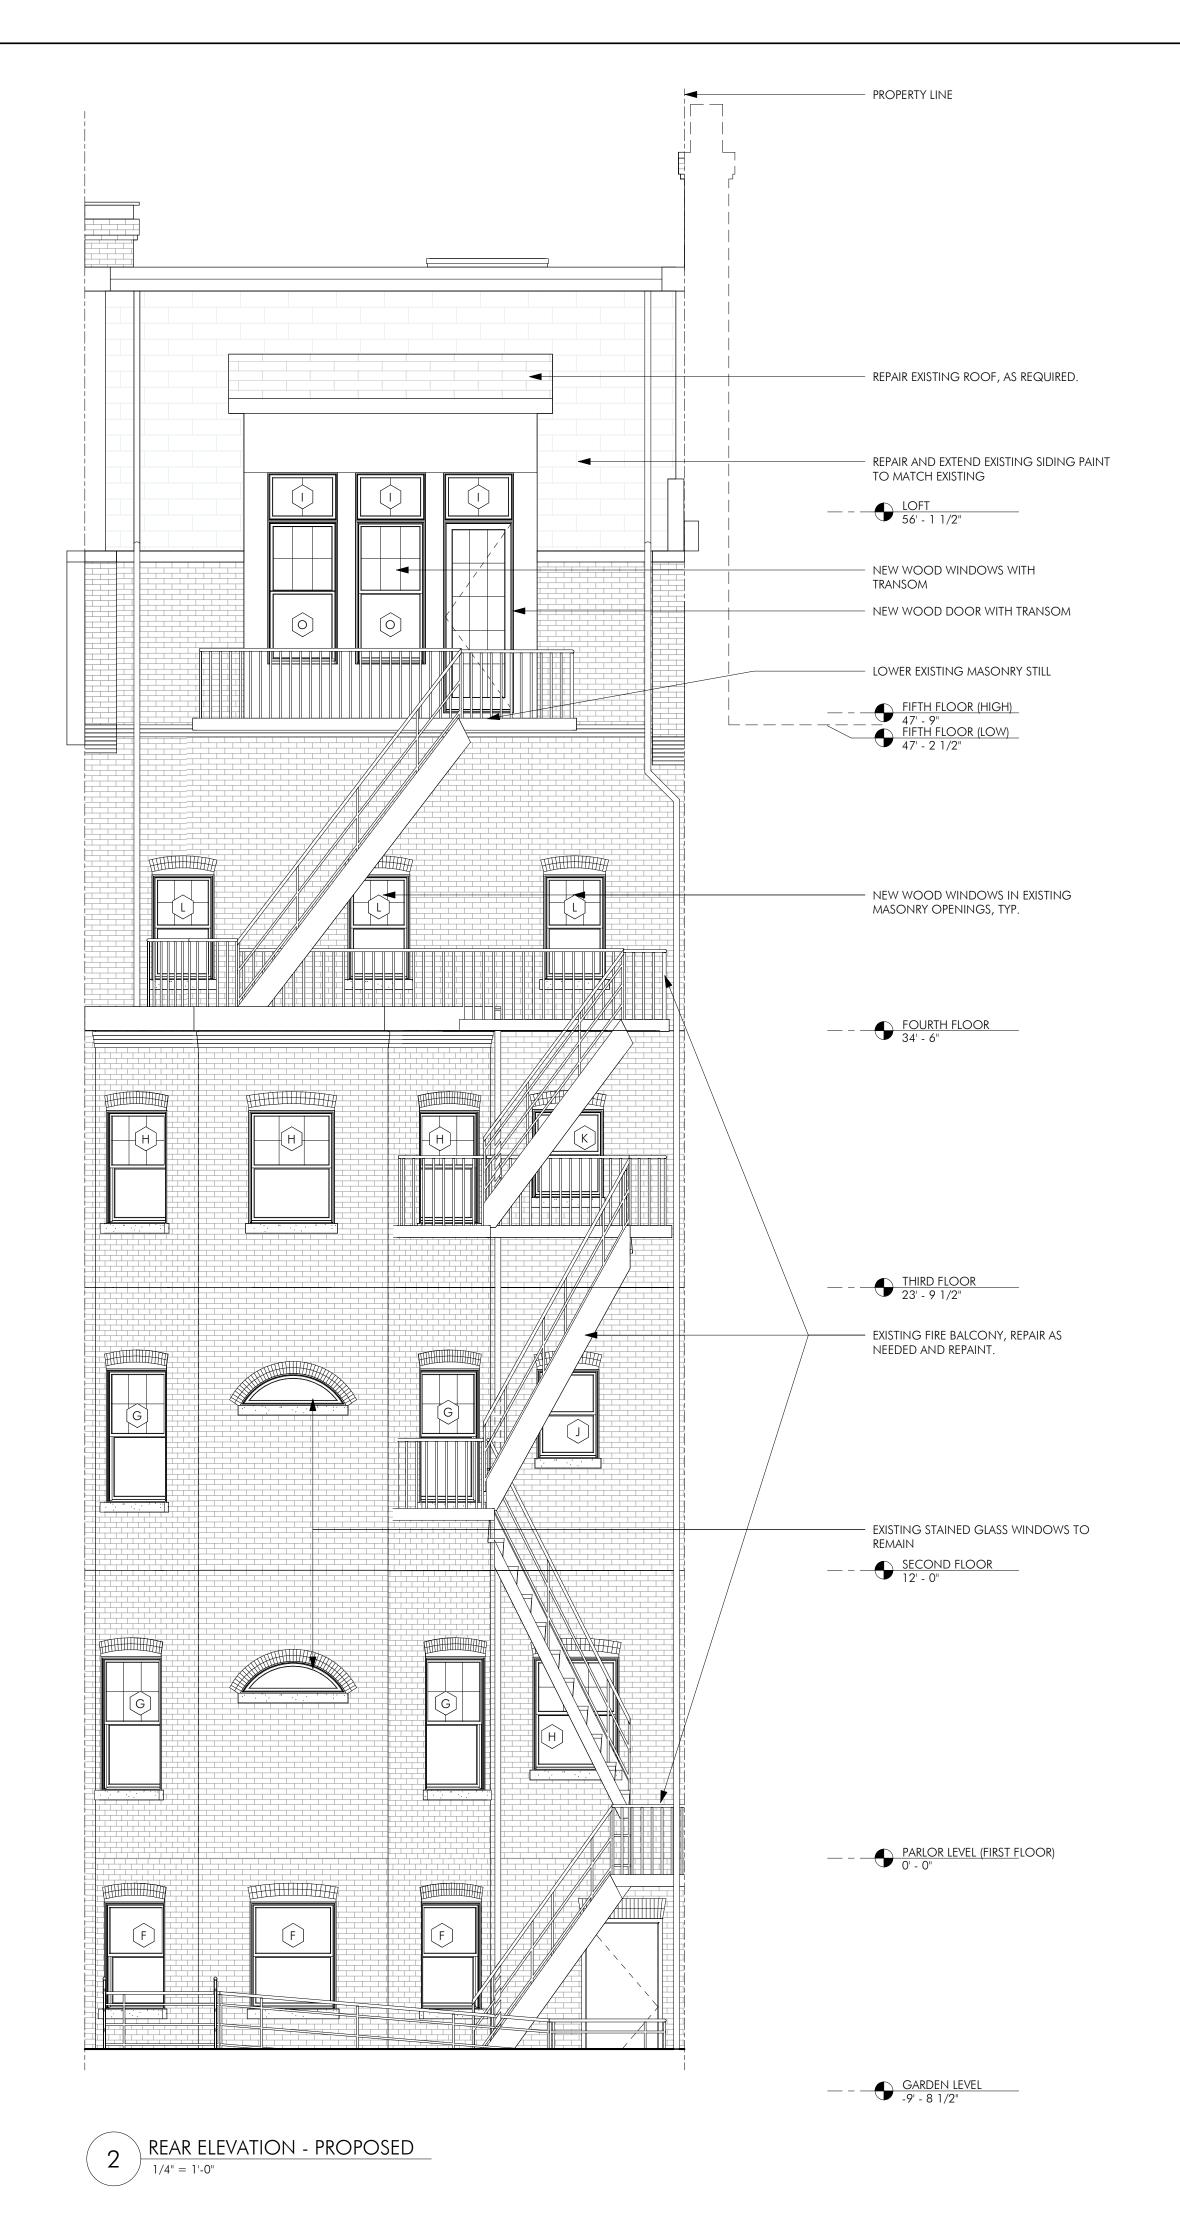

| ARCHITECT EMBARC

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CIVIL ENGINEER COLUMBIA DESIGN GROUP 14 UPHAM AVENUE BOSTON, MA 02125

ONSTRUCTION ISSUED

463 BEACC BOSTON, MA 02115 REVISIONS

STREE

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MARK ISSUE DATE




DRAWING INFORMATION


ISSUE: ISSUED FOR CONSTRUCTION

JUNE 03, 2020 PROJECT #: 19054 1/4" = 1'-0"

DRAWING TITLE BUILDING ELEVATIONS

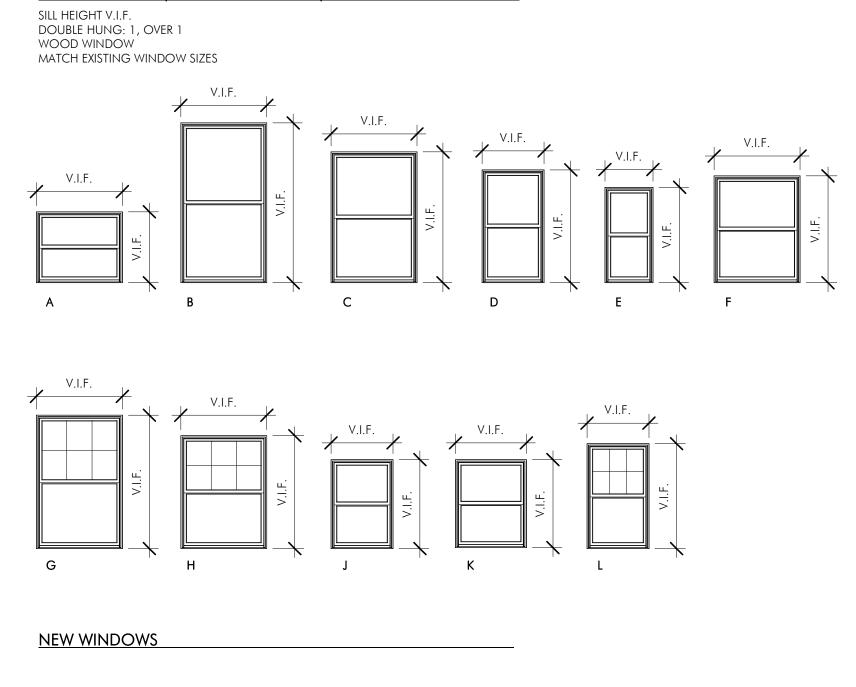

NEW WINDOWS (EXISTING OPENINGS)

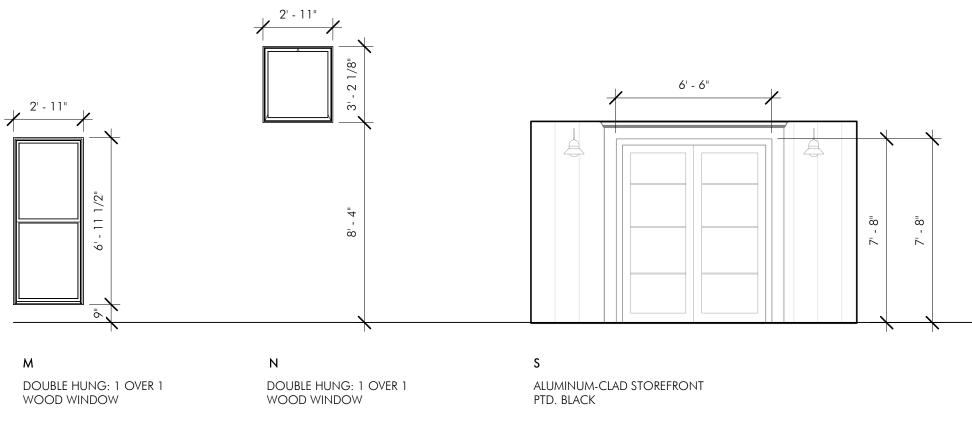


COMMON DOOR SCHEDULE


																	DOOR		FRA	AME		DETAILS				
DOOR				DOOR	DOOR	DOOR	FRAME	FRAME				FIRE RATING	HWR													
NO.	WIDTH	HEIGHT	THICKNESS	STYLE	MATERIAL	FINISH	MATERIAL	FINISH	JAMB	HEAD	SILL	(MINS.)	SET	COMMENTS												
B10	3' - 0"	7' - 0"	0' - 1 3/4"	EXIST									EVIST DOOR A	T PUBLIC ALLEY; CONTROLLED ACCESS												
B10	2' - 4"	6' - 8"	0' - 1 3/8"	C	WD	PTD	WD	PTD					LAIST DOOR A	FOBLIC ALLET; CONTROLLED ACCESS												
B13	2' - 6"	6' - 8"	0' - 1 3/8"	EXIST	1112	110	112	110					EXIST													
B14	2' - 8"	6' - 8"	0' - 1 3/8"	EXIST									EXIST													
B15	2' - 8"	6' - 8"	0' - 1 3/8"	EXIST									EXIST													
B16	3' - 0"	7' - 0"	0' - 1 3/4"	С	WD	PTD	WD	PTD				0	CONTROLLED	ACCESS												
B18	5' - 0"	7' - 0"	0' - 1 3/4"	E	WD	PTD	WD	PTD					CONTROLLED	ACCESS												
110	3' - 0"	7' - 0"	0' - 1 3/4"	EXIST									EXIST MAIN EN	TRY DOOR; CONTROLLED ACCESS												
111	4' - 0"	7' - 0"	0' - 1 3/4"	EXIST									EXIST VESTIBUL	E DOOR												
112	3' - 0"	7' - 0"	0' - 1 3/4"	В	WD	PTD	WD	PTD			•															
410	3' - 0"	7' - 0"	0' - 1 3/4"	В	WD	PTD	WD	PTD			<u> </u>			·												
411	2' - 6"	6' - 8"	0' - 1 3/8"	EXIST																						
412	2' - 10"	6' - 8"	0' - 1 3/8"	В	WD	PTD	WD	PTD					CONTROLLED	ACCESS												


UNIT DOOR SCHEDULE


					DOOR		FR	AME		DETAILS				
DOOR				DOOR	DOOR	DOOR	FRAME	FRAME				FIRE RATING	HWR	
TYPE	WIDTH	HEIGHT	THICKNESS	STYLE	MATERIAL	FINISH	MATERIAL	FINISH	JAMB	HEAD	SILL	(MINS.)	SET COMME	NTS
A1	3' - 0"	7' - 0"	0' - 1 3/4"	В	WD	PTD	WD	PTD					ROOM ENTRY DOOR; CONTROLLED) ACCESS
A2	3' - 0"	7' - 0"	0' - 1 3/4"	С	WD	PTD	WD	PTD					BREAK AWAY DOOR; ELECTRICALLY	ACTIVATED
A3	2' - 11"	8' - 0"	0' - 1 3/4"	D										
B2	3' - 0"	6' - 8"	0' - 1 3/8"	С	WD	PTD	WD	PTD					POCKET DOOR	
C3	2' - 4"	6' - 8"	0' - 1 3/8"	С	WD	PTD	WD	PTD						
C4	2' - 6"	6' - 8"	0' - 1 3/8"	С	WD	PTD	WD	PTD						
C5	2' - 8"	6' - 8"	0' - 1 3/8"	С	WD	PTD	WD	PTD						
C6	2' - 10"	6' - 8"	0' - 1 3/8"	С	WD	PTD	WD	PTD						
C7	4' - 0"	6' - 8"	0' - 1 3/8"	Е	WD	PTD	WD	PTD						
C8	3' - 0"	6' - 8"	0' - 1 3/8"	С	WD	PTD	WD	PTD						
D1	2' - 10"	6' - 8"	0' - 1 3/8"	С	WD	PTD	WD	PTD						
E1	6' - 0"	7' - 6"	0' - 1 3/4"											


DOOR STYLES

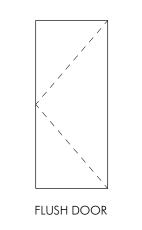


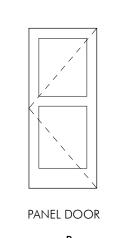

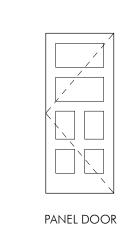

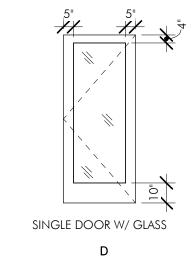

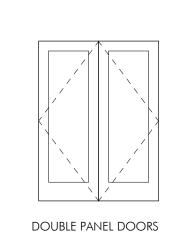

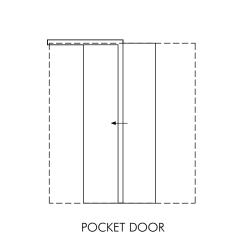

| ARCHITECT

60 K STREET, 3RD FLOOR BOSTON, MA 02127 O: 617.766.8330 www.embarcstudio.com

OWNER

FOUR 63 BEACON LLC 301 SOUTH AVE WESTON MA 02493

CONSULTANTS

SURVEYOR rj o'connell & assoc. 80 MONTVALE AVENUE STE. 201 STONEHAM, MA 02180

STRUCTURAL ENGINEER H+O STRUCTURAL ENG. 51 MELCHER ST, FLR 1 BOSTON, MA 02210

FIRE PROTECTION PLS INC.

23 SAGAMORE LN. BOXFORD, MA 01921

CIVIL ENGINEER COLUMBIA DESIGN GROUP 14 UPHAM AVENUE BOSTON, MA 02125

ONSTRUCTION 463 BEABOSTON, MA (ISSUED

REVISIONS

STREE

BEACC

MARK ISSUE DATE



DRAWING INFORMATION

ISSUE: ISSUED FOR CONSTRUCTION DATE: <u>JUNE 03, 2020</u>

PROJECT #: 19054 SCALE: 1/4" = 1'-0"

DRAWING TITLE SCHEDULES

GENERAL NOTES:

- ALL WORK SHALL CONFORM TO THE REQUIREMENTS OF THE STATE BUILDING CODE OF THE COMMONWEALTH OF MASSACHUSETTS, NINTH EDITION.
- THE CONTRACTOR SHALL VERIFY ALL DIMENSIONS AND CONDITIONS IN THE FIELD PRIOR TO COMMENCING WORK. WHERE DIMENSIONS AND ELEVATIONS OF EXISTING CONSTRUCTION COULD AFFECT THE NEW CONSTRUCTION, IT IS THE CONTRACTOR'S RESPONSIBILITY TO MAKE FIELD MEASUREMENTS IN TIME FOR THEIR INCORPORATION IN THE SHOP DRAWINGS. THE ARCHITECT AND ENGINEER SHALL BE NOTIFIED OF ANY DISCREPANCIES THAT MAY EXIST.
- SEE ARCHITECTURAL DRAWINGS FOR FLOOR ELEVATIONS, SLOPES, LOCATIONS OF DEPRESSED FLOOR AREAS, AND FLOOR OPENINGS. THE CONTRACTOR SHALL COMPARE THE STRUCTURAL DRAWINGS WITH THE ARCHITECTURAL DRAWINGS AND REPORT ANY DISCREPANCY TO THE ARCHITECT AND ENGINEER PRIOR TO CONSTRUCTION.
- PRINCIPAL OPENINGS THROUGH THE FRAMING ARE SHOWN ON THESE DRAWINGS. THE GENERAL CONTRACTOR SHALL EXAMINE THE STRUCTURAL, ARCHITECTURAL AND MECHANICAL DRAWINGS FOR THE REQUIRED OPENINGS AND SHALL VERIFY SIZE AND LOCATION OF ALL OPENINGS WITH THE MECHANICAL CONTRACTOR. PROVIDING ALL OPENINGS REQUIRED BY THE MECHANICAL, ELECTRICAL, OR PLUMBING TRADES SHALL BE A PART OF THE GENERAL CONTRACT, WHETHER OR NOT SHOWN IN THE STRUCTURAL DRAWINGS. ANY DEVIATION FROM THE OPENINGS SHOWN ON THE STRUCTURAL DRAWINGS SHALL BE BROUGHT TO THE ENGINEER'S ATTENTION FOR REVIEW. WORK NOT INDICATED ON A PART OF THE DRAWINGS BUT REASONABLY IMPLIED TO BE SIMILAR TO THAT SHOWN AT CORRESPONDING PLACES, SHALL BE
- INCLUDED IN THE CONTRACTOR'S WORK. THE CONTRACTOR SHALL BE COMPLETELY RESPONSIBLE FOR THE SAFETY OF ADJACENT STRUCTURES, PROPERTY, HIS WORKMEN, AND THE PUBLIC, AS AFFECTED BY THE CONSTRUCTION OF THIS PROJECT.
- STRUCTURAL DRAWINGS MAY REPRESENT CONSTRUCTION WITH A REFERENCE SCALE. DUE TO THE INHERENT PROCESS OF DRAWING DEVELOPMENT AND PRESENTATION NOT ALL WORK MAY BE SHOWN "EXACT" IN THAT SCALE. DO NOT "SCALE" DRAWINGS TO OBTAIN ANY MISSING INFORMATION OR TO INTERPRET ANY INFORMATION NOT SPECIFICALLY DIMENSIONED FOR "EXACT" DETAILING OR CONSTRUCTION PURPOSES.
- THE CONTRACT DOCUMENTS REPRESENT FINAL CONDITIONS. STABILITY OF THE STRUCTURE DURING CONSTRUCTION IS THE SOLE RESPONSIBILITY OF THE CONTRACTOR. THIS RESPONSIBILITY, INCLUDES, BUT IS NOT LIMITED TO, THE DESIGN AND FURNISH OF TEMPORARY SUPPORTS, SHORING AND/OR BRACING REQUIRED FOR SAFETY AND STABILITY DURING CONSTRUCTION.

LVL, PSL, GLULAM (GL) LUMBER:

- "LVL" LUMBER SHALL BE FABRICATED FROM ULTRASONICALLY GRADED SOUTHERN PINE VENEERS IN ACCORDANCE WITH NER 126.
- "PSL" LUMBER SHALL BE FABRICATED FROM LONG, THIN STRANDS OF EITHER EASTERN OR WESTERN SPECIES WOOD BONDED TOGETHER WITH A MICROWAVE PROCESS.
- EASTERN "PSL" LUMBER (ES) MAY INCLUDE SOUTHERN PINE OR YELLOW POPLAR. WESTERN "PS LUMBER (WS) MAY INCLUDE DOUGLAS FIR, LODGEPOLE PINE, WESTERN HEMLOCK OR WHITE FIR.
- "PSL" LUMBER SHALL BE FABRICATED IN PARALLEL STRANDS (PSL) IN CONFORMANCE WITH NER 292.
- "GL" LUMBER SHALL BE FABRICATED FROM LAMINATED 2X LUMBER ACCORDING TO STANDARDS SET FORTH IN NDS AND OTHER APPLICABLE CODES. HEAL CUTS ON BEAMS MUST NOT OVERHANG INSIDE FACE OF SUPPORT MEMBER.
- "LVL" AND "PSL" MEMBERS SHALL BE FABRICATED WITHOUT CAMBER. GLULAM MEMBERS MAY BE CAMBERED TO REMOVE DEAD LOAD DEFLECTION. THE "LVL", "PSL" AND "GL" MEMBERS SHALL BE PROTECTED FROM THE WEATHER WHILE IN STORAGE. CARE SHALL BE EXERCISED DURING HANDLING TO PREVENT DAMAGE TO THE SAME.
- ADHESIVES SHALL COMPLY WITH ASTM D2559-76 ADHESIVES FOR STRUCTURAL LAMINATED PRODUCTS FOR USE UNDER EXTERIOR (WET USE) EXPOSURE CONDITIONS.
- PRIOR TO START OF ERECTION, VERIFY THE LOCATIONS AND ELEVATION OF ALL BEARING SURFACES AND EMBEDDED ANCHORS. REPORT ANY DEVIATIONS TO THE GENERAL CONTRACTOR. DO NOT BEGIN WORK UNTIL UNSATISFACTORY CONDITIONS ARE CORRECTED. TAKE MEASUREMENTS ON SITE AS REQUIRED FOR CORRECT FABRICATION AND INSTALLATION.
- THE MEMBERS SHALL HAVE THE FOLLOWING MINIMUM DESIGN STRESSES:
- A. SHEAR MODULUS OF ELASTICITY (G)
 - a. LVL=125,000 PSI b. PSL=112,500 PSI
- c. GL=125,000 PSI
- B. MODULUS OF ELASTICITY (E) a. LVL=2.0X106 PSI
- b. PSL=1.8X106 PSI
- c. GL=2.0X106 PSI
- C. FLEXURAL STRESS (F'B) a. LVL=2,600 PSI
 - b. PSL=2,400 PSI c. GL=2,400 PSI
- D. COMPRESSION PERPENDICULAR TO THE GRAIN (F'CPERP) a. LVL=750 PSI
- b. PSL=545 PSI
- c. GL=740 PSI
- E. COMPRESSION PARALLEL TO GRAIN (F'CPARALLEL) a. LVL=2,510 PSI
- b. PL=2,500 PSI
- c. GL=2,400 PSI F. HORIZONTAL SHEAR (FV)
- a. LVL=285 PSI
- b. PSL=190 PSI
- c. GL=290 PSI
- DRAWING LIST DRAWING # DRAWING NAME GENERAL NOTES S0.1 S1.0 PART PLANS S2.0 SECTIONS AND DETAILS I S2.1 SECTIONS AND DETAILS II

WOOD FRAMING:

- LUMBER AND ITS FASTENINGS, SHALL CONFORM TO THE NATIONAL DESIGN SPECIFICATIONS OF STRESS-GRADE LUMBER AND ITS FASTENINGS, CURRENT EDITION, AS RECOMMENDED BY THE NATIONAL FOREST PRODUCTS ASSOCIATION. CURRENT EDITION OF WOOD GRADING RULES ARE TO BE FOLLOWED. ALL CONNECTIONS SHALL CONFORM TO THE CURRENT EDITION OF THE NATIONAL DESIGN SPECIFICATION FOR WOOD CONSTRUCTION, AND THE CONTRACT DOCUMENTS.
- UNLESS OTHERWISE NOTED, ALL JOISTS, STUDS, LINTELS/HEADERS AND PLATES SHALL BE SPRUCE-PINE-FIR (SPF) NO.2 WITH Fc=1,150PSI; Fb=875PSI; Fv=135PSI; E=1,400,00PSI (MC19). SOLID WOOD POSTS SHALL BE DOUGLAS-FIR LARCH NO.2 WITH Fc=1,350 PSI. LUMBER SIZES SHOWN IN THE DRAWINGS ARE NOMINAL SIZE. ACTUAL SIZES SHALL CONFORM TO AMERICAN LUMBER STANDARD PS-20-70. MATERIALS MUST BE GRADE MARKED.
- FOR OVERLAY FRAMING AT ROOFS OR OTHER CONVENTIONAL ROOF FRAMING, CONTRACTOR SHALL PROVIDE 2X FRAMING IN ACCORDANCE WITH ROOF RAFTER TABLE IN THE APPLICABLE BUILDING CODE.
- POSTS SUPPORTING HEADERS AND BEAMS SHALL CONTINUE FROM POINT OF LOAD APPLICATION TO THE FOUNDATION
- ALL FLUSH CONNECTIONS SHALL HAVE METAL BEAM OR JOIST HANGERS ALL BEAM OVER POST CONNECTIONS SHALL HAVE A METAL POST CAP, SUCH AS
- SIMPSON LPC OR BC TYPE POST CAPS, U.N.O. BOLT HOLES THROUGH WOOD SHALL BE DRILLED 1/16" MAXIMUM LARGER THEN
- THE DIAMETER OF THE BOLTS TO BE INSTALLED. 9. BOLTS THROUGH WOOD SHALL BE FITTED WITH STANDARD WASHERS AT HEAD
- AND NUT ENDS. 10. EDGE OF A BORED HOLE SHALL NOT BE WITHIN 5/8 INCH OF THE STUDS EDGE.
- BORED HOLES SHALL NOT BE LOCATED AT CUT OR NOTCH IN THE STUDS. 11. ALL WOOD FRAMING EXPOSED TO WEATHER SHALL BE PRESERVATIVE

PRESSURE TREATED SOUTHERN PINE NO. 2 OR BETTER

- 12. FRAMING LUMBER SHALL BE SOUND, THOROUGHLY SEASONED, SURFACED FOUR SIDES. WELL MANUFACTURED AND FREE FROM WARP NOT CORRECTABLE BY BRIDGING, BLOCKING OR NAILING. MOISTURE CONTENT SHALL BE A MAXIMUM OF 19 PERCENT
- 13. WOOD STRUCTURAL PANELS SHALL BE INSTALLED WITH A 1/8" GAP BETWEEN PANEL ENDS AND EDGES.
- 14. ALL INTERIOR LOAD BEARING WALLS SHALL HAVE ONE ROW OF BLOCKING AT THE MID-HEIGHT OF THE STUDS. ANY WALL THAT IS NOT SHEATHED ON BOTH SIDES WITH EITHER WOOD STRUCTURAL PANELS OR GYPSUM BOARD, SHALL HAVE WOOD BLOCKING SPACED AT NO MORE THAN 4'-0" O.C.
- WOOD JOISTS JOISTS SHALL BE TOE NAILED TO WOOD SUPPORT WITH TWO 10D
- WOOD JOISTS SHALL HAVE MINIMUM BEARING OF 1 1/2"
- 17. WOOD JOIST ENDS SHALL BE LAPPED OVER BEARING AND NAILED TOGETHER WITH 3-16D NAILS; MINIMUM LAP, 4".
- JOIST OVERHANG SHALL NOT EXCEED 12" UNLESS OTHERWISE NOTED
- JOIST BRIDGING SHALL BE PROVIDED AT ALL JOIST SPANS EXCEEDING 8FT AND BE INSTALLED IN AN OFFSET FASHION. MAXIMUM SPACING = 8FT. JOIST BLOCKING SHALL BE FULL DEPTH TO MATCH THE JOIST DEPTH
- AT FLOOR OPENING UP TO 2'-0" IN WIDTH, DOUBLE THE JOISTS AT EACH SIDE OF THE OPENING. AT LARGER OPENINGS NOT SHOWN ON THE FRAMING PLAN SHALL BE CALLED TO THE ATTENTION OF THE E.O.R.
- 21. BUILT-UP STUDS COLUMNS SHALL BE NAILED TOGETHER AS FOLLOWS (D=NAIL 22. POST NAILING - ADJACENT NAILS SHALL BE DRIVEN FROM OPPOSITE SIDES OF
- POST NAILING ALL NAILS SHALL PENETRATE ALL LAMINATIONS AND AT LEAST 3/4
- THE THICKNESS OF THE OUTERMOST LAMINATION. 24. POST NAILING - THE NAIL END DISTANCE FROM THE END OF COLUMN SHALL BE
- BETWEEN 15D AND 18D 25. POST NAILING - THE SPACING BETWEEN ADJACENT NAILS IN A ROW SHALL NOT
- THINNEST LAMINATION) 26. POST NAILING - THE SPACING BETWEEN ROWS OF NAILS SHALL BE BETWEEN 10D

BE GREATER THAN EITHER 20D OR 6*TMIN (WHERE TMIN=THICKNESS OF THE

- AND 20D POST NAILING - THE NAIL EDGE DISTANCE SHALL BE BETWEEN 5D AND 20D POST NAILING - PROVIDE 2 LONGITUDINAL ROWS OF NAILS MINIMUM.
- SOLE PLATES SHALL BE NAILED TO SUBFLOOR AND JOISTS WITH 16D NAILS AT EACH JOIST. SEE SHEAR WALL NAILING SCHEDULES FOR ADDITONAL NAILING REQUIREMENTS.
- TOP PLATES FOR BEARING PARTITIONS SHALL BE TWO 2x (STUD WALL DEPTH) OR A CONTINUOUS HEADER. PLATE MEMBERS OF PRINCIPAL PARTITIONS SHALL BE LAPPED A MINIMUM OF 48" AND NAILED WITH (16)-16D STAGGERED. WHERE 48" LAP CANNOT BE ACHIEVED, A CS16 STRAP WITH (22)-10D NAILS SHOULD BE USED TO SPLICE THE PLATE.
- TOP PLATES FOR NON-BEARING PARTITIONS MAY BE SINGLE. NAIL PLATE TO STUD WITH TWO 16D NAILS. WHEN TOP PLATE IS PARALLEL TO CEILING OR FLOOR FRAMING INSTALL 2 X 4 CROSS BLOCKING NOT MORE THAN 4'-0"O.C.
- WHEN TOP PLATES ARE CUT FOR PIPING OR DUCT WORK, REINFORCE WITH STEEL STRAPS.
- SILL PLATES AT BEARING DIRECTLY ON CONCRETE SHALL BE PRESSURE
- TREATED LUMBER, 0.25CCA MINIMUM SOUTHERN PINE NO.2 OR BETTER. BEAMS AND GIRDERS WILL NOT REST LESS THAN 4" ON SUPPORTS
- WHERE BEAMS AND GIRDERS OF NOMINAL 2" MEMBERS ARE SPECIFIED, NAIL TOGETHER WITH TWO ROWS OF 16D NAILS SPACED NOT MORE THAN 24"O.C., LOCATE END JOISTS IN MEMBERS OVER SUPPORTS. ALL BEAMS MUST SPLICE ONLY OVER SUPPORTS UNLESS SPECIFICALLY
- INSTRUCTED OTHERWISE BY STRUCTURAL ENGINEER. ALL BUILT-UP WOOD BEAMS WIDER THAN 6"WILL BE BOLTED WITH 5/8"DIAMETER THROUGH-BOLTS AT 2'-0" O.C. STAGGERED SPACING, UNLESS OTHERWISE
- ALL INTERIOR WALLS SHALL HAVE A JOIST LOCATED DIRECTLY BELOW (AT
- PARALLEL WALLS) OR CONTINUOUS BLOCKING (AT PERPENDICULAR WALLS).
- NAILING INSTALLATION AND MATERIAL ARE TO BE IN COMPLIANCE WITH A.I.T.C., NDS AND IN ACCORDANCE WITH THE APPLICABLE LOCAL BUILDING CODE. 40. NAILS SHALL HAVE A MINIMUM PENETRATION OF 6 TIMES THE WIRE DIAMETER
- UNLESS OTHERWISE NOTED ON PLANS. 41. EDGE DISTANCE FOR ALL NAILS SHALL BE MINIMUM OF 2 TIMES THE WIRE DIAMETER UNLESS OTHERWISE NOTED ON PLANS.
- ALL NAILS SHOWN IN NAILING SCHEDULE SHALL BE COMMON. THREADED, HARDENED STEEL NAILS MAY BE SUBSTITUTED FOR COMMON SIZE NAILS OF CORRESPONDING SIZE FOR PLYWOOD. USE ANNULAR-RING, COMMON WIRE GALVANIZED NAILS FOR PLYWOOD. GALVANIZED NAILS SHALL BE HOT-DIP GALVANIZED. ASTM-A153.
- 43. ALL FASTENERS USED IN PRESSURE TREATED WOOD SHALL BE COATED, TREATED, AND APPROVED FOR USE IN PRESSURE TREATED WOOD.
- 44. ALL FASTENERS USED IN FIRE TREATED LUMBER SHALL BE COATED AND APPROVED FOR THAT USE BY THE MANUFACTURER.
- BORED HOLES IN WOOD STUD WALLS SHALL NOT EXCEED A DIAMETER GREATER THAN 40% OF THE STUD DEPTH, I.E. 2x4 SHALL NOT HAVE A HOLE GREATER THAN 1 3/8" DIAMETER. HOLE EDGE SHALL BE 5/8" CLEAR OF STUD EDGE. WOOD POSTS SHALL NOT HAVE BORED HOLES WITHOUT APPROVAL FROM E.O.R.

STRUCTURAL STEEL:

- 1. STRUCTURAL STEEL DESIGN CONFORMS TO THE AISC SPECIFICATION FOR
- STRUCTURAL STEEL BUILDING, THIRTEENTH EDITION. 2. STRUCTURAL STEEL WORK SHALL CONFORM TO AISC 360-10 "SPECIFICATION FOR STRUCTURAL STEEL BUILDINGS", AISC 303-10 "CODE OF STANDARD PRACTICE FOR STEEL BUILDING & BRIDGES", AND AISC 341-10 AND SUPPLEMENTS "SEISMIC PROVISIONS FOR STRUCTURAL STEEL BUILDINGS"
- STRUCTURAL STEEL SHALL BE NEW MATERIAL THAT SATIFIES THE PROPERTY REQUIREMENTS INDICATED IN THE "STRUCTURAL STEEL MATERIAL PROPERTIES" SCHEDULE.
- 4. ALL STEEL SHALL BE COATED WITH SHOP PRIMER UNLESS STEEL IS TO BE FIREPROOFED (SEE ARCH DRAWINGS)
- 5. ALL STEEL EXPOSED TO WEATHER SHALL BE HOT DIP GALVANIZED. FIELD WELDS OF GALVANIZED MEMBERS SHALL BE TOUCHED UP USING A ZINC RICH PRIMER AFTER COMPLETION AND INSPECTION OF THE WELD
- INFILL BEAMS SHALL BE SPACED EQUALLY BETWEEN ESTABLISHED DIMENSIONS, U.N.O.
- ALL SHOP AND FIELD WELDS TO CONFORM TO AWS D1.1-04 "STRUCTURAL WELDING
- 8. WELDED CONNECTIONS SHALL BE MADE BY CERTIFIED WELDERS USING FILLER
- METAL CONFORMING TO E70XX OR F7X-EXXX WITH LOW HYDROGEN. 9. WELDS SHALL DEVELOP THE FULL STRENGTH OF THE MATERIALS BEING WELDED,
- 10. ALL WELD SIZES SHALL BE THE MINIMUM REQUIRED SIZE BASED ON THE THICKNESS OF THE THICKER PART ACCORDING TO AISC TABLE J2.3 & J2.4.
- 11. ALL FILLET WELDS SHALL BE 1/4" THICK MINIMUM.
- 12. ALL AROUND WELDS SHALL BE DISCONTINUOUS AT THE FLANGE TIPS OF OPEN
- 13. MEMBER SPLICES SHALL BE DESIGNED AND DETAILED TO DEVELOP THE FULL STRENGTH OF THE MEMBER OR COMPONENTS BEING CONNECTED
- 14. STRUCTURAL STEEL DETAILS NOT SPECIFICALLY SHOWN SHALL BE TAKEN AS BEING SIMILAR TO THAT SHOWN IN CORRESPONDING CONDITIONS.
- DETAILS AND CONNECTIONS EXPLICITLY DETAILED IN THE CONTRACT DRAWINGS MAY NOT BE ALTERED WITHOUT WRITTEN APPROVAL BY THE ENGINEER. ALTERED CONNECTIONS SHALL BE COMPLETELY DETAILED AND DESIGNED BY THE FABRICATOR'S ENGINEER AND CLEARLY MARKED ON THE SHOP DRAWINGS
- SUBMIT CALCULATIONS FOR CONNECTION DESIGNS NOT FULLY DETAILED ON DRAWINGS. DESIGN CONNECTIONS UNDER SUPERVISION OF REGISTERED PROFESSIONAL ENGINEER, REGISTERED IN THE STATE WHERE PROJECT IS BEING CONSTRUCTED, EMPLOYED BY THE STEEL FABRICATOR. DESIGN CALCULATIONS TO BE SEALED BY FABRICATOR'S REGISTERED PROFESSIONAL ENGINEER. SHOP DRAWINGS SUBMITTED WITHOUT COMPLETE DESIGN CALCULATIONS WILL NOT BE REVIEWED.
- WIDE FLANGE BEAM-TO-BEAM AND BEAM-TO-COLUMN CONNECTIONS SHALL MEET OR EXCEED THE FACTORED SHEAR DESIGN STRENGTH REQUIREMENTS (LRFD)(KIPS) INDICATED IN THE "WF BEAM FACTORED SHEAR DESIGN STRENGTH" SCHEDULE.
- 18. BEAM REACTIONS (Ru = "XX" KIPS INDICATED IN THE DRAWINGS SUPERSEDE THE 19. SEATED BEAM CONNECTIONS ARE NOT ALLOWED UNLESS USED FOR ERECTION
- PURPOSES ONLY 20. THE MINIMUM THICKNESS FOR A STRUCTURAL CONNECTION PLATE IS 3/8".
- BEAM AND GIRDER SHEAR CONNECTIONS TO COLUMNS SHALL BE DESIGNED AND
- DETAILED TO BE CAPABLE OF END ROTATION PER AISC. 22. CONNECTIONS WITH AXIAL LOAD THROUGH-FORCES AS INDICATED ON PLAN, SHALL BE DESIGNED FOR SHEAR AND AXIAL FORCES SIMULTANEOUSLY.
- TENSION AND COMPRESSION MEMBER END CONNECTIONS SHALL DEVELOP THE FORCE DUE TO THE POSTED DESIGN LOAD. BUT NOT LESS THAN 100% OF THE TENSION CAPACITY OF THE MEMBER WHERE NO DESIGN LOAD IS POSTED. THE TENSION CAPACITY SHALL BE APPLIED AS A LOAD IN BOTH TENSIONS AND
- 24. ALL BOLTED STRUCTURAL CONNECTIONS SHALL BE MADE WITH 3/4" DIAMETER A325 BOLTS, MINIMUM.
- 25. ALL STRUCTURAL BOLTS SHALL BE TENSION CONTROLLED AS SPECIFIED IN AISC MANUAL TABLE J3.1 (14TH ED).
- 26. STRUCTURAL BOLTS CONFINED BY STRUCTURE GEOMETRY THAT CANNOT BE INSTALLED USING CONTROLLED BOLT TENSION, SHALL BE HAND TIGHTENED USING A WRENCH AND CLEARLY MARKED ON THE STRUCTURAL STEEL AS "HT". 27. PROVIDE FULL-DEPTH WELDED STIFFENER PLATES ON BOTH SIDES OF A BEAM WEB
- UNDER CONCENTRATED LOAD DUE TO A BEAM OVER COLUMN, COLUMN UP, OR STRUCTURAL HANGER CONDITION. 28. RECTANGULAR HSS MEMBERS ARE TO BE ORIENTED LLV U.N.O.
- 29. ALL HSS SHAPES, EXCEPT DIAGONAL BRACING MEMBERS, ARE TO HAVE 1/4" CAP PLATES, FULLY SEAL WELDED ALL AROUND.
- 30. FIELD MODIFICATIONS OF STRUCTURAL STEEL MEMBERS AND CONNECTIONS, SHALL NOT BE MADE WITHOUT APPROVAL FROM THE ENGINEER. BEAMS ARE NOT DESIGNED TO SUPPORT LATERAL LOADS, OR OUT-OF-PLANE
- BENDING, AT THE BOTTOM FLANGE THAT MAY RESULT OTHER TRADES. BEAMS SHALL BE BRACED OR SUPPORTED TO RESIST SUCH FORCES. 32. BEAM WEB PENETRATIONS OR COPES REQUIRED FOR COORDINATION WITH OTHER
- TRADES SHALL BE SHOWN ON THE SHOP DRAWINGS AND MADE IN THE SHOP WHENEVER POSSIBLE. 33. SPLICING OF STRUCTURAL MEMBERS IS PROHIBITED WITHOUT PRIOR APPROVAL OF

MORE THAN 4'-0" O.C. ALONG THE MEMBER LENGTH.

THE ENGINEER UNLESS SPECIFICALLY INDICATED IN THE CONTRACT DRAWINGS. 34. DOUBLE ANGLE OR CHANNEL MEMBERS SHALL HAVE BOLTS PLATE SPACERS AT NO

MASONRY STEEL LINTEL SCHEDULE								
OPENING WIDTH	<u>4" WALL</u>	<u>6" WALL</u>	<u>8" WALL</u>	<u>12" WALL</u>				
L < 5'-0"	L4x3 1/2x5/16	L6x6x5/16	(2)-L4x3 1/2x5/16	(2)-L6x6x5/16				
5'-0" < L < 7'-0"	L5x3 1/2x5/16	L6x6x5/16	(2)-L5x3 1/2x5/16	(2)-L6x6x5/16				
7'-0" < L < 9'-0"	L6x3 1/2x3/8	L6x6x3/8	(2)-L6x3 1/2x3/8	(2)-L6x6x3/8				
9'-0" < L < 12'-0"	L6x3 1/2x1/2	L6x6x1/2	(2)-L6x3 1/2x1/2	(2)-L6x6x1/2				

1. LINTELS THAT ARE PART OF THE EXTERIOR WALL $\,$ ASSEMBLY OR EXPOSED TO WEATHER SHALL BE HOT DIPPED GALVANIZED.

5. AT WALLS THICKER THAN 12" PROVIDE ONE LINTEL PER EACH 4" OR 6" OF WALL THICKNESS PER THE TABLE ABOVE. FOR


LINTELS SHALL HAVE A MINIMUM 8" BEARING ON EACH SIDE OF OPENING. 3. LINTELS IN PAIRS SHALL BE STITCH WELDED TOGETHER AT 18" O.C.

EXAMPLE, AN 18" THICK WALL WITH AN 6'-0" OPENING REQUIRES (3)-L6X6X5/16

4. PROVIDE LINTELS FOR MASONRY OPENINGS IN ACCORDANCE WITH THIS SCHEDULE UNLESS SHOWN OTHERWISE ON DRAWINGS.

GRID LINES WALL TYPE **BEARING** WALL · WALL TYPE WOOD SHEAR WALL TOS EL. 1'-0" TOP OF STEEL **ELEVATION** MARKER TOC EL. 1'-0" TOP OF CONCRETE ELEVATION MARKER A101 / **SECTION CUT** PLAN DETAIL STEEL BEAM OR LVL STEEL BEAM WITH MOMENT END CONNECTION STEEL BEAM WITH EMBED PLATE CONNECTION FULL DEPTH STIFFENER CONNECTION BEAM PENETRATION 12"Hx20"W TYPE R STEEL BEAM WITH BEARING PLATE SPLICE BASE PLATE 2-WAY SLAB OR SLAB-ON-GRADE **INDICATES** COLUMN BELOW CONCRETE COLUMN-

ABBREVIATIONS: AMERICAN CONCRETE INSTITUTE ADDL ADDITIONAL AMERICAN INSTIT. OF STEEL CONSTR. ALTERNATE ARCHITECT ALLOWABLE STRESS DESIGN AMERICAN WELDING SOCIETY **BRACED FRAME** BOT BOTTOM BOF BOTTOM OF FOOTING BEARING BUILDING CB **CONCRETE BEAM CAST-IN-PLACE** CENTERLINE CL **CONCRETE MASONRY UNIT** COLUMN CONCRETE CONC **CONSTRUCTION JOINT** CONT CONTINUOUS CNTR CENTERED DRILL AND EPOXY DEPR DEPRESSION DET DETAIL DIAMETER DIAMETER DIM DIMENSION DIR **DIRECTION** DN DOWN DO DITTO DRAWING DWLS **DOWELS EXISTING** EACH EACH END

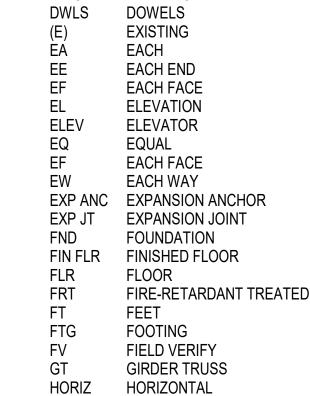

HIGH POINT HOLLOW STRUCTURAL SECTION INTERNATIONAL BUILDING CODE INSIDE DIAMETER INCH KIP=1000 LBS LLV LONG LEG VERTICAL LLH LONG LEG HORIZONTAL LOW POINT

NEW

NUMBER

OPENING

PILE CAP

REFERENCE

REINFORCING

SLAB-ON-GRADE

STAINLESS STEEL

TOP AND BOTTOM

TOP OF CONCRETE

UNLESS NOTED OTHERWISE

TOP OF STEEL

TOP OF WALL

VERIFY IN FIELD

WELDED WIRE FABRIC

WORKPOINT

TYPICAL

WITH

RETAINING

STANDARD

STEEL

TOP OF

TIE-BEAM

THICK

TOP

SHEET

SIMILAR

PLATE

POST-TENSIONED

OPEN-WEB JOIST/TRUSS (PREFABRICATED)

PRECAST CONCRETE INSTITUTE

POUNDS PER SQUARE FOOT

POUNDS PER SQUARE INCH

LONG SIDE VERTICAL LSH LONG SIDE HORIZONTAL LWC LIGHTWEIGHT CONCRETE MECH MECHANICAL MEZZ

MF

NO.

NTS

NWC

O.C.

OD

OPG

OWJ

PCI

PSF

PSI

REF

REINF

RETG

SHT

SIM

SS

STD

STL

T.O.

T&B

TB

THK

TOW

TYP

UNO


VIF

CONNECTION COLUMN SPLICE AND BASE PLATE

WOOD JOIST WITH JOIST HANGER

FLOOR TYPE AND SPAN DIRECTION



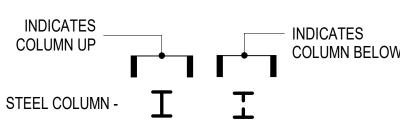

WOOD COLUMN -HSS COLUMN-

_ 2 LOAD RESISTANCE FACTOR DESIGN \Box MECHANICAL. ELECTRICAL. PLUMBING 9 **MEZZANINE** 4 MOMENT FRAME **NOT IN CONTRACT** REVISIONS NOT TO SCALE MARK ISSUE NORMAL WEIGHT CONCRETE ON CENTER **OUTSIDE DIAMETER**

Ш S S

ARCHITECT

BOSTON, MA 02127

www.embarcstudio.com

FOUR 63 BEACON LLC

301 SOUTH AVE WESTON MA 02493


O: 617.766.8330

CONSULTANTS

DRAWING INFORMATION ISSUED FOR CONSTRUCTION DATE: JANUARY 30, 2020 PROJECT #: 19054

SCALE: As indicated DRAWING TITLE GENERAL NOTES

DRAWING NUMBER

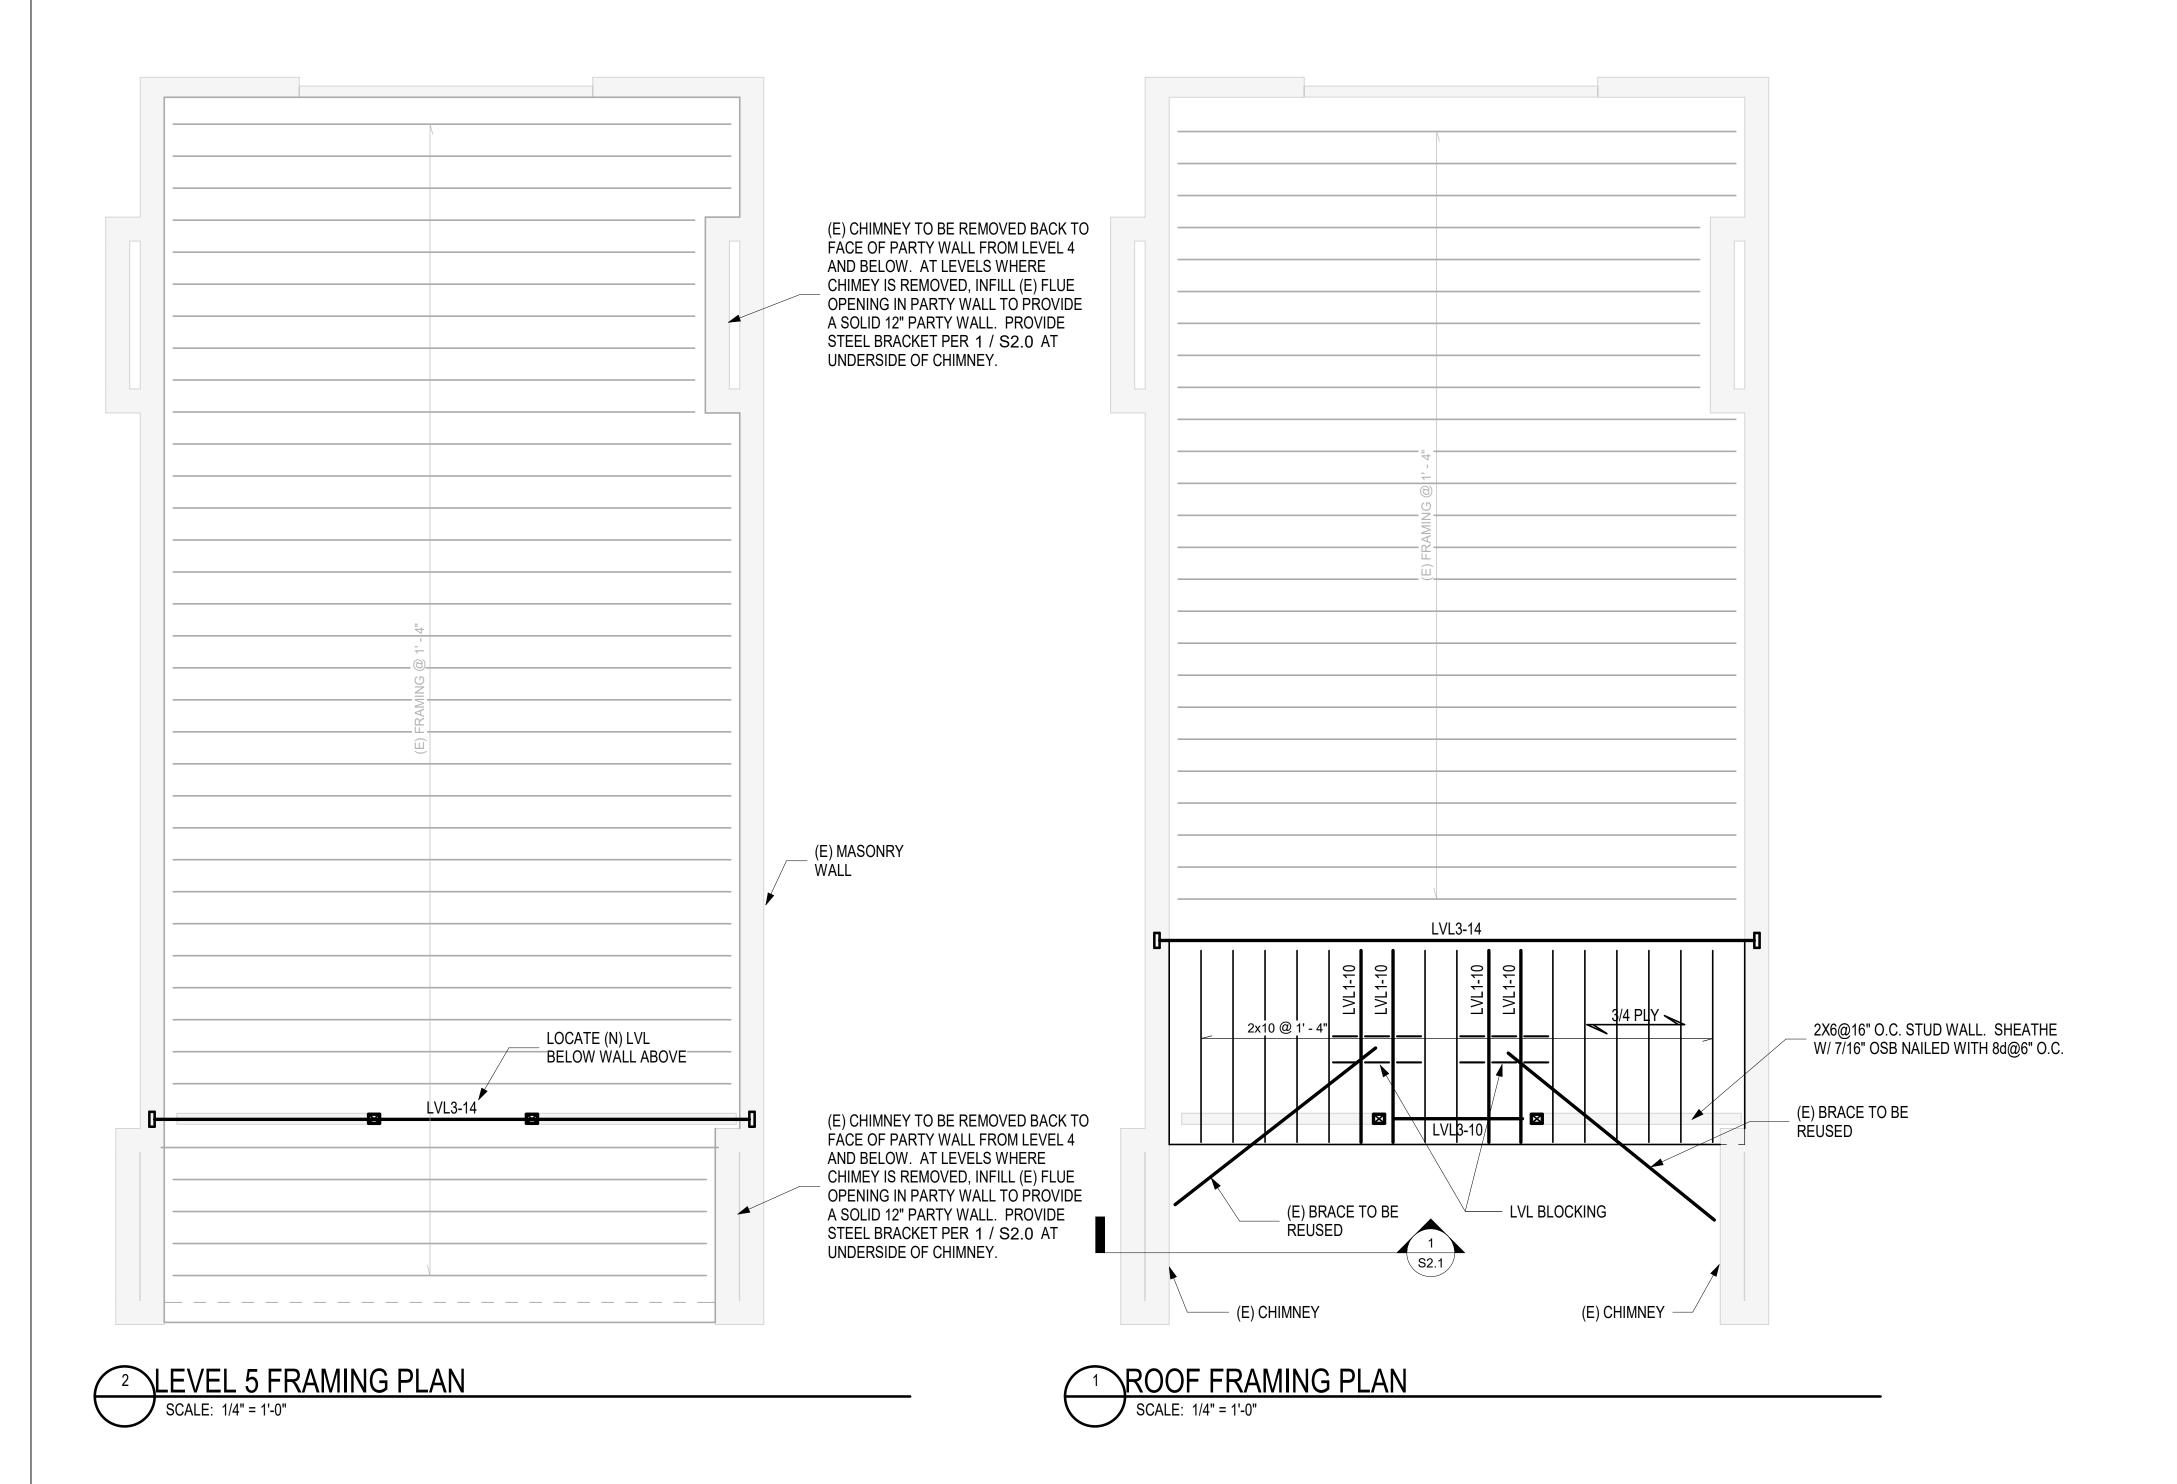

PLAN NOTES:

SEE SO SERIES FOR GENERAL NOTES

SEE S2 SERIES FOR SECTIONS AND DETAILS

ALL DIMENSIONS SHALL BE VERIFIED WITH THE ARCHITECT AND ARCHITECTURAL DRAWINGS

ALL HEADERS AT 2X4 WALLS SHALL BE (2)-2X10, UNLESS OTHERWISE NOTED.

ALL HEADERS AT 2X6 WALLS SHALL BE (3)-2X10, UNLESS OTHERWISE NOTED

xJS - INDICATES NUMBER OF JACK STUDS. REFER TO TYPICAL HEADER DETAIL FOR CONFIGURATION AND KING STUD QUANTITIES. TOTAL STUD COUNT= JACK STUD QUANTITY + KING STUD QUANTITY. IF JACK STUD QUANTITY IS NOT NOTED ON PLAN, HEADER SHALL BE SUPPORTED BY (1) JACK STUD (REFER TO DETAIL FOR KING STUD QUANTITY).

WOOD FLOOR BEAMS SHALL BE SUPPORTED WITH THE FOLLOWING MINIMUM POST SIZES (U.N.O.ON PLAN): DOUBLE 2x BEAM=(2)-2x4 POST OR (2)-2x6 POST, TRIPLE 2x BEAM=(3)-2x4 POST OR (3)-2x6 POST, DOUBLE LVL BEAMS=(3)-2x4 POST OR (3)-2x6 POST, TRIPLE LVL BEAMS=(4)-2x4 POST OR (4)-2x6 POST. ALL POSTS SHALL BE CONNECTED TO BEAMS WITH POST CAPS SUCH AS SIMPSON BCS OR LPCZ. POST SIZE SHALL MATCH WALL STUD DEPTH, (I.E. 2x4 POSTS AT 2x4 WALLS).

WITH THE EXCEPTION OF HEADERS OVER DOOR AND WINDOW OPENINGS, ALL BEAMS SHOWN ON PLAN ARE TO BE FLUSH WITH FLOOR FRAMING UNLESS NOTED OTHERWISE.

ONLY MAJOR FLOOR OPENINGS ARE SHOWN ON STRUCTURAL PLANS. REFER TO THE ARCHITECTURAL AND MECHANICAL DRAWINGS FOR ALL OTHER FLOOR OPENINGS. SEE THE TYPICAL FLOOR OPENING REINFORCING DETAILS FOR STRUCTURAL REQUIREMENTS. LOCATIONS SHOWN ON STRUCTURAL PLANS SHALL BE VERIFIED WITH ARCHITECTURAL DRAWINGS.


10. LVL3-12 - INDICATES THE NUMBER AND DEPTH OF LVL BEAM (FOR INSTANCE LVL3-12 INDICATES 3-PLY 1 3/4"X11 7/8"). ALL LVL PLYS SHALL BE 1 3/4" THICK. LVL DEPTH SHALL BE AS NOTED IN CALLOUT EXCEPT: 6=5 1/2" ACTUAL DEPTH, 8=7 1/4" ACTUAL DEPTH, 10=9 1/2" ACTUAL DEPTH, 12=11 7/8" ACTUAL DEPTH.

11. THE EXISTING FRAMING REPRESENTED ON THE STRUCTURAL PLANS IS FOR REFERENCE ONLY AND MAY NOT BE AN EXACT REPRESENTATION OF THE EXISTING CONDITIONS. ALL EXISTING STRUCTURAL ELEMENT CONFIGURATIONS, SIZES, MATERIALS, AND CONDITION SHALL BE VERIFIED IN THE FIELD BY THE CONTRACTOR.

12. ALL DIMENSIONS OF EXISTING STRUCTURAL ELEMENTS SHALL BE VERIFIED IN THE FIELD PRIOR TO

FABRICATION AND INSTALLATION.

13. ALL SHORING AND TEMPORARY SUPPORT NEEDED TO SAFELY ACCOMPLISH DEMOLITION WORK AND INSTALLATION OF THE PERMANENT FRAMING IS THE SOLE RESPONSIBILITY OF THE CONTRACTOR. THE CONTRACTOR SHALL ENGAGE A SPECIALTY ENGINEER FOR THE REVIEW AND DEVELOPMENT OF A SAFE SHORING AND DEMOLITION PLAN AS NEEDED.

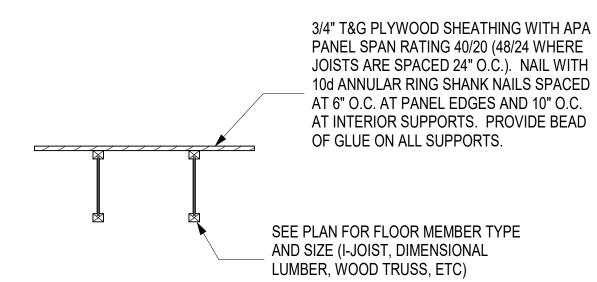

3/4" T&G FLOOR (3/4" PLY)

ARCHITECT

BOSTON, MA 02127

OWNER

O: 617.766.8330 www.embarcstudio.com

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REVISIONS MARK ISSUE DATE

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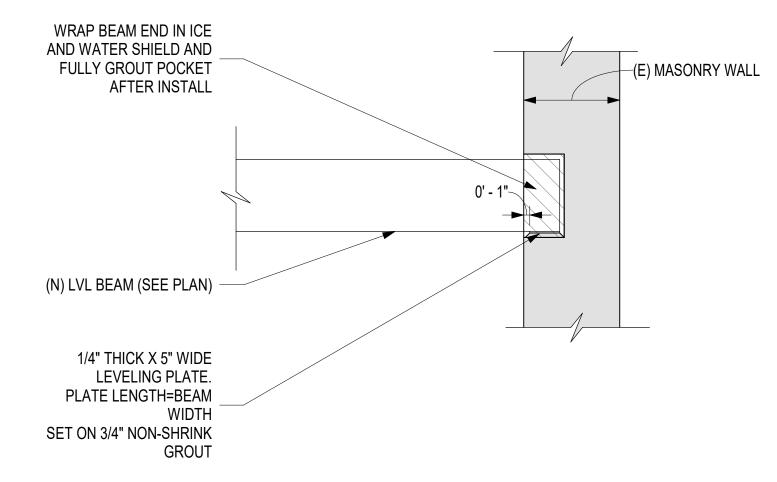
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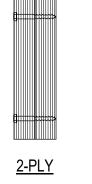
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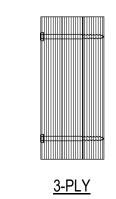
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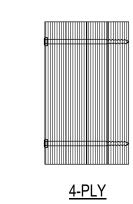
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² TYPICAL LVL BEAM POCKET IN BRICK MASONRY SCALE: 3/4" = 1'-0"







NOTES:
1. ALL SCREWS ARE STRONG-DRIVE SDW EWP SCREWS SPACED AT 16" O.C. 2. SCREW LENGTHS ARE AS FOLLOWS:

-2 PLY=3 3/8" -3 PLY=5"

-4 PLY=6 3/4" 3. PROVIDE NUMBER OF FASTENER ROWS AS FOLLOWS:

-9 1/2" LVL=2 ROWS -11 1/2" OR 11 7/8" LVL=3 ROWS

-14" LVL=3 ROWS -16" LVL AND GREATER=4 ROWS

SCALE: 3/4" = 1'-0"

3 TYPICAL ATTACHMENT OF MULTI-PLY LVLS
SCALE: 1 1/2" = 1'-0"

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OWNER

FOUR 63 BEACON LLC 301 SOUTH AVE WESTON MA 02493

CONSULTANTS

NSTRUC ISSUED 463 B BOSTON,

STREE⁻

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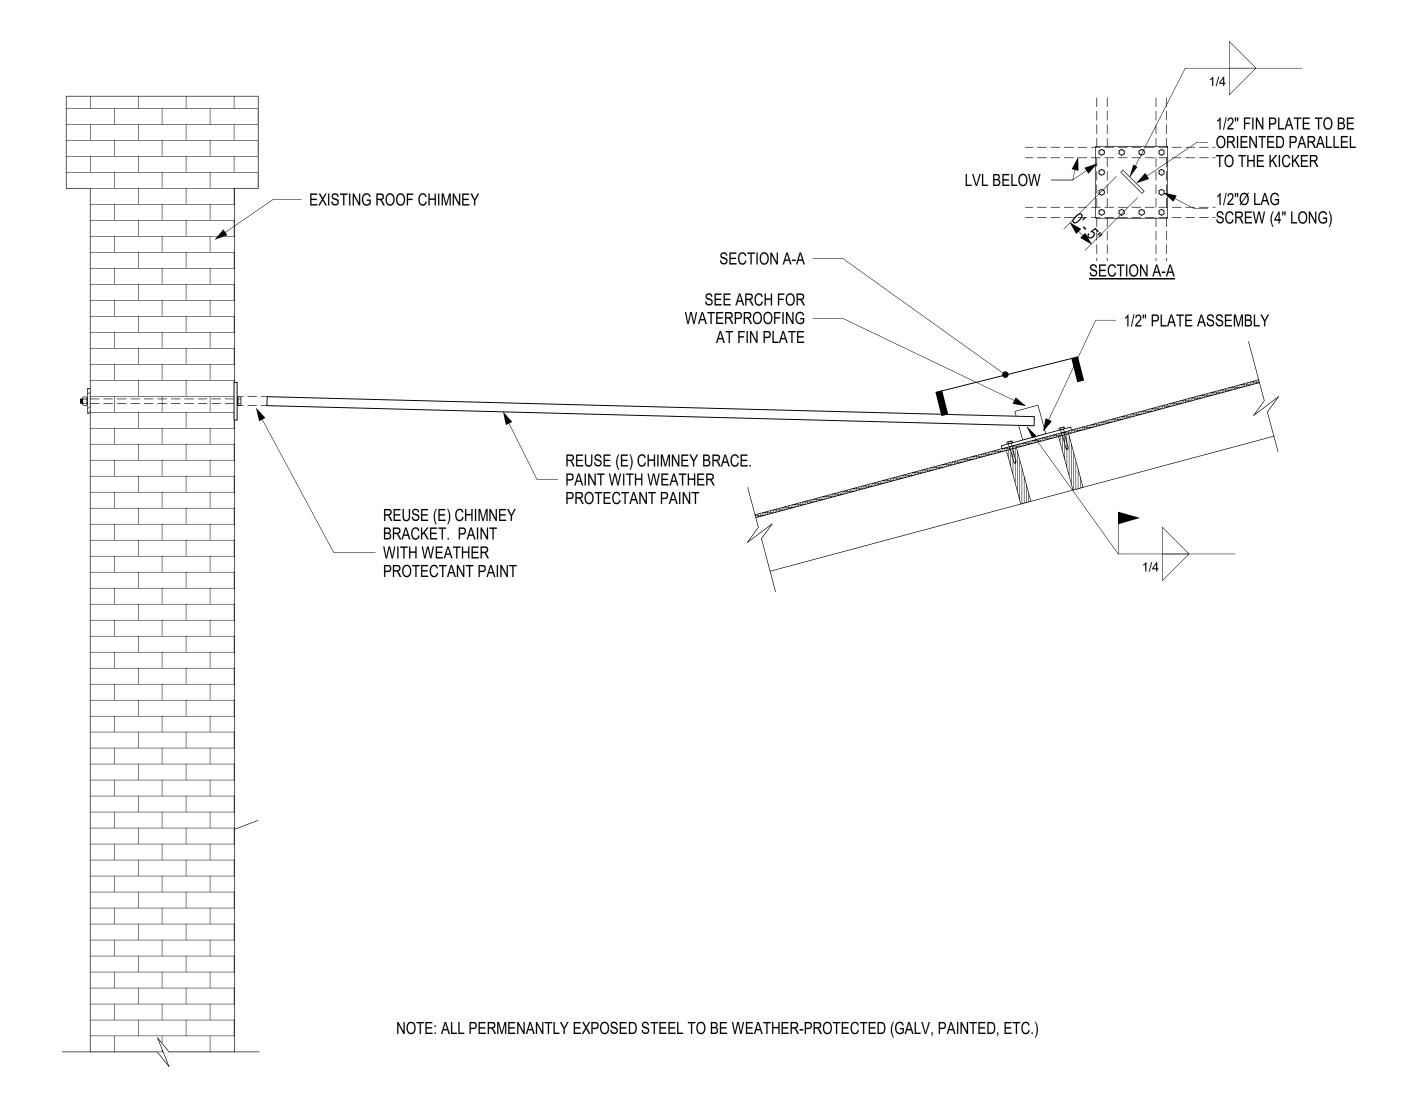
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SECTIONS AND DETAILS I

DRAWING NUMBER



SECTION AT TYPICAL ROOF CHIMNEY KICKER
S1.0 SCALE: 3/4" = 1'-0"

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463 BEABOSTON, MA (ISSUED


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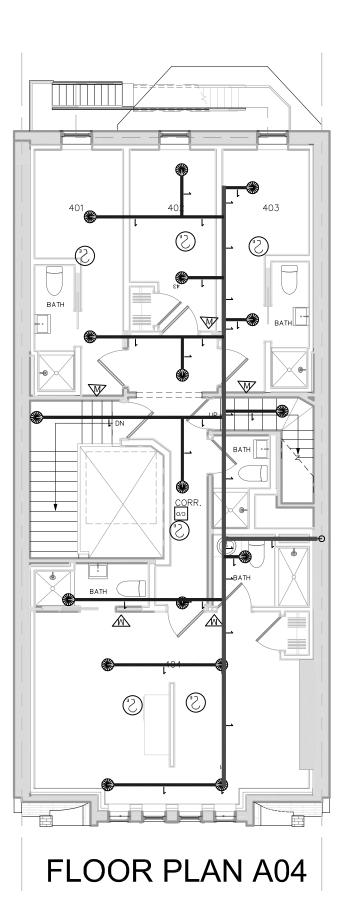
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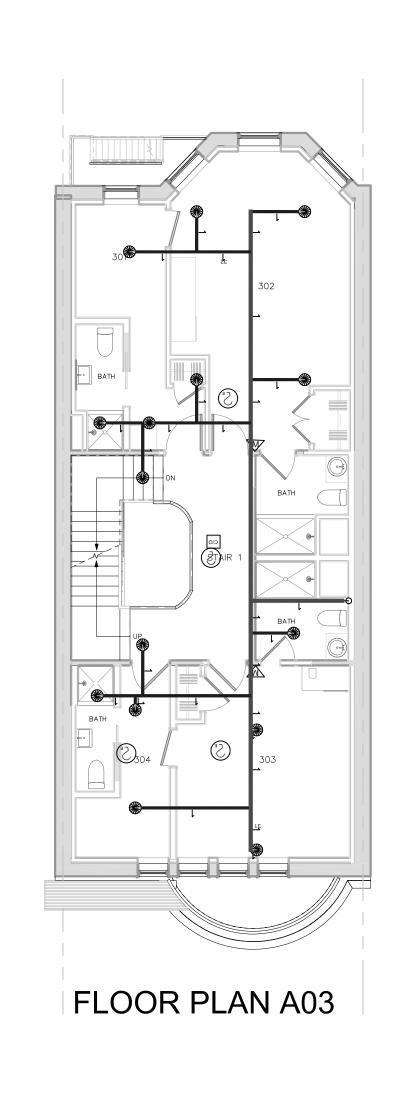



FLOOR PLAN LOFT


Design Area 1 Wet System
RESIDENTIAL
Demand Calculations using Hazen-Williams Method
Occupancy Classification: RESIDENTIAL
Design Area Density: 0.1
Additional Outside Hose: 100
Design Area Size:
Notes:

FLOOR PLAN A05



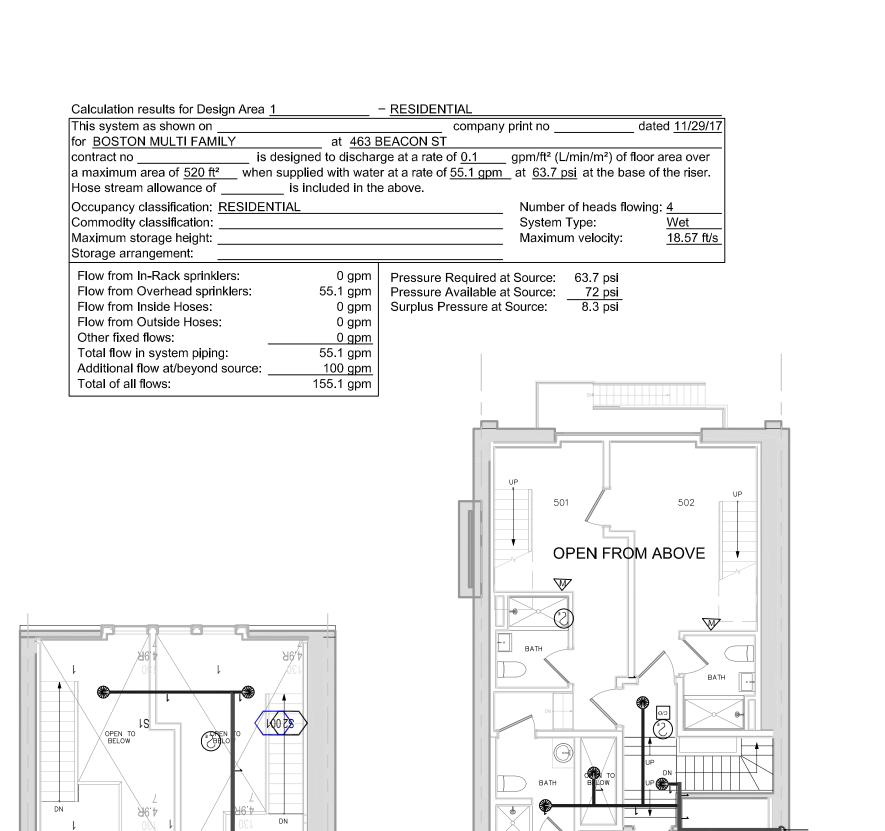

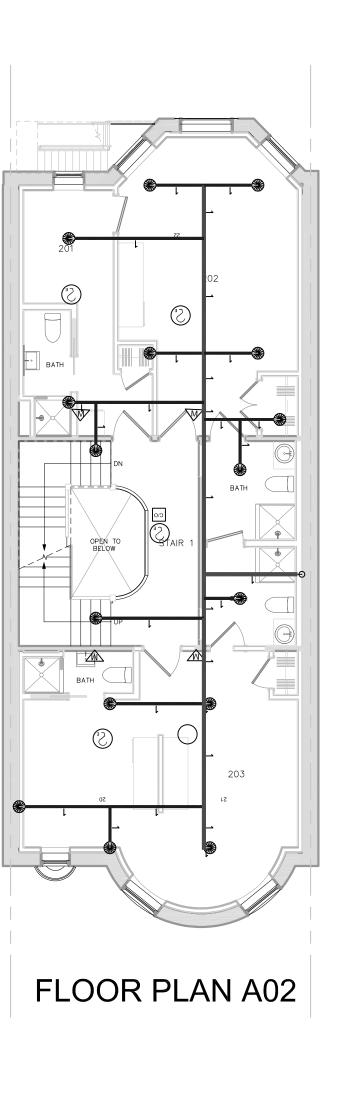

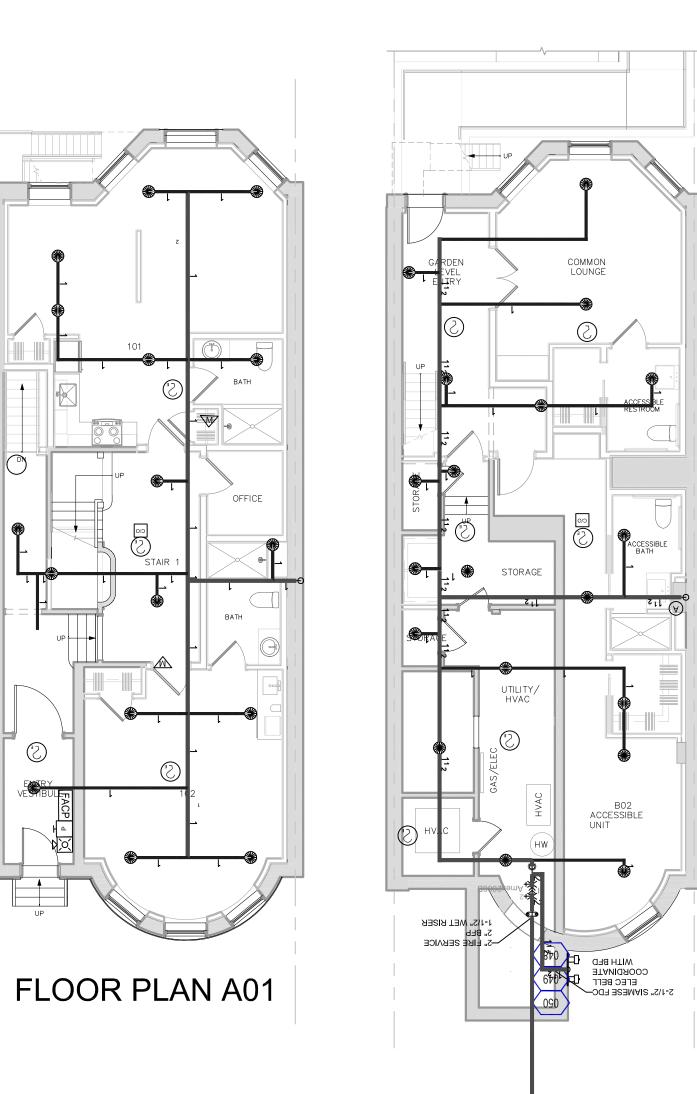



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WORK TO FIGURED DIMENSIONS C

THIS DRAWING IS TO BE READ IN CONJUNCTION WITH ALL RELEVA RCHITECT'S, SERVICE ENGINEER'S AND PLS DRAWINGS



С		JK						
В		DJ						
А								
REV:	DESCRIPTION:	BY:	DATE:					
ST	STATUS: CONSTRUCTION ISSUE							



ENGINEER: PLS INC
23 SAGAMORE LN

site: 463 BEACON ST BOSTON, MA

BOXFORD, MA

01921


FP FLOOR PLAN

 SCALE AT A1:
 DATE:
 DRAWN:
 CHECKED:

 1/8"= 1'-0"
 2/6/2020
 JK
 JK

 PROJECT NO:
 DRAWING NO:
 REVISION:

 FP1
 2020-BEACON
 1

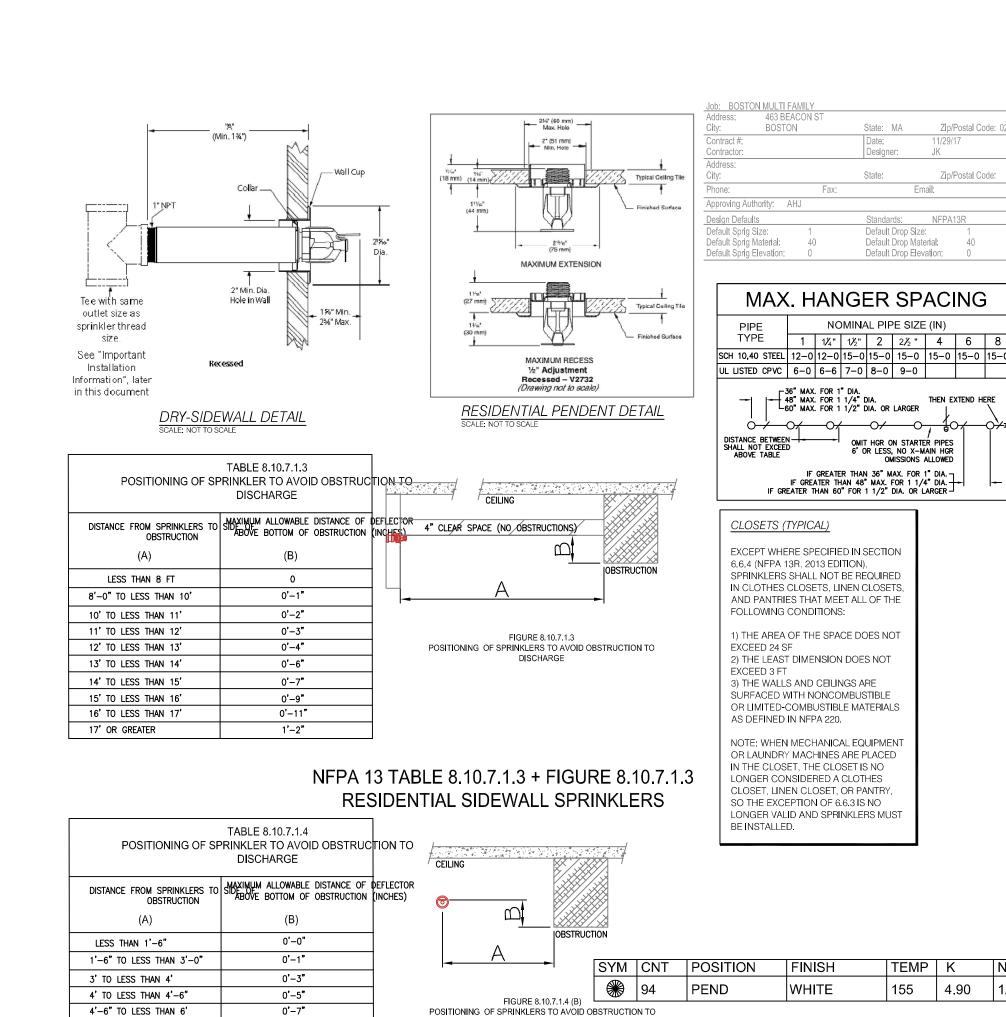

FIRE PROTECTION NOTES:

Standards: NFPA13R
Default Drop Size: 1

Default Drop Material:

Default Drop Elevation:

NOMINAL PIPE SIZE (IN)

IF GREATER THAN 36" MAX. FOR 1" DIA.
IF GREATER THAN 48" MAX. FOR 1 1/4" DIA.
IF GREATER THAN 60" FOR 1 1/2" DIA. OR LARGER

THE PURPOSE OF THIS FIRE PROTECTION DRAWING AND THE ASSOCIATED FIRE PROTECTION DESIGN NARRATIVE IS TO INDICATE THE PROPOSED COMMERCIAL SPRINKLER SYSTEM TO BE INSTALLED WITHIN THE RENDVATED MULTI-UNIT BUILDING LOCATED AT 463 BEACON ST IN BOSTON, MASSACHUSETTS

THIS BUILDING CONSISTS OF A BASEMENT LEVEL, 1ST LEVEL, 2ND LEVEL AND 3RD LEVEL, 4TH AND 5TH LEVEL AS INDICATED \square N THE ASSOCIATED ARCHITECTURAL DRAWINGS.

THIS RESIDENTIAL SPRINKLER SYSTEM HAS BEEN DESIGNED IN ACCORDANCE WITH THE REQUIREMENTS OF NFPA 13R (2013 EDITION) FOR A RESIDENTIAL BUILDING UP TO 5 STORIES IN HEIGHT AND NOT EXCEEDING 12,000 GROSS SF WITH A SINGLE MEANS OF EGRESS.


THE SPRINKLER CONTRACTOR SHALL FOLLOW THE LATEST REQUIREMENTS OF NFPA 13 AND 13R (2013 EDITION), MASSACHUSETTS STATE BUILDING CODE (780 CMR, 9TH EDITION) AND BOSTON FIRE DEPARTMENT REQUIREMENTS.

THIS SYSTEM WILL BE SUPPLIED BY A NEW 2" COPPER SERVICE, TAPPED OFF THE EXISTING WATER MAIN ON ATHENS STREET. THE 2" SERVICE SHALL BE DESIGNED, INSTALLED, FLUSHED AND TESTED IN ACCURDANCE WITH THE REQUIREMENTS OF NFPA 24 BY A LICENSED UNDERGROUND CONTRACTOR AND WILL ENTER THE BASEMENT AS INDICATED ON THIS DRAWING.

THE SYSTEM HAS BEEN HYDRAULICALLY CALCULATED IN ACCORDANCE WITH THE REQUIREMENTS OF NFPA 13R, INCLUDING THE FOUR HYDRAULICALLY MOST DEMANDING HEADS IN A SINGLE COMPARTMENT BASED ON THE REQUIREMENTS OF THE SPECIFIC SPRINKLER HEAD AND THE SPACING USED IN THIS DESIGN (16'x16' REQUIRING A MINIMUM OF 13 GPM @ 7 PSI). REMOTE AREAS, DENSITIES AND HOSE STREAM ALLOWANCES ARE INDICATED ON THIS DRAWING ALONG WITH SYSTEM DEMANDS AT CONNECTION TO STREET AND CALCULATION RESULTS HAVE BEEN COMPARED TO RECENT HYDRANT FLOW TEST INFORMATION

OBTAINED FROM THE BOSTON WATER & SEWER DEPARTMENT

CAPAWHAETHABAHAYEATABAN HAWAMITEREN TOOTHISATARAWING TO THATAREITANG-MBENTEBARTMENES. INGRARENGESMAINKLER CONTRACTOR SHALL COORDINATE WITH ELECTRICIAN AND LOCATE SPRINKLERS AT LEAST 36" FROM THE CENTER OF ANY CEILING-MOUNTED FIXTURE, IN ACCORDANCE WITH THE REQUIREMENTS OF NFPA 13R WHILE MAINTAINING THE MAXIMUM DISTANCES FROM WALLS INDICATED ON THIS DESIGN (8-FT). ADDITIONAL SPRINKLERS REQUIRED DUE TO INABILITY TO MEET OBSTRUCTION CRITERIA SHALL BE AT THE OWNERS EXPENSE.

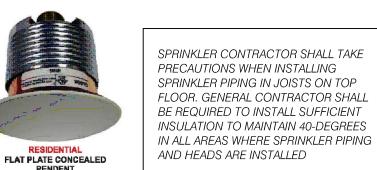

MODEL#

_EREEZE PROTECTION

THE BUILDING OWNER IS RESPONSIBLE FOR PROVIDING HEAT IN ALL AREAS CONTAINING SPRINKLER PIPING AND HEADS TO PREVENT PIPE

FROM FREEZING, ANY AREAS THAT RAISE CONCERN WITH REGARD T FREEZING POTENTIAL SHALL BE BROUGHT TO THE ENGINEER'S

ATTENTION. IN WRITING. PRIOR TO INSTALLATION. JFP SOLUTIONS.

DAMAGES CAUSED BY FREEZE-UPS OF THE SPRINKLER SYSTEM.

INC. AND THE ENGINEER OF RECORD TAKE NO RESPONSIBILITY FOR

VK494

INSTALLATION NOTES:

ALL WORK SHALL BE PERFORMED BY A MASSACHUSETTS LICENSED SPRINKLER CONTRACTOR. THE SPRINKLER CONTRACTOR SHALL FOLLOW THE LATEST REQUIREMENTS OF NFPA 13R (2013 EDITION) MASSACHUSETTS STATE BUILDING CODE (9TH EDITION) AND THE BOSTON FIRE DEPARTMENTS.

THE ARCHITECTURAL BACKGROUND OF BUILDING MAY DIFFER SLIGHTLY FROM ACTUAL LAYOUT. DRAWINGS ARE NOT INTENDED TO SHOW ALL OFFSETS AND PIPING ELEVATION CHANGES. CONTRACTOR SHALL FIELD VERIFY ALL MEASUREMENTS PRIOR TO FABRICATION.


CONTRACTOR SHALL HYDROSTATICALLY TEST ALL SPRINKLER PIPING AT 200 PSI FOR 2 HOURS AND IS RESPONSIBLE FOR THE COMPLETION OF ALL ABOVE GROUND TEST CERTIFICATES, SUPPLIED TO THE


ALL PIPING INSTALLED THROUGHOUT THE RESIDENTIAL AREAS OF THE BUILDING SHALL BE UL LISTED CPVC SPRINKLER PIPING.ALL PIPING SHALL BE INSTALLED IN ACCORDANCE WITH THE REQUIREMENTS OF NFPA 13 (2013 EDITION) AND ALL MANUFACTURERS INSTALLATION RECOMMENDATIONS, ALL PIPING SHALL BE PITCHED TO DRAIN WITH LOW-POINT DRAINS AT SECTIONS OF PIPING SUBJECT TO WATER TRAPPING. SPRINKLER CONTRACTOR SHALL PROVIDE PROTECTIVE PLATES WHERE CPVC PIPING IS RUN THROUGH STUDS TO PREVENT PUNCTURING OF THE SPRINKLER PIPING DURING DRYWALL INSTALLATION AS REQUIRED BY NFPA STANDARDS.


ALL SPRINKLER HEADS WITHIN RESIDENTIAL AREAS OF THE BUILDING SHALL BE RESIDENTIAL PENDENT SPRINKLERS. SPRINKLERS WITHIN THE BASEMENT LEVEL WILL BE QUICK-RESPONSE UPRIGHT HEADS. ALL HEADS SHALL BE INSTALLED IN ACCORDANCE WITH THE MANUFACTURER'S REQUIREMENTS AND THE REQUIREMENTS OF NFPA

SPRINKLER SYSTEM IN ACCORDANCE WITH THE REQUIREMENTS OF NFPA 25, INCLUDING THE PROVISION OF HEAT IN ALL AREAS CONTAINING SPRINKLER PIPING AND HEADS TO PREVENT PIPE FROM REEZING. JFP SOLUTIONS, INC. AND THE ENGINEER OF RECORD TAKE

<u>O RESPONSIBILITY FOR ANY DAMAGES CAUSED BY FREEZE UPS.</u>

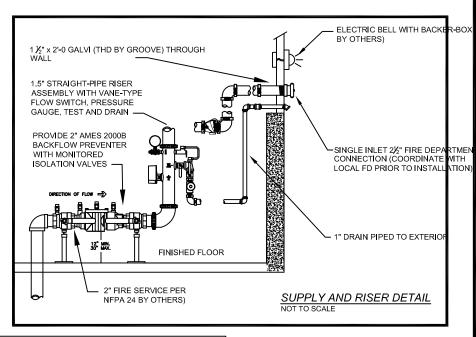

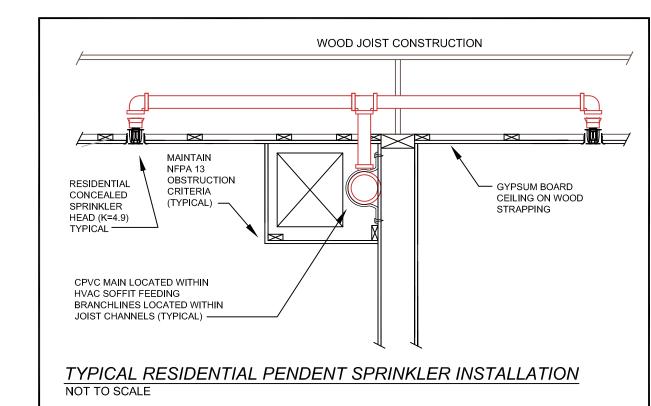

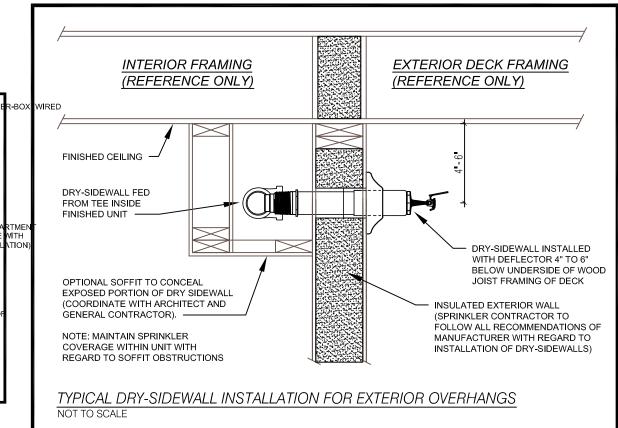

REL AMBIENT RATUTE					
10°C)	60°F (16°C)				
ION "A	REL LENGTH " NG OR INSIDE				
)	0				
)	0				
)	0				
25)	0				
76)	0				
02)	1 (25)				
52)	3 (76)				
03)	4 (102)				
03)	4 (102)				
254)	6 (152)				


EXPOSED BAR EMPERATURE OF PROTECTED AREA 40°F (4°C) 50°F (EXPOSED MINIMUN DISCHARGE EN OF THE (FACE OF TEE TO TOP O SPRINKLER 40°F (4°C) 30°F (-1°C) 0 20°F (-7°C) 4 (102) 10°F (-12°C) 8 (203) 1 (2 0°F (-18°C) 12 (305) 3 (7 -10°F (-23°C) | 14 (356) | 4 (10 -20°F (-29°C) 14 (356) 6 (19 -30°F (-34°C) 16 (406) 8 (20 -40°F (-40°C) 18 (457) 8 (20 -50°F (-46°C) 20 (508) 10 (29

-60°F (-51°C) 20 (508) 10 (254) 6 (152)

FIGURE 3: EXPOSED BARREL LENGTH

6'-6" TO LESS THAN 7' NFPA 13 TABLE 8.10.7.1.4 + FIGURE 8.10.7.1.4 (B) STANDARD SIDEWALL SPRINKLERS

6' TO LESS THAN 6'-6"

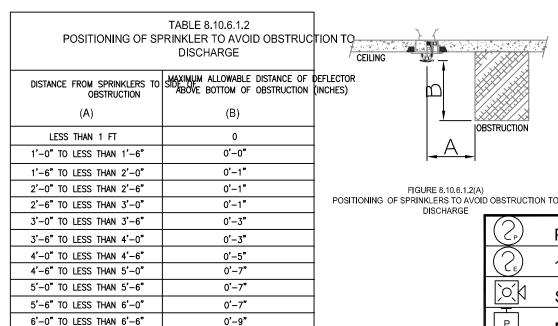

6'-6" TO LESS THAN 7'-0" 0'-11" 7'-0" AND GREATER 1'-2"

NFPA 13 TABLE 8.10.6.1.2 + FIGURE 8.10.6.1.2(A)

RESIDENTIAL PENDENT AND UPRIGHT SPRAY SPRINKLERS

TEMPERATURE RATINGS	TABLE 8.3.2.5(c) OF SPRINKLERS IN SPECIFI	ED RESIDENTIAL AREAS
HEAT SOURCE	MINIMUM DISTANCE FROM EDG SOURCE TO ORDINARY TEMPER SPRINKLER (INCHES)	E OF MINIMUM DISTANCE FROM EL ATURESOURCE TO INTERMEDIATE TEM SPRINKLER (INCHES)
SIDE OF OPEN OR RECESSED	FIREPLACE 36	12
FRONT OF RECESSED FIREPLA	CE 60	36
KITCHEN RANGE	18	9
WALL OVEN	18	9
SIDE OF CEILING OR WALL MOUNTED F DIFFUSER	HOT AIR 24	12
FRONT OF WALL MOUNTED HOT AIR DIFFU	ISER 36	18
HOT WATER HEATER OR FURNACE	6	3
LIGHT FIXTURE: 0W-250W	6	3
LIGHT FIXTURE: 250W-499W	12	6

TEMPERATURE RATINGS OF SPRINKLERS IN SPECIFIED RESIDENTIAL AREAS

FIRE ALARM LEGEND

UL LISTED CPVC SPRINKLER PIPING

	PHOTOELECTRIC SYSTEM SMOKE DETECTOR
(SE)	110V ELEC. SMOKE/HEAT INTERCONNECT TO LOCAL UNIT
	SPEAKER STROBE NOTIFIER SPECTRALERT
P	MANUAL PULL STATION NOTIFIER BNG BRG SERIES
W	MINI SOUNDER TEMPORAL 3 NOTIFIER E SERIES
)O(ADA STROBE

- **CARBON MONOXIDE DETECTOR** OUTDOOR LOCATOR BEACON
- TAMPER SWITCH POTTER FLOW SWITCH POTTER
- FACP FIRE ALARM CONTROL PANEL NOTIFIER

SIN

VK494 VIKING

155 4.90 1/2"

1. ALL FIRE ALARM SYSTEM WIRING SHALL COMPLY WITH THE NATIONAL ELECTRICAL CODE, APPLICABLE STATE AND LOCAL FIRE AND SAFETY CODES, AS WELL AS BEING COORDINATED WITH THE LOCAL AUTHORITY HAVING JURISDICTION.

FIRE ALARM NOTES

- CAUTION: DO NOT CONNECT ANY POWER TO CONTROL PANEL (BATTERIES OR 120VAC) UNTIL ALL OTHER FIELD WIRING IS TESTED AND CONNECTED.
- 3. DO NOT INSTALL ANY A.C. CURRENT CARRYING CONDUCTORS CLOSE TO OR IN THE SAME RACEWAY WITH FIRE ALARM SYSTEM CONDUCTORS.
- 4. THE ENTIRE FIRE ALARM SYSTEMS SHALL BE A CLASS "A"
- ADDRESSABLE SYSTEM. THE RATING OF THE CONTROL MODULE (ES-200X) CONTACTS ARE:
- 20 WATTS AUDIO AT 25 OR 70 VOLTS 2.0 AMPS DC (BELLS, HORNS AND DC CONTROL CIRCUITS) 6. ALL OUTPUT (SIGNAL) CIRCUITS ARE SHOWN IN ALARM CONDITION.
- POLARITY IS REVERSED WHEN THE SYSTEM IS IN THE SUPERVISORY
- OWNER TO PROVIDE DESIGNATIONS FOR DEVICES PROGRAMMING LANGUAGE. 3. REFER TO FLOOR PLANS FOR EXACT LOCATIONS AND QUANTITY OF ALL DEVICES.
- FIRE ALARM CONTRACTOR SHALL FIELD VERIFY THE LENGTHS AND FEASIBILITY OF ALL ROUTING BEFORE BEGINNING WORK.
- 10. ALL JUNCTION BOX COVERS IN THE FIRE ALARM SYSTEM SHALL BE PAINTED RED,
- BY THE FIRE ALARM CONTRACTOR, BEFORE THEY ARE INSTALLED. 11. ALL EQUIPMENT SHALL BE UL LISTED AND/OR FM APPROVED.
- 12. ELECTRICAL SUBCONTRACTOR SHALL INSTALL ALL WIRING TO THE FIRE ALARM CONTROL PANELS; TERMINATIONS TO FACP'S SHALL BE MADE BY THE FIRE ALARM SUPPLIER OR UNDER SUPERVISION OF A REPRESENTATIVE FROM THE FIRE ALARM
- 13. GROUND ALL EQUIPMENT PER N.E.C. REQUIREMENTS.
- 14. ALL PERMITS AND INSPECTION FEES SHALL BE OBTAINED AND PAID FOR BY THE FOR BY THE FIRE ALARM CONTRACTOR.
- 15. ALL CUTTING, PATCHING, AND CORE DRILLING FOR FIRE ALARM SYSTEMS SHALL BE THE RESPONSIBILITY OF THE ELECTRICAL CONTRACTOR. FIRE SEAL ALL NEW ELECTRICAL PENETRATIONS IN FLOORS AND WALLS.
- 16. THE LOCATIONS OF ALL SMOKE DETECTORS AND HEAT DETECTORS SHOWN ARE CONSIDERED TO BE SCHEMATIC ONLY. THE ACTUAL LOCATIONS (SPACING TO ADJACENT DETECTORS, WALLS ETC.) ARE REQUIRED TO MEET NFPA 72.

Caution: Care should be taken to avoid compressing the insulation. This reduces its R value. To prevent potential freeze—ups of

INSULATION PROTECTING SPRINKLEF PIPING ON UPPER FLOOR DETAIL


<u>FIRE ALARM NOTES & NARRATIVE</u> THE FIRE ALARM SYSTEM FOR THIS BUILDING IS MADE UP OF THE

- FIRE ALARM CONTROL PANEL (ADDRESSABLE TYPE) LOCATED IN FRONT PULL STATIONS AT MAIN EGRESS LOCATIONS
- HORN STROBE LOCATED ON SECOND LEVEL COMMON AREA AND LOW FREQUENCY SOUNDERS IN ALL APARTMENTS (70 dB MIN AT PILLOW OF SLEEPING ROOMS).
- LOCAL SMOKE DETECTORS IN ALL BEDROOMS AND COMBINATION SMOKE AND CARBON MONOXIDE DETECTORS WITHIN 10-FT OF ALL BEDROOM DOORS. INTERCONNECTED WITHIN UNIT. SYSTEM SMOKE DETECTORS IN ALL COMMON AREAS
- FLOW AND TAMPER SWITCHES FOR SPRINKLER SYSTEM. TAMPER SWITCH SHALL BE TROUBLE ONLY ON THE FIRE ALARM PANEL AND SIGNAL SENT VIA RADIO SIGNAL (WILL NOT TRIP MASTER BOX) ELECTRIC BELL LOCATED ON OUTSIDE OF THE BUILDING NEAR FIRE ALARM CONTROL PANEL AND FIRE DEPARTMENT CONNECTION
- KNOX BOX AT MAIN ENTRANCE CARBON MONOXIDE DETECTOR SHALL BE LOCATED IN ALL AREAS THAT CONTAIN FOSSIL FUEL AND ADJACENT AREAS AND CONNECTED TO THE FIRE ALARM SYSTEM. TROUBLE ONLY ON FIRE ALARM PANEL AND SIGNAL SENT VIA RADIO SIGNAL (WILL NOT TRIP MASTER BOX).

THE ACTIVATION OF ANY MANUAL FIRE ALARM STATION OR THE AUTOMATIC ACTUATION OF ANY SYSTEM SMOKE DETECTOR, SPRINKLER SYSTEM WATER FLOW SWITCH OR ANY OTHER APPROVED ALARM INITIATION DEVICE SHALL IMMEDIATELY RESULT IN THE FOLLOWING:

- THE DEVICE IN ALARM SHALL BE LISTED ON A DISPLAY AT THE FIRE ALARM PANEL AND REMOTE ANNUNCIATOR THE AUDIBLE HORNS SHALL SOUND A TEMPORAL PATTERN AT ALL
- LOCATIONS ALL VISUAL ALARM SIGNALS SHALL FLASH AT A RATE OF 120 FLASHES PER MINUTE. IF ALARM SIGNALS ARE SILENCED FOR ANY REASON, THEY SHALL
- AUTOMATICALLY RESOUND IF ANOTHER ADDRESS IS TRIPPED OUTDOOR BEACON LIGHTS WILL ILLUMINATE IN THE EVENT OF A COMMERCIAL POWER INTERRUPTION, THE SYSTEM
- SHALL AUTOMATICALLY TRANSFER TO AN EMERGENCY BATTERY

THIS TIER 1 DRAWING IS FOR DIAGRAMMATICAL USE ONLY. FIRE ALARM CONTRACTOR TO SUBMIT TIER II SHOP DRAWINGS, BATTERY CALCULATIONS AND PRODUCT CUTS TO BE REVIEWED BY JFP SOLUTIONS, INC. AND REVIEWED AND APPROVED BY THE BOSTON FIRE DEPARTMENT AND BUILDING DEPARTMENT.

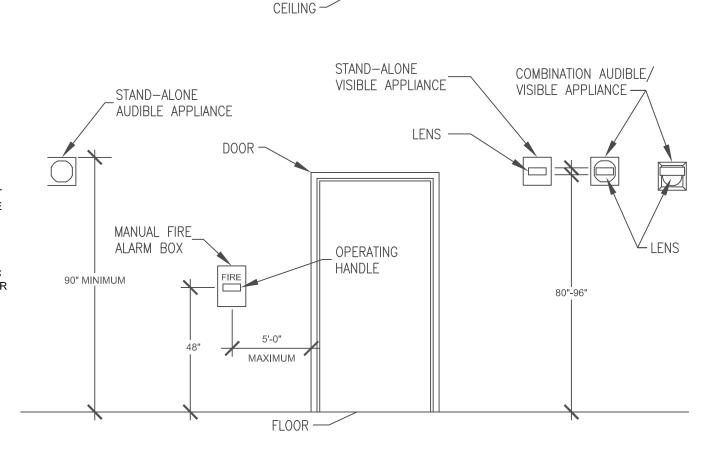

TYPICAL MOUNTING HEIGHT DETAIL FOR WALL MOUNTED DEVICES

Notes:

REV: DESCRIPTION: STATUS: CONSTRUCTION ISSUE



CLIENT: ENGINEER: PLS INC 23 SAGAMORE LN BOXFORD, MA 01921

463 BEACON ST BOSTON, MA

TITLE: FIRE PROTECTION DETAILS INFO SHEET

CHECKED: 1/4"= 1'-0" 2/6/2020 PROJECT NO: DRAWING NO: REVISION: 2020-BEACON