



71 CHARLES STREET NOVEMBER 2019

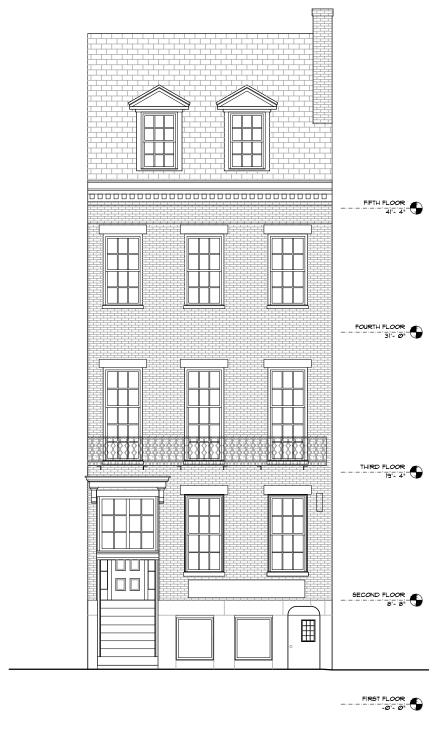

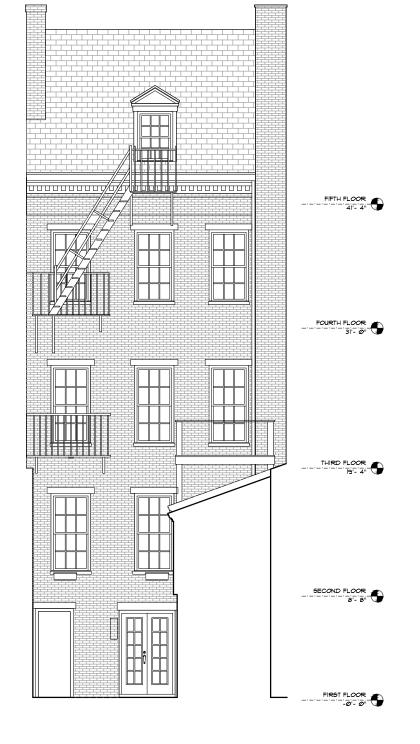



FULL: 1/4" = 1'-0", HALF: 1/8" = 1'-0"

2 REAR ELEVATION FULL: 1/4" = 1'-0", HALF: 1/8" = 1'-0" 3 REAR-SIDE ELEVATION FULL: 1/4" = 1'-0", HALF: 1/8" = 1'-0"



71 CHARLES STREET
BOSTON, MA Ø2114

SHEET TITLE:
EXISTING CONDITIONS
FRONT & REAR
ELEVATIONS
DATE: OCTOBER 30 2019

DATE: OCTOBER 30, 2019
SCALE: AS NOTED
DRAWN: JGUR 4 RJP

CHECKED:

JGUR # MZP

EC-1

SHEET NO.



ENLARGED FRONT ELEVATION
FULL: |" = |'-0", HALF: 1/2" = |'-0"




71 CHARLES STREET BOSTON, MA Ø2114

SHEET TITLE: EXISTING CONDITIONS ENLARGED FRONT SHEET NO. ELEVATION

DATE: OCTOBER 30, 2019 SCALE:

EC-2 AS NOTED DRAWN: JGUR & RJP CHECKED: JGUR & MZP

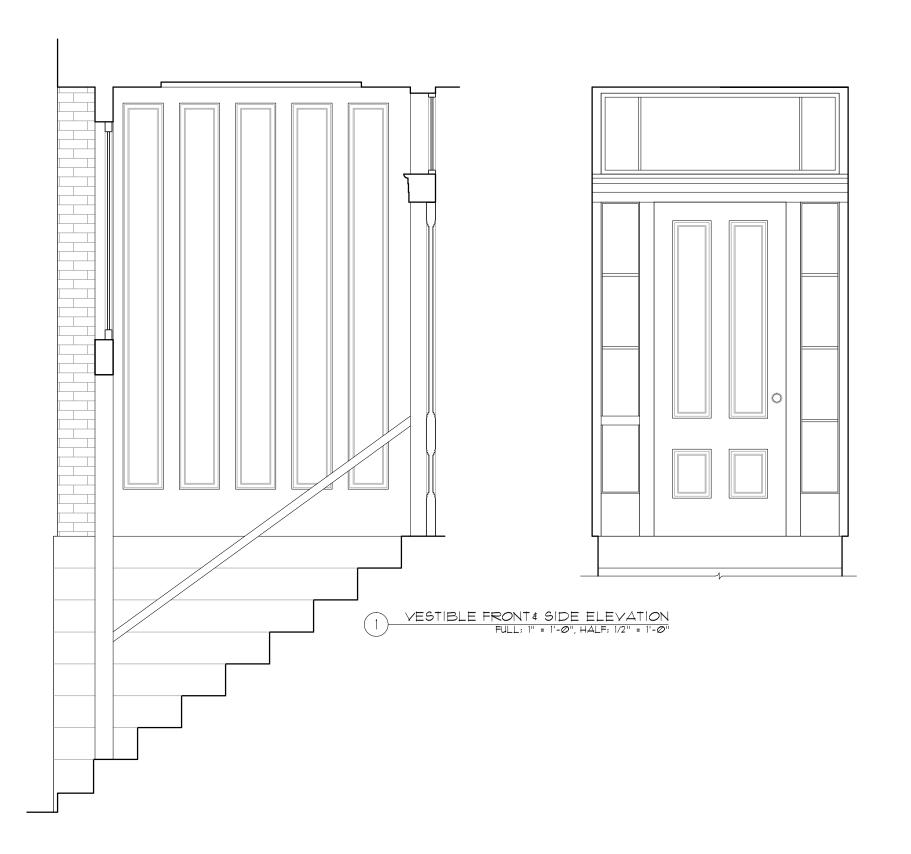



71 CHARLES STREET BOSTON, MA 02114

SHEET TITLE: EXISTING CONDITIONS VESTIBULE DETAILS

DATE: OCTOBER 30, 2019 SCALE: AS NOTED DRAWN: JGUR & RJP JGUR & MZP

CHECKED:

SHEET NO.






71 CHARLES STREET
BOSTON, MA Ø2114

SHEET TITLE:
PROPOSED
FRONT & REAR
ELEVATIONS

DATE: DECEMBER 10, 2019
SCALE: AS NOTED
DRAWN: JGUR & RJP
CHECKED: JGUR & MZP

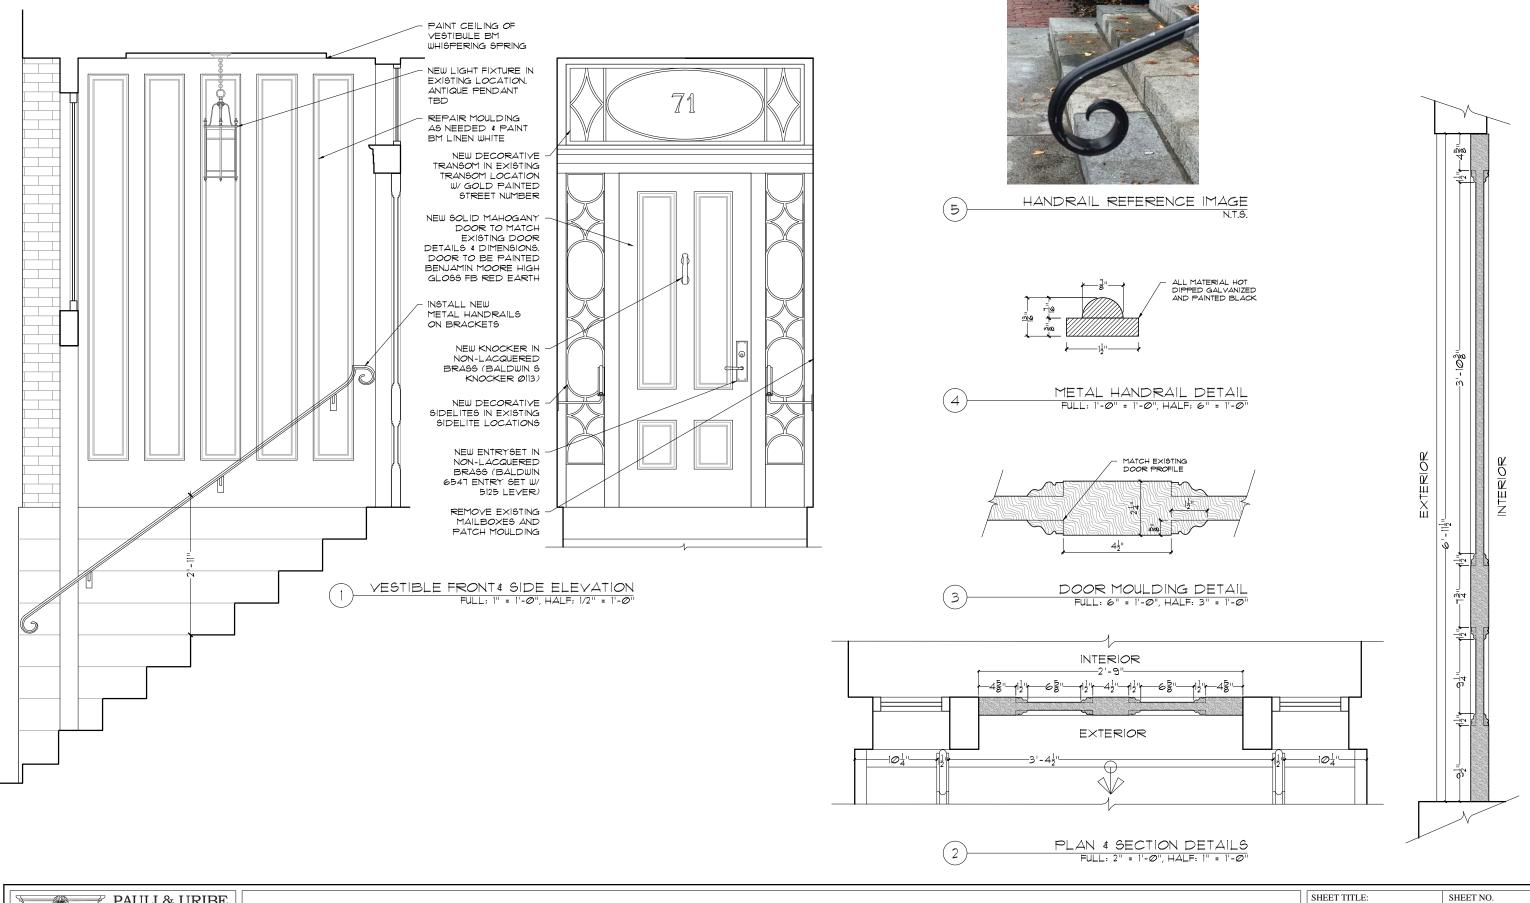



71 CHARLES STREET BOSTON, MA 02114


SHEET TITLE:
PROPOSED
VESTIBULE DETAILS

DATE: DECEMBER 10, 2019

SCALE: AS NOTED
DRAWN: JGUR & RJP
CHECKED: JGUR & MZP

A-3



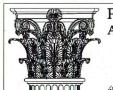

PAULI & URIBE ARCHITECTS LLC

Classic Architecture Interior Design 121 Mount Vernon Street Boston, Massachusetts, 02108 617 227 0954 · www.pauli-uribe.com

71 CHARLES STREET BOSTON, MA Ø2114

SHEET TITLE: ENLARGED FRONT

ELEVATION DATE: DECEMBER 10, 2019

SCALE: AS NOTED

DRAWN: JGUR & RJP CHECKED: JGUR & MZP A-2

EXISTING FRONT FACADE PHOTOS





EXISTING FRONT FACADE PHOTOS





EXISTING FRONT FACADE PHOTOS








EXISTING SIGNAGE








EXISTING REAR FACADE PHOTOS FROM CEDAR LANE WAY

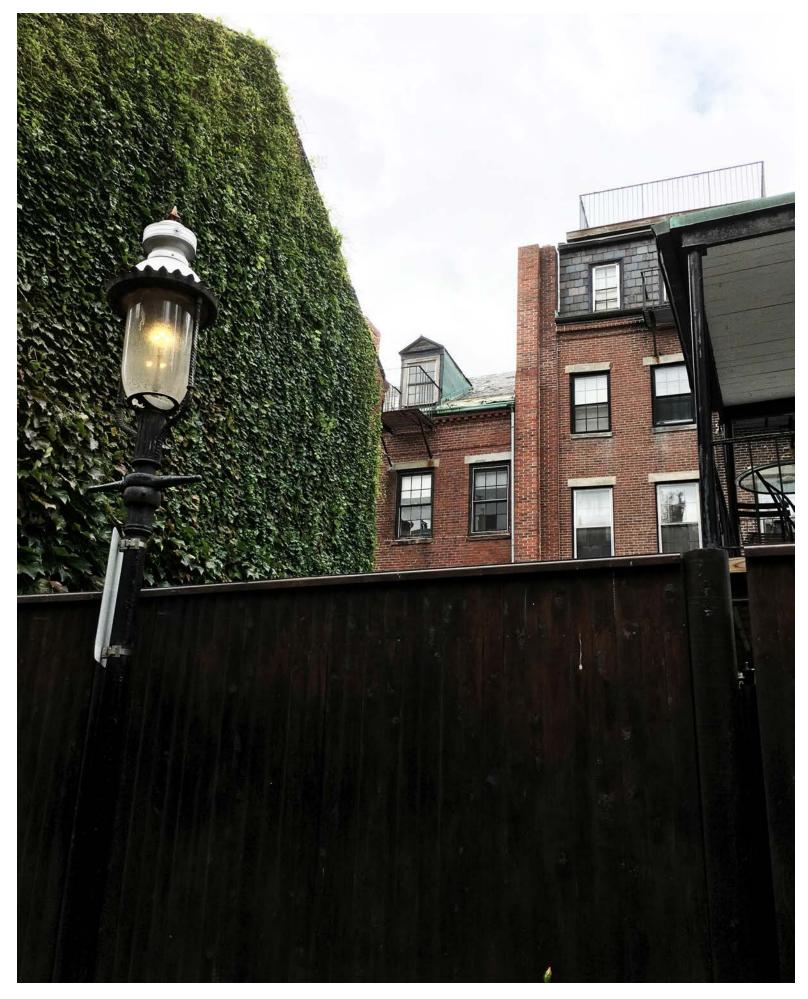





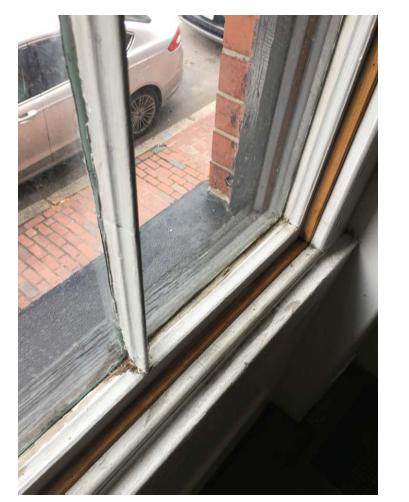





EXISTING DOOR & WINDOW CONDITIONS

















EXAMPLES OF ENTRANCES ON CHARLES STREET





DOOR HARDWARE SPECIFICATION

6547 - NASHVILLE

.312"

2.187"

ESTATE ENTRYSET

(**a**)

2.75" x 10.0" **SPECIFICATIONS**



TIER 1 FINISHES

TIER 2 FINISHES

- > Certified by Underwriters Laboratories (UL) for use on fire doors up to three-hour rating
- > U L10C / UBC 7-2 (1997) Positive Pressure Rated,
- > Material: Solid Forged Brass

5125

ESTATE LEVER



doors up to three-hour rating

UL10B Pressure Rated

> Material: Solid Brass

> Accessibility Code (ADA) A117.1 for all levers.

> U L10C / UBC 7-2 (1997) Positive Pressure Rated,

> Certified by Underwriters Laboratories (UL) for use on fire







BALDWIN®

"S" KNOCKER

Model #: 0113.003

★★★★ 4.6 (8)

AVAILABLE FINISHES:





ADD TO WISH LIST

PRODUCT HIGHLIGHTS

• "S" Knocker, 2" dia. base, 7.8" ht., 2.8" projection, 4.75" CTC of bolts



- UL10B Pressure Rated

SHOWN WITH ROSE 5017



4.25"



TIER 1 FINISHES

TIER 2 FINISHES








REPLACE KNOB W/ 5125 LEVER



2.8"

NEW WINDOW SPECIFICATIONS

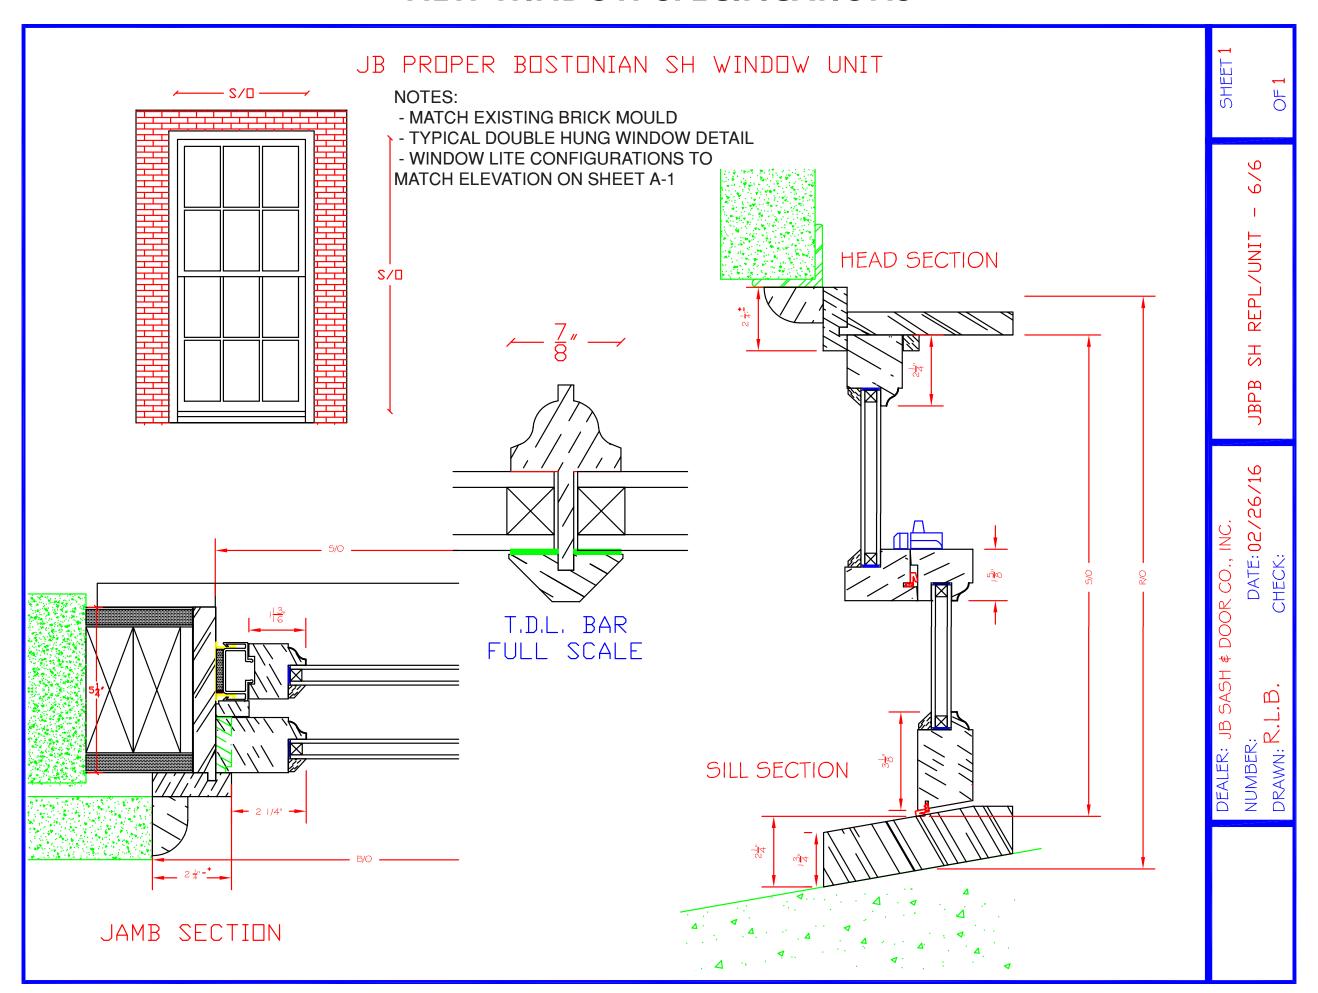

STORM WINDOW SPECIFICATIONS




The Storm Window that beats air infiltration everywhere it counts.


NO COMPROMISE DESIGN - that's what makes the TRU-CHANNEL Storm Window so different from any other storm window. It is why we have engineered the most effective interlocks, joints and weatherstripping, and why the frame is so beavy with weatherstripping on BOTH sides of the sash rails.




Solid Barrier Weatherstripping It's the ultimate in weather protection and the TRU-CHANNEL window uses more than twice as much as ordinary storm windows.


Your choice of color

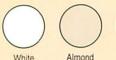

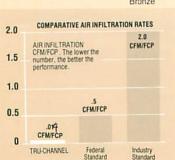

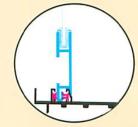


Sill: A tongue and groove interlock combined with inner and outer SOLID BARRIER weatherstripping makes the most effective seal possible.

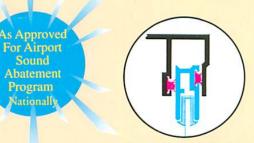

Sound

Program

Head: There's an extra deep pocket and double weatherstripping to seal this critical area.

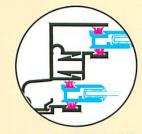



Jambs: The TRU-CHANNEL earns its name and reputation as the storm window that outperforms most prime windows right here. The sash rails ride between double layers of heavy duty siliconetreated wool pile weatherstripping. The harder the wind blows, the tighter the seal.



Meeting Rail: A fine feature that makes the TRU-CHANNEL outperform other windows is the revolutionary RIGID BAR tubular extrusion with double interlocks and double weatherstripping. It really puts a stop to leaking air and keeps the frame square even after years of service.

Harvey Industries, Inc. Tru-Channel Storm Window (1/2 Scale)

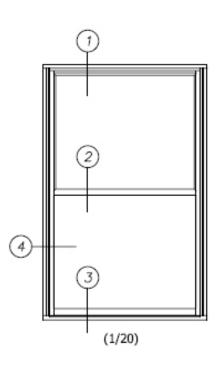

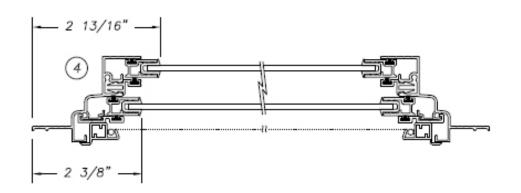

2 7/16"

1 3/8"

2 9/16"

(3)

AS 200 REV. 1/04

EXTERIOR PAINT SPECIFICATIONS

Exterior specifications for 71 Charles Street

(Facing Charles Street)

All windows and surrounding wood trim: Benjamin Moore "Linen White" No. 912 (semi-gloss)



Front Door: Farrow & Ball "Red Earth" No. 64 (high gloss)




Exterior vestibule: Benjamin Moore "Linen White" No. 912 (gloss)

- All exterior and interior wood surfaces in same Linen White
- Ceiling of vestibule in Benjamin Moore "Whispering Spring"
 No. 2136-60



Exterior Lintels and sills over 2nd floor windows: color to be custom mixed to match un-painted stone lintels and sills on all other exterior windows

Door to alley entryway: Benjamin Moore "Black" No. 2132-10

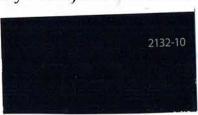

(Back of house)

All windows and trim in Benjamin Moore "Linen White" (gloss)

Back Entrance Dutch Door: Benjamin Moore "Red Earth" No. 64 (high gloss)

Clapboard siding: Benjamin Moore "Linen White" (flat)

All windows and trim also "Linen White" (gloss)

Shutters on 1st and 2nd floor of kitchen extension: Benjamin Moore

"Harbor Haze" No. 2136-60

Harbor Haz

Window Boxes on all windows on the ground level, 1st and 2nd floors – wood boxes painted in "Linen White" (gloss)

Back Wood fence: all in "Linen White" (gloss)



CONNECTIONS (FDC) FLUSH 2 WAY & 3 WAY CLAPPER INLET TYPE

Model/Series No. 5020-5030 SERIES

SPECIFICATIONS

TWO-WAY & THREE-WAY INLETS

Cast brass body with drop clappers. Size, outlet location and number of inlets as selected by model number. Polished brass plate with lettering as selected. Polished brass 2-1/2" double female snoots with rigid end N.P.T. x pin lug hose thread swivels, pin lug plugs and chains.



MODEL SELECTION

- ☐ *5021 Back Outlet
- ☐ *5022 Bottom Outlet
- ☐ *5023 Top Outlet
- ☐ *5025 Back Outlet
- ☐ 5026 Bottom Outlet
- ☐ 5027 Top Outlet
- ☐ 5031 Back Outlet
- ☐ 5032 Bottom Outlet
- ☐ 5033 Top Outlet

NOTE: * = U/L Listed

PRODUCT OPTIONS

FINISHES:

□-D Polished Chrome Plated

VARIATIONS:

Sillcock Flange Plate with Sillcock

THREADS:

☐ N.S.T.

Other

LETTERING AVAILABLE:

- AUTO. SPKR.
- STANDPIPE
- DRY STANDPIPE
- AUTO SPKR. STANDPIPE

Call Potter Roemer - Fire Pro for current listings and approvals. Dimensions are subject to manufacturer's tolerance and may change without notice. Potter Roel Fire Pro assumes no responsibility for use of void or superceded data. © Copyright Potter Roemer- Fire Pro, Member of Morris Group International ™ Please visit

5020-5030 SERIES Date: 9/25/18









Headquarters: P.O. Box 3527 City of Industry, CA 91744 U.S.A. Los Angeles Area 800-366-3473 626-855-4890

POTTER ROEMER/FIRE PRO Also in: New York (800) 526-4592 Chicago (800) 547-3473 Atlanta (800) 762-0542 Miami (866) 961-3473 Dallas (866) 644-3473

www.potterroemer.com



CONNECTIONS (FDC) FLUSH 2 WAY & 3 WAY CLAPPER INLET TYPE

Model/Series No. 5020-5030 **SERIES**

Member of Morris Group International™


MODEL DIMENSIONS

TWO-WAY AND THREE-WAY INLET


Outlet Location												
Back Outlet Model No.	Bottom Outlet Model No.	Top Outlet Model No.	Size	Α	В	c	D	E	F	G	Н	No. Inlets
*5021	*5022	*5023	4 x 2-1/2 x 2-1/2	11	6	5-1/2	6	7	11	-	5-3/4	2
*5025	5026	5027	6 x 2-1/2 x 2-1/2	12-3/4	8-3/4	7-3/4	9-1/2	7-1/2	12	-	5-1/4	2
5031	5032	5033	6 x 2-1/2 x 2-1/2 x 2-1/2	17-5/16	-	7-3/8	-	6-5/8	6-3/4	6-3/4	6	3

ALL DIMENSIONS IN INCHES



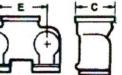



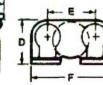





Top or Bottom

Plate 4 31/2" SUFFIX-

TWO-WAY INLET

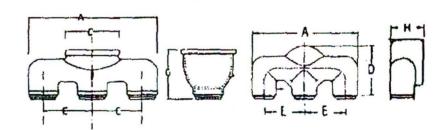

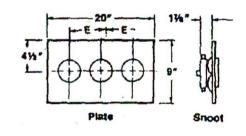

THREE-WAY INLET

Call Potter Roemer - Fire Pro for current listings and approvals. Dimensions are subject to manufacturer's tolerance and may change without notice. Potter Roeme Fire Pro assumes no responsibility for use of void or superceded data. © Copyright Potter Roemer- Fire Pro, Member of Morris Group International ™ Please visit potterroemer.com for most current specifications

5020-5030 SERIES Date: 9/25/18



NFPA







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City of Industry, CA 91744 U.S.A. Los Angeles Area 800-366-3473 626-855-4890

Also in: New York (800) 526-4592 Chicago (800) 547-3473 Atlanta (800) 762-0542 Miami (866) 961-3473 Dallas (866) 644-3473

www.potterroemer.com



BELLS PBA-AC & MBA-DC

Features

- · Listed for indoor and outdoor use
- Outdoor use requires BBK-1 or HC-BB weatherproof back box
- · Indoor use mounts directly to standard 4" box
- · Low current draw
- · High dB output
- · AC and DC models
- DC models are motor driven, polarized, and have built in transient protection for supervised alarm circuits
- · Available in 6", 8" and 10" sizes











* ULC on MBA-DC Only

Description

These vibrating type bells are designed for use as fire or general signaling devices. They have low power consumption and high decibel ratings. The unit mounts on a standard 4" (101mm) square electrical box for indoor use or on a model BBK-1 or HC-BB weatherproof backbox for outdoor applications. Weatherproof backbox model BBK-1 or HC-BB, Stock No. 1500001.

Notes

- 1. Minimum dB ratings are calculated from integrated sound pressure measurements made at Underwriters Laboratories as specified in UL Standard 464. UL temperature range is -30° to 150°F (-34° to
- 2. Typical dB ratings are calculated from measurements made with a conventional sound level meter and are indicative of output levels in an actual installation.
- 3. ULC only applies to MBA DC bells.

Size inches (mm)	Voltage	Model Number	Stock Number	Current (Max.)	Typical dB at 10 ft. (3m) (2)	Minimum dB at 10 ft. (3m) (1)	
6 (150)	12VDC	MBA-6-12	1750070	.12A	85	76	
8 (200)	12VDC	MBA-8-12	1750080	.12A	90	77	
10 (250)	12VDC	MBA-10-12	1750060	.12A	92	78	
6 (150)	24VDC	MBA-6-24	1750100	.06A	87	77	
8 (200)	24VDC	MBA-8-24	1750110	.06A	91	79	
10 (250)	24VDC	MBA-10-24	1750090	.06A	94	80	
6 (150)	24VAC	PBA246	1806024*	.17A	91	78	
8 (200)	24VAC	PBA248	1808024*	.17A	94	77	
10 (250)	24VAC	PBA2410	1810024*	.17A	94	78	
6 (150)	120VAC	PBA1206	1806120*	.05A	92	83	
8 (200)	120VAC	PBA1208	1808120*	.05A	99	84	
10 (250)	120VAC	PBA12010	1810120*	.05A	99	86	

All DC bells are polarized and have built-in transient protection. * Does not have ULC listing

Technical Specifications

Dimensions	6" (150mm), 8" (200mm) and 10" (250mm)		
Enclosure	Cover: Steel Finish: Red Powder Coat Base: non-corrosive composite material All parts have corrosion resistant finishes Model BBK-1 or HC-BB weatherproof backbox (optional)		
Voltages Available	24VAC 120VAC 12VDC (10.2 to 15.6) Polarized 24VDC (20.4 to 31.2) Polarized		
Environmental Limitations	Indoor or outdoor use (See Note 1) -40° to 150°F (-40° to 66°C) (Outdoor use requires weatherproof backbox.)		
Termination	AC Bells - 4 No. 18 AWG stranded wires DC Bells - Terminal strip		
Service Use	NFPA 13, 72, local AHJ		

^{*}Specifications subject to change without notice.

AWARNING

- Installation must be performed by qualified personnel and in accordance with all national and local codes and ordinances.
- Shock hazard. Disconnect power source before servicing. Serious injury or death
- Risk of explosion. Not for use in hazardous locations. Serious injury or death could result

A WARNING

In outdoor or wet installations, bell must be mounted with weatherproof backbox, BBK-1 or HC-BB. Standard electrical boxes will not provide a weatherproof enclosure. If the bell and/or assembly is exposed to moisture, it may fail or create an electrical hazard.

Potter Electric Signal Company, LLC • St. Louis, MO Phone: 800-325-3936 www.pottersignal.com

PBA-AC & MBA-DC

Installation

The bell shall be installed in accordance with NFPA 13, 72, or local AHJ. The top of the device shall be no less than 90" AFF and not less than 6" below the ceiling.


- 1. Remove the gong.
- 2. Connect wiring (see Fig. 3).
- 3. Mount bell mechanism to backbox (bell mechanism must be mounted with the striker pointing down).
- Reinstall the gong (be sure that the gong positioning pin, in the mechanism housing, is in the hole in the gong).
- 5. Test all bells for proper operation and observe that they can be heard where required (bells must be heard in all areas as designated by the authority having jurisdiction).

AWARNING

Failure to install striker down will prevent bell from ringing.

Bell Dimension Inches (mm)


Fig 1

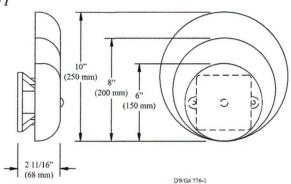

Weatherproof Backbox Dimensions Inches (mm)

MODEL BBK-1 OR HC-BB


Fig 2

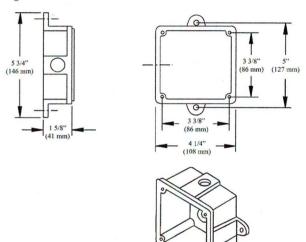

Wiring Rear View

Fig 3

D.C. BELLS (OBSERVE POLARITY)

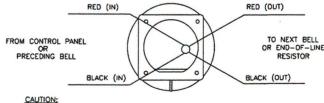


WHEN ELECTRICAL SUPERVISION IS REQUIRED USE IN AND OUT LEADS AS SHOWN,

NOTES:

- 1. OBSERVE POLARITY TO RING D.C. BELLS.
- RED WIRES POSITIVE (+). 3. BLACK WIRES NEGATIVE (-)
- 4. EOL RESISTOR IS SUPPLIED BY FIRE ALARM CONTROL PANEL

A.C. BELLS

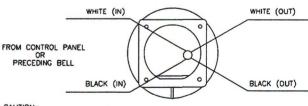

CAUTION:

WHEN ELECTRICAL SUPERVISION IS REQUIRED USE IN AND OUT LEADS AS SHOWN.

NOTES:

- 1. WHEN USING A.C. BELLS, TERMINATE EACH EXTRA WIRE SEPERATELY AFTER LAST BELL.
- 2. END-OF-LINE RESISTOR IS NOT REQUIRED ON AC BELLS

St. Louis, MO Potter Electric Signal Company, LLC . Phone: 800-325-3936 www.pottersignal.com

5400776 - REV Z • 11/17 PAGE 1 OF 2 5400776 - REV Z • 11/17

PAGE 2 OF 2



TECHNICAL DATA

AUTOMATIC DRIP CHECK

The Viking Corporation, 210 N Industrial Park Drive, Hastings MI 49058 Telephone: 269-945-9501 Technical Services 877-384-5464 Fax: 269-818-1680 Email: techsvcs@vikingcorp.com


1. DESCRIPTION

Viking Automatic Drip Checks are designed to drain water automatically, which may leak past a normally closed dry valve or deluge valve. They close, however, against an increase in flow pressure and will open automatically at a predetermined decrease in pressure. The devices are used with dry and deluge valves to drain any water that may seep by the valve clapper.

Model D-1 and D-4 Drip Check is used with a valve that does not have an automatic alarm line drain. It has a notched seat so that a slight amount of water will discharge through the drip check when the valve trips. When the control valve is closed, the alarm line will automatically drain through the drip check. This unit is normally used with the Viking Deluge Valves.

Model D-2 Drip Check is normally used with Viking Model C Dry Valves with iron trim. The drip check has a 3/8" pipe plug installed for use with the Model B-1 Accelerator. When the valve trips, no water will discharge through the drip check. When the control valve is closed and the system is drained, the drip check will open and drain off any excess water in the valve.

Model D-3 Drip Check is used with a Model D, E, or F Dry Valve that has an automatic drain for the alarm line. When the valve trips, no water will discharge through the drip check. When the control valve is closed and the system is drained, the drip check will open and drain off any excess water in the valve.

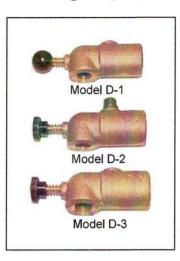

2. LISTINGS AND APPROVALS

Designed to Underwriter's Laboratory and Factory Mutual requirements.

3. TECHNICAL DATA

Specifications

Available since 1980.

Working water pressure: 250 PSI (17.2 bar)

Material Standards

Body: Brass casting UNS-C84400

Ball: Stainless Steel

Spring: Phosphor Bronze

Retaining Ring: Stainless Steel

Model D-4: Electroless Nickel Plated

Ordering Information

Automatic Drip Check, 3/4"

Model D-1 (Deluge & Flow Control Valves): Part Number 10730

Model D-2 (Dry Valve Replacement with Model B-1 Accelerator): Part Number 10731

Model D-3 (Dry Valve): Part Number 10732

Model D-4 (Deluge, Electroless Nickel Plated): Part Number 10733

4. INSTALLATION

- A. Install in outlet provided in valve trim.
- B. Unit should be level.

5. INSPECTIONS. TESTS AND MAINTENANCE

During each inspection of valve, push plunger to make sure no water is trapped.

The Viking Automatic Drip Check is available through a network of domestic and international distributors. See the Viking Corp. Web site for closest distributor or contact The Viking Corporation.

For details of warranty, refer to Viking's current list price schedule or contact Viking directly.

Viking Technical Data may be found on The Viking Corporation's Web site at http://www.vikinggroupinc.com. The Web site may include a more recent edition of this Technical Data Page.

Check Valves 829b February 21, 2013



TECHNICAL DATA

AUTOMATIC BALL DRIP **VALVE (MODEL B-1)**

The Viking Corporation, 210 N Industrial Park Drive, Hastings MI 49058 Telephone: 269-945-9501 Technical Services 877-384-5464 Fax: 269-818-1680 Email: techsvcs@vikingcorp.com

1. DESCRIPTION

The Viking Automatic Ball Drip Valve is designed to drain water automatically which may leak past a normally closed check valve or gate valve. It closes, however, against an increase in flow pressure and will open automatically at a predetermined decrease in pressure. Automatic ball drip valves are used, for example, on the inlet side of fire department check valve or pumper connections to prevent water from collecting and freezing.



2. LISTINGS AND APPROVALS

Designed to Underwriter's Laboratory and Factory Mutual requirements.

3. TECHNICAL DATA

Specifications

Available since 1978.

Working water pressure: 250 PSI (17.2 bar)

Closing pressure: 13.5 PSI (9.3 bar) with increasing pressure Opening pressure: 12.5 PSI (8.6 bar) with decreasing pressure

Material Standards

Bar: Brass UNS-C36000

Spring: Stainless Steel UNS-S30200

Retaining Ring: Stainless Steel UNS-S15700

Ordering Information

Automatic Ball Drip Valve. 1/2" Model B-1: Part Number 04292B

4. INSTALLATION

Install the automatic ball drip in a horizontal position. If desirable, pipe discharge to an open drain. 4" NPT is provided in the drain

NOTE: THIS VALVE IS NOT DESIGNED TO SHUT COMPLETELY AND WILL CONTINUE TO DRIP WHEN PRESSURIZED.

5. INSPECTIONS, TESTS AND MAINTENANCE

The Automatic Ball Drip Valve should be inspected annually.

6. AVAILABILITY

The Viking Automatic Ball Drip Valve is available through a network of domestic and international distributors. See the Viking Corp. Web site for closest distributor or contact The Viking Corporation.

7. GUARANTEES

For details of warranty, refer to Viking's current list price schedule or contact Viking directly.